AGENDA VIRTUAL BIRMINGHAM DESIGN REVIEW BOARD MEETING

Link to Access Virtual Meeting: https://zoom.us/j/97852596256

Telephone Meeting Access: 877-853 -5247

Meeting ID Code: 978 5259 6256

- 1) Roll Call
- 2) Approval of the DRB Minutes of June 3rd, 2020
- 3) Public Hearing
- 4) Design Review
 - A. 470 N. Old Woodward Façade Renovations
 - **B.** 1740 W. Maple Holiday Market Select Façade Renovations
- 5) Sign Review
- 6) Study Session
 - A. Murals & Public Art Sign Ordinance
- 7) Miscellaneous Business and Communication
 - A. Staff Reports
 - 1. Administrative Sign Approvals
 - 2. Administrative Approvals
 - 3. Action List 2020
- 8) Adjournment

<u>Notice:</u> Individuals requiring accommodations, such as interpreter services for effective participation in this meeting should contact the City Clerk's Office at (248) 530-1880 at least on day in advance of the public meeting.

Las personas que requieren alojamiento, tales como servicios de interpretación, la participación efectiva en esta reunión deben ponerse en contacto con la Oficina del Secretario Municipal al (248) 530-1880 por lo menos el día antes de la reunión pública. (Title VI of the Civil Rights Act of 1964).

A PERSON DESIGNATED WITH THE AUTHORITY TO MAKE DECISIONS MUST BE PRESENT AT THE MEETING.

DESIGN REVIEW BOARD MINUTES OF JUNE 3, 2020

Held Remotely Via Zoom And Telephone Access

Minutes of the regular meeting of the Design Review Board ("DRB") held Wednesday, June 3, 2020. Chairman John Henke called the meeting to order at 7:43 p.m.

1) ROLLCALL

Present: Chairman John Henke; Vice-Chairman Keith Dever; Board Members Gigi

Debbrecht, Natalia Dukas (left at 8:00 p.m.), Patricia Lang, Joseph Mercurio,

Michael Willoughby

Absent: Alternate Board Member Alexander Jerome

Administration: Nicholas Dupuis, City Planner

Laura Eichenhorn, Transcriptionist

Chairman Henke thanked everyone for joining the virtual meeting and reviewed protocol for virtual meetings.

06-36-20

2) Approval Of Minutes

Motion by Mr. Willoughby Seconded by Ms. Lang to approve the DRB Minutes of April 15, 2020 and May 20, 2020 as submitted.

Motion carried, 7-0.

VOICE VOTE

Yeas: Willoughby, Lang, Mercurio, Debbrecht, Deyer, Dukas, Henke

Nays: None

06-37-20

3) Public Hearing

None.

06-38-20

4) Design Review

A. 470 N. Old Woodward – Facade Update

Design Review Board Minutes of June 3, 2020

Chairman Henke said he would recommend postponement without penalty of the item since much of the information needed for the review was only supplied by the applicant on the day of the present meeting. He said the DRB needs more time to review the information that was provided and to do its due diligence.

The DRB assured the applicant that there would be no prejudice against the application stemming from the late submittal of some of the review materials. Chairman Henke and other DRB members emphasized that they were understanding of the challenges the applicant was likely encountering as a result of the ongoing Covid-19 pandemic.

City Planner Dupuis reviewed the item.

Mr. Deyer shared concern about the long term maintenance of the proposed planter, and said he would prefer not to approve the proposed planter that would be hanging in the right-of-way.

Chairman Henke reiterated his preference that the majority of the review be postponed for two weeks to provide sufficient time for the DRB to look over the provided materials. He said that if the DRB members wanted to discuss some of the review now that would also be acceptable.

Roman Bonislawski, architect, said they had good luck at Town Tavern in Royal Oak, Michigan with a planter that was ten feet above the sidewalk. He said irrigation was provided and the potato vine that was there remained in excellent condition for its seven year lifetime on the building.

City Planner Dupuis confirmed for Mr. Willoughby that the DRB is empowered by ordinance to approve or deny projections into the right-of-way that are under two feet.

Mr. Willoughby said he would be fine with the projection but that he shared Mr. Deyer's concerns about the planter.

Motion by Mr. Deyer

Seconded by Ms. Lang to postpone the Design Review for 470 N. Old Woodward to the June 17, 2020 DRB meeting.

Motion carried, 6-0.

VOICE VOTE

Yeas: Deyer, Lang, Mercurio, Willoughby, Debbrecht, Henke

Nays: None

06-39-20

5) Sign Review

None.

6) Study Session

A. The Birmingham Plan (2040)

City Planner Dupuis told the DRB members to email him any additional comments they wanted forwarded to the master planning team. He also provided in the evening's agenda the memorandum sent to the master planning team summarizing the DRB's master planning comments thus far.

06-41-20

7) Miscellaneous Business And Communications

- A. Staff Reports
 - 1. Administrative Sign Approvals
 - 2. Administrative Approvals

In reply to a question from Mr. Deyer, City Planner Dupuis explained that the administrative approval granted on May 26, 2020 for the property at 525 Merrill was for a carport and changes to the dumpster enclosure.

3. Action List - 2020

06-42-20

Adjournment

Motion by Ms. Debbrect Seconded by Mr. Mercurio to adjourn the DRB meeting of June 3, 2020 at 8:24 p.m.

Motion carried, 6-0.

VOICE VOTE

Yeas: Debbrecht, Mercurio, Willoughby, Deyer, Henke, Lang

Nays: None

Nicholas Dupuis City Planner



MEMORANDUM

Planning Division

DATE: July 1st, 2020

TO: Design Review Board

FROM: Nicholas Dupuis, City Planner

SUBJECT: 470 N. Old Woodward – Design Review (All Updates in Blue Text)

Zoning: B2 (General Business) & D2 (Downtown Overlay)

Existing Use: 2-Story Commercial Building

Introduction

The applicant is proposing to complete extensive façade renovations to an existing two-story commercial building in Downtown Birmingham. In addition to the Design Standards outlined in Article 7, the applicant will be required to meet the Downtown Overlay Architectural Standards in Article 3, Section 3.04 (E) which state that (among others):

- 1. At least 90% of the exterior finish material on all facades that face a street shall be limited to the following: glass, brick, cut stone, cast stone, coarsely textured stucco, or wood. Dryvit or E.F.I.S is prohibited.
- 2. The primary colors of building exteriors shall be compatible with the colors of adjacent buildings and in character with the surrounding area, although the trim may be of a contrasting color.

Building Exterior

As described above, the applicant is proposing wholesale exterior changes to the existing building façade. The basics of the proposal include the removal of the existing EFIS and stone base, and the addition of new façade materials, new storefront doors, **suspended steel pergola with fabric panels**, metal mesh panels, paint, a parapet extension, and some new rooftop units **with screening**. The following materials are proposed for the project:

New Material (Color)	Location
Shou Sugi Ban Siding (Flame Treated Wood)	North, West, South Upper Facades
Honed Granite (Black)	North, West, South Bases
Painted Steel Rail (Southern Vine)	West Elevation Along Sidewalk
Rusted Steel Faced Door (Rust)	Center of West Elevation for Vacant Space
Painted Steel Planters (Carolina Gull)	West Elevation between 1 st & 2 nd Floor
Metal Mesh Panels (Metallic Steel)	North & South Elevation
Parapet Cap (Dark Bronze)	Top of Extended Parapet
Boston Ivy (Natural)	South Facade
Concrete Steps (Unpainted)	West Elevation on North Side of Building
Sealed Rusted Steel Shaft (Rust)	West Elevation Center, partial 1 st & full 2 nd Floor

The applicant's proposal to utilize exclusively wood, stone and metal in the façade renovation meets the façade material requirements outlined above for the Downtown Overlay. Additionally, the proposed color scheme is compatible with the colors of adjacent buildings and in character with the surrounding area. The building directly to the north contains much of the same style of material such as wood and aged bronze in a darker color scheme, while the buildings further south on the block follow the same modern design. The proposal does not necessarily compliment the vacant Junior League of Birmingham building directly adjacent to the south, but it could be considered an outlier.

The plans submitted show a "rework of dark bronze and clear insulated glass storefront," which suggests that there may be a removal or replacement of glass, notwithstanding the obvious new wood entry door for the vacant tenant space. However, due to the relocation of the door on the north end of the west elevation, it is apparent that new glass will indeed need to be installed at least in that location. Additionally, the proposal *appears* to maintain adherence to the glazing requirements outlined in the Zoning Ordinance, which requires no less than 70% of a storefront/ground floor façade between 1 and 8 feet above grade to be clear glazing. However, the applicant has not submitted glazing calculations that consider the newly proposed non-glass entry door nor specifications on new glass to ensure clear glazing. In summation, the applicant must submit material specifications for all new glass to ensure a visual light transmittance of at least 80%, as well as glazing calculations showing storefront glazing at a minimum of 70%.

The applicant has submitted specifications for the new glass panel, as well as glazing calculations showing 76.7% glazing on the first floor, meeting the requirements.

As mentioned above, the applicant is also proposing a new exhaust fan and make up air unit on the rooftop of the building. To minimize the visual impact of such equipment from other points of observation, rooftop mechanical and other equipment are required to be obscured by a screenwall composed of materials compatible with the building or by landscaping demonstrated to provide an effective permanent visual barrier. The elevation drawings show the new rooftop units (RTUs) almost entirely visible from all facades even with the small extension of the parapet wall in the front of the building. Additionally, the applicant has not submitted any specification sheets on the proposed RTUs to ensure that they will be screened from public view. Thus, the applicant must provide specification sheets on all proposed RTUs and provide adequate screening for such.

The applicant has submitted revised elevation drawings showing an MDO screenwall surrounding the RTU's, and has proposed it to be painted to match the building.

Signage

The elevation plans submitted do not show any new signage. However, a note exists on page A201 that states "new dimensional letters suspended from soffit above." Although no signage is shown on the plan, it is imperative to state that all signage is required to be placed on the buildings sign band, with only a couple of exceptions. In any event, all signage for new or existing tenants must be approved by the Planning Division, Design Review Board or Planning Board (Special Land Use Permit) before it may be installed on the new building façade.

Lighting

There is a bit of a discrepancy on the plans in regards to lighting. The building plan on sheet A101 notes 18 surface mounted low intensity LED lights underneath the suspended steel planter, while the elevation drawings on sheet A201 note 8 LED exposed accent lights underneath the suspended steel planter. The applicant has not submitted specification sheets on the new lights, nor have they submitted a photometric plan to ensure that the light levels at the property lines meet the requirements of Article 4, Section 4.21 of the Zoning Ordinance. The applicant must clarify the amount on new light fixtures proposed underneath the suspended steel planter, submit specification sheets on all new fixtures, and provide a photometric plan showing illuminance levels at all property lines all to ensure conformance with Article 4, Section 4.21 of the Zoning Ordinance.

The applicant is no longer proposing any new light fixtures, therefore no specification sheets or photometric plans are required.

Planning and Zoning

There are two aspects of the proposal that relate to general planning and zoning issues on site. The first issue is the extension of the existing solid waste enclosure in the rear of the building. The proposed site plan (Sheet A001) notes that the extended screening will be comprised of a wood slat gate and screen to match the existing mechanical enclosure. Article 4, Section 4.54 (B)(8) requires trash enclosures to be comprised of a masonry screenwall with wood gates. The screenwall shall match the material of the principal building. The proposal appears to propose a portion of wood slat screenwall that does not meet the Zoning Ordinance, as a masonry screenwall is required. The applicant must revise the site plans to propose a screening extension of masonry with wood gates to match the material of the principal building.

The applicant has submitted revised site plans that show a screenwall extension of concrete block and a wood gate.

The second issue is in regards to the suspended steel planter and its extension into the right-of-way. Article 4, Section 4.74 (D) requires approval from the Planning Board, Design Review Board and/or Historic District Commission for all removable architectural elements such as awnings, canopies, or marquees that project into the right of way provided that they are constructed to support applicable loads without any ground mounted supports on public property. The Design Review Board should discuss the suspended steel planter and either allow the projection into the right-of-way, or require the applicant to reduce the size to fit within the boundaries of the property.

Although the design has changed from a planter to a steel pergola with fabric panels, the Design Review Board should still discuss the suspended steel pergola and either allow the projection into the right-of-way, or require the applicant to reduce the size to fit within the boundaries of the property.

Design Recommendation

When reviewing the project against the standards of Article 7, Section 7.09 of the City of Birmingham Zoning Ordinance, staff makes the following observations:

- All of the materials required by this section have been submitted for review.
 - The applicant has submitted all required application materials.

- 2. All provisions of this Zoning Ordinance have been complied with.
 - The applicant has fully complied with the Zoning Ordinance.
- 3. The appearance, color, texture and materials being used will preserve property values in the immediate neighborhood and will not adversely affect any property values.
 - The proposed improvements to the building will not likely adversely affect property values.
- 4. The appearance of the building exterior will not detract from the general harmony of and is compatible with other buildings already existing in the immediate neighborhood.
 - The overall design elements proposed does not appear to detract from the general harmony of the existing buildings in the neighborhood, and is compatible with Downtown Birmingham.
- 5. The appearance of the building exterior will not be garish or otherwise offensive to the sense of sight.
 - It does not appear that the proposed design elements are garish or otherwise offensive to the sense of sight.
- 6. The appearance of the building exterior will tend to minimize or prevent discordant and unsightly properties in the City.
 - The proposed improvements to the exterior of the building are not unsightly nor discordant.
- 7. The total design, including but not limited to colors and materials of all walls, screens, towers, openings, windows, lighting and signs, as well as treatment to be utilized in concealing any exposed mechanical and electrical equipment, is compatible with the intent of the urban design plan or such future modifications of that plan as may be approved by the City Commission.
 - It appears as though the design elements proposed are compatible with the intent of the urban design plan.

Recommendation

The Planning Division recommends that the Design Review Board APPROVE the Design Review application for 470 N. Old Woodward with the following conditions:

1. The Design Review Board approves the suspended steel pergola to project into the right-of-way.

Sample Motion Language

Motion to APPROVE the Design Review application for 470 N. Old Woodward with the following conditions:

1. The Design Review Board approves the suspended steel pergola to project into the right-of-way.

OR


Motion to **POSTPONE** the Design Review application for 470 N. Old Woodward pending receipt of the following:

1.	
2.	

3.	

OR

Motion to $\bf DENY$ the Design Review application for 470 N. Old Woodward; the proposal does not meet the requirements of Article 7, Section 7.09 of the Zoning Ordinance.

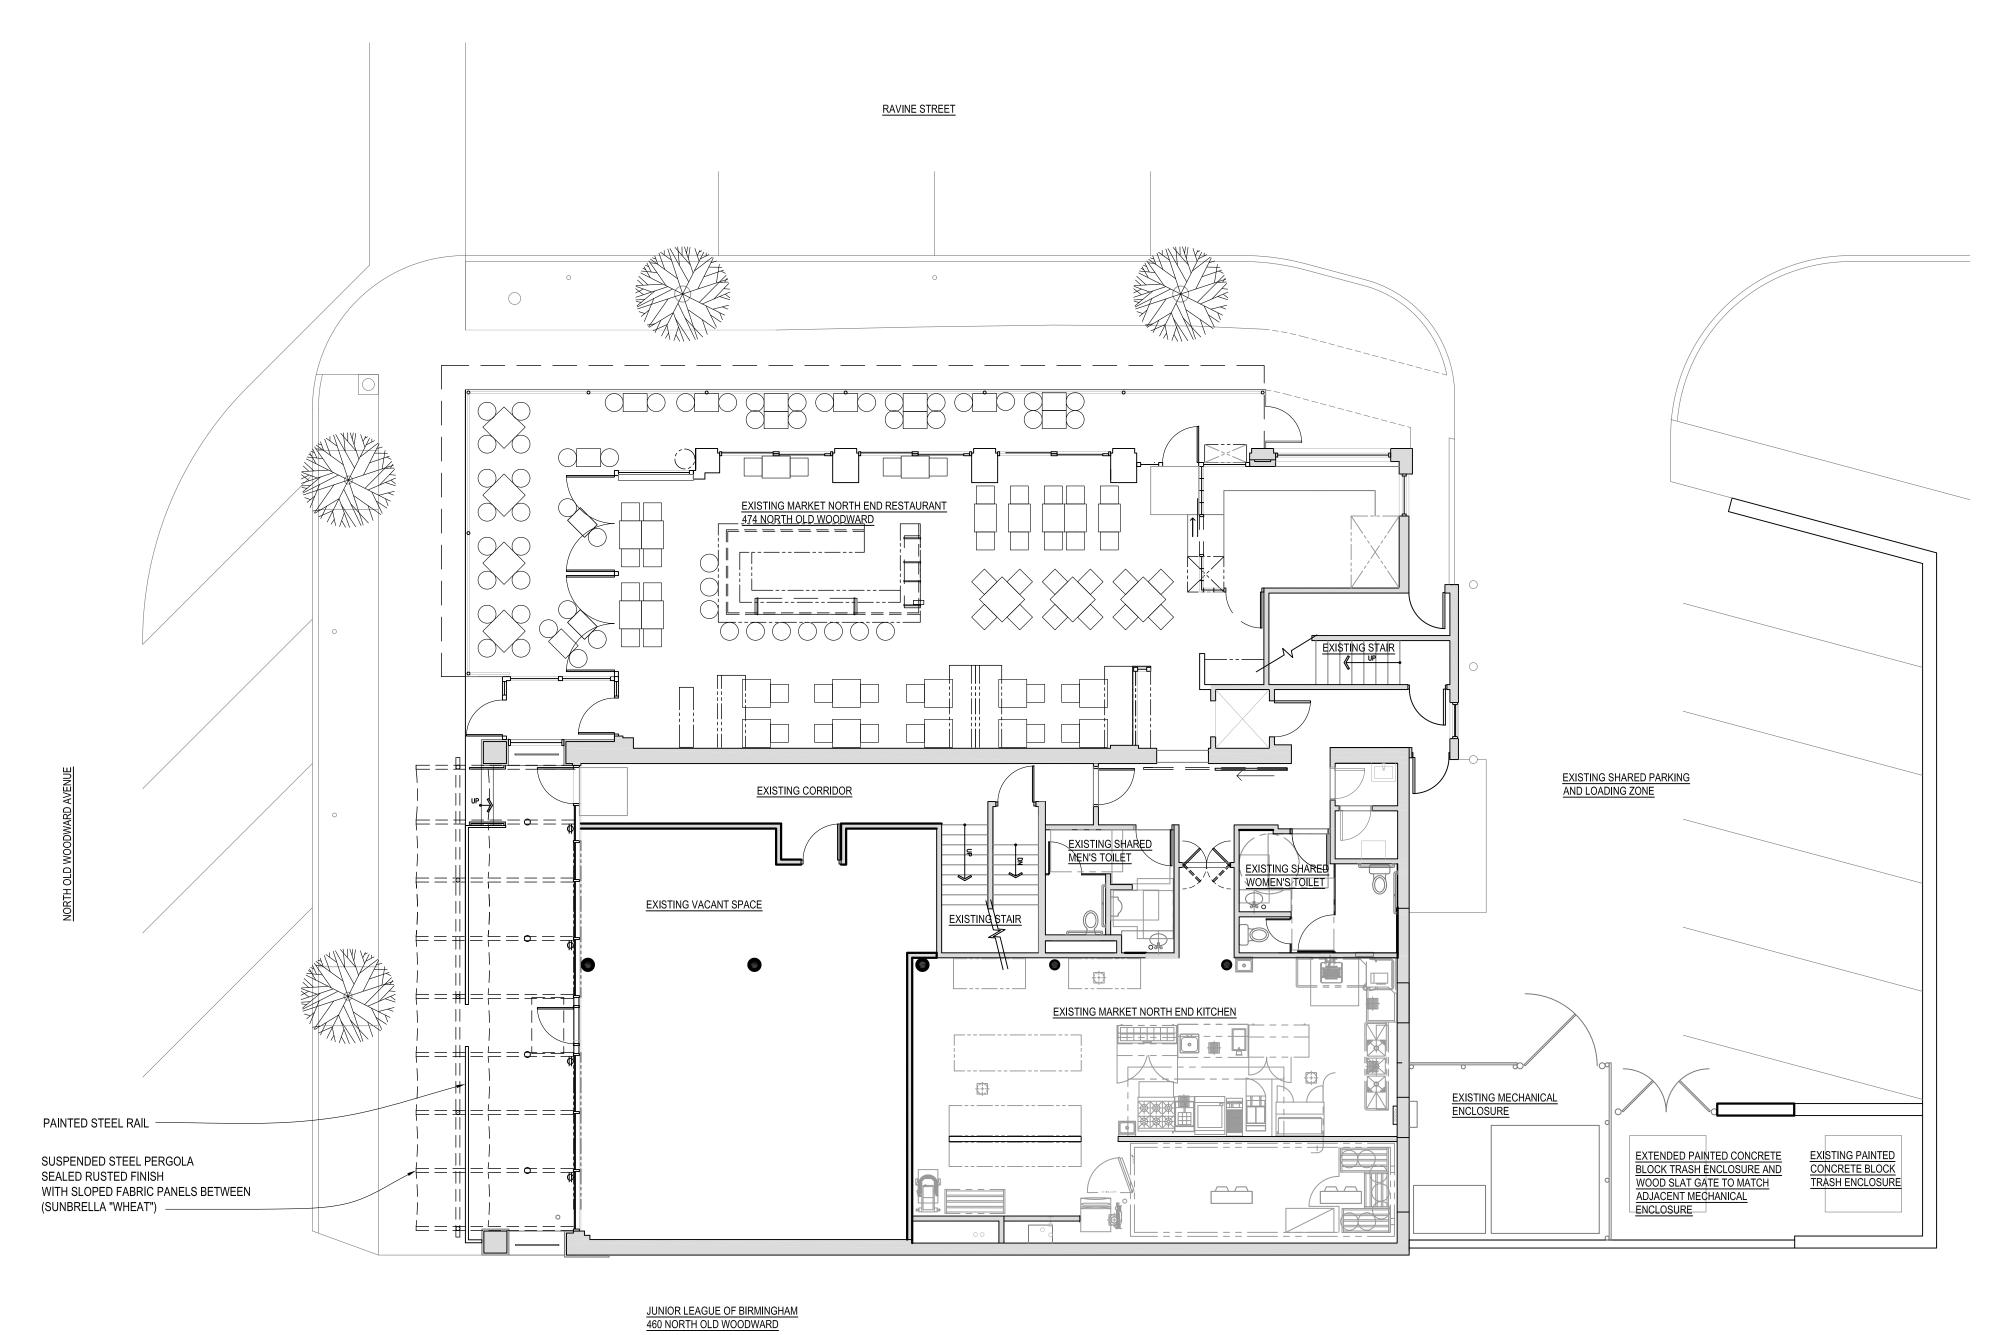

SINGLE FAMILY RESIDENCE 180 FERNDALE STREET

Issue Date: REVIEW 01.08.2020 03.20.2020 REVIEW DRB APPLICATION 04.16.2020 REVISION 06.03.2020 06.17.2020 REVISION

Z

Project:

Sheet Title:


Proposed Site Plan


Sheet Number:

A001

Site Plan

scale: 1/8" = 1'-0"

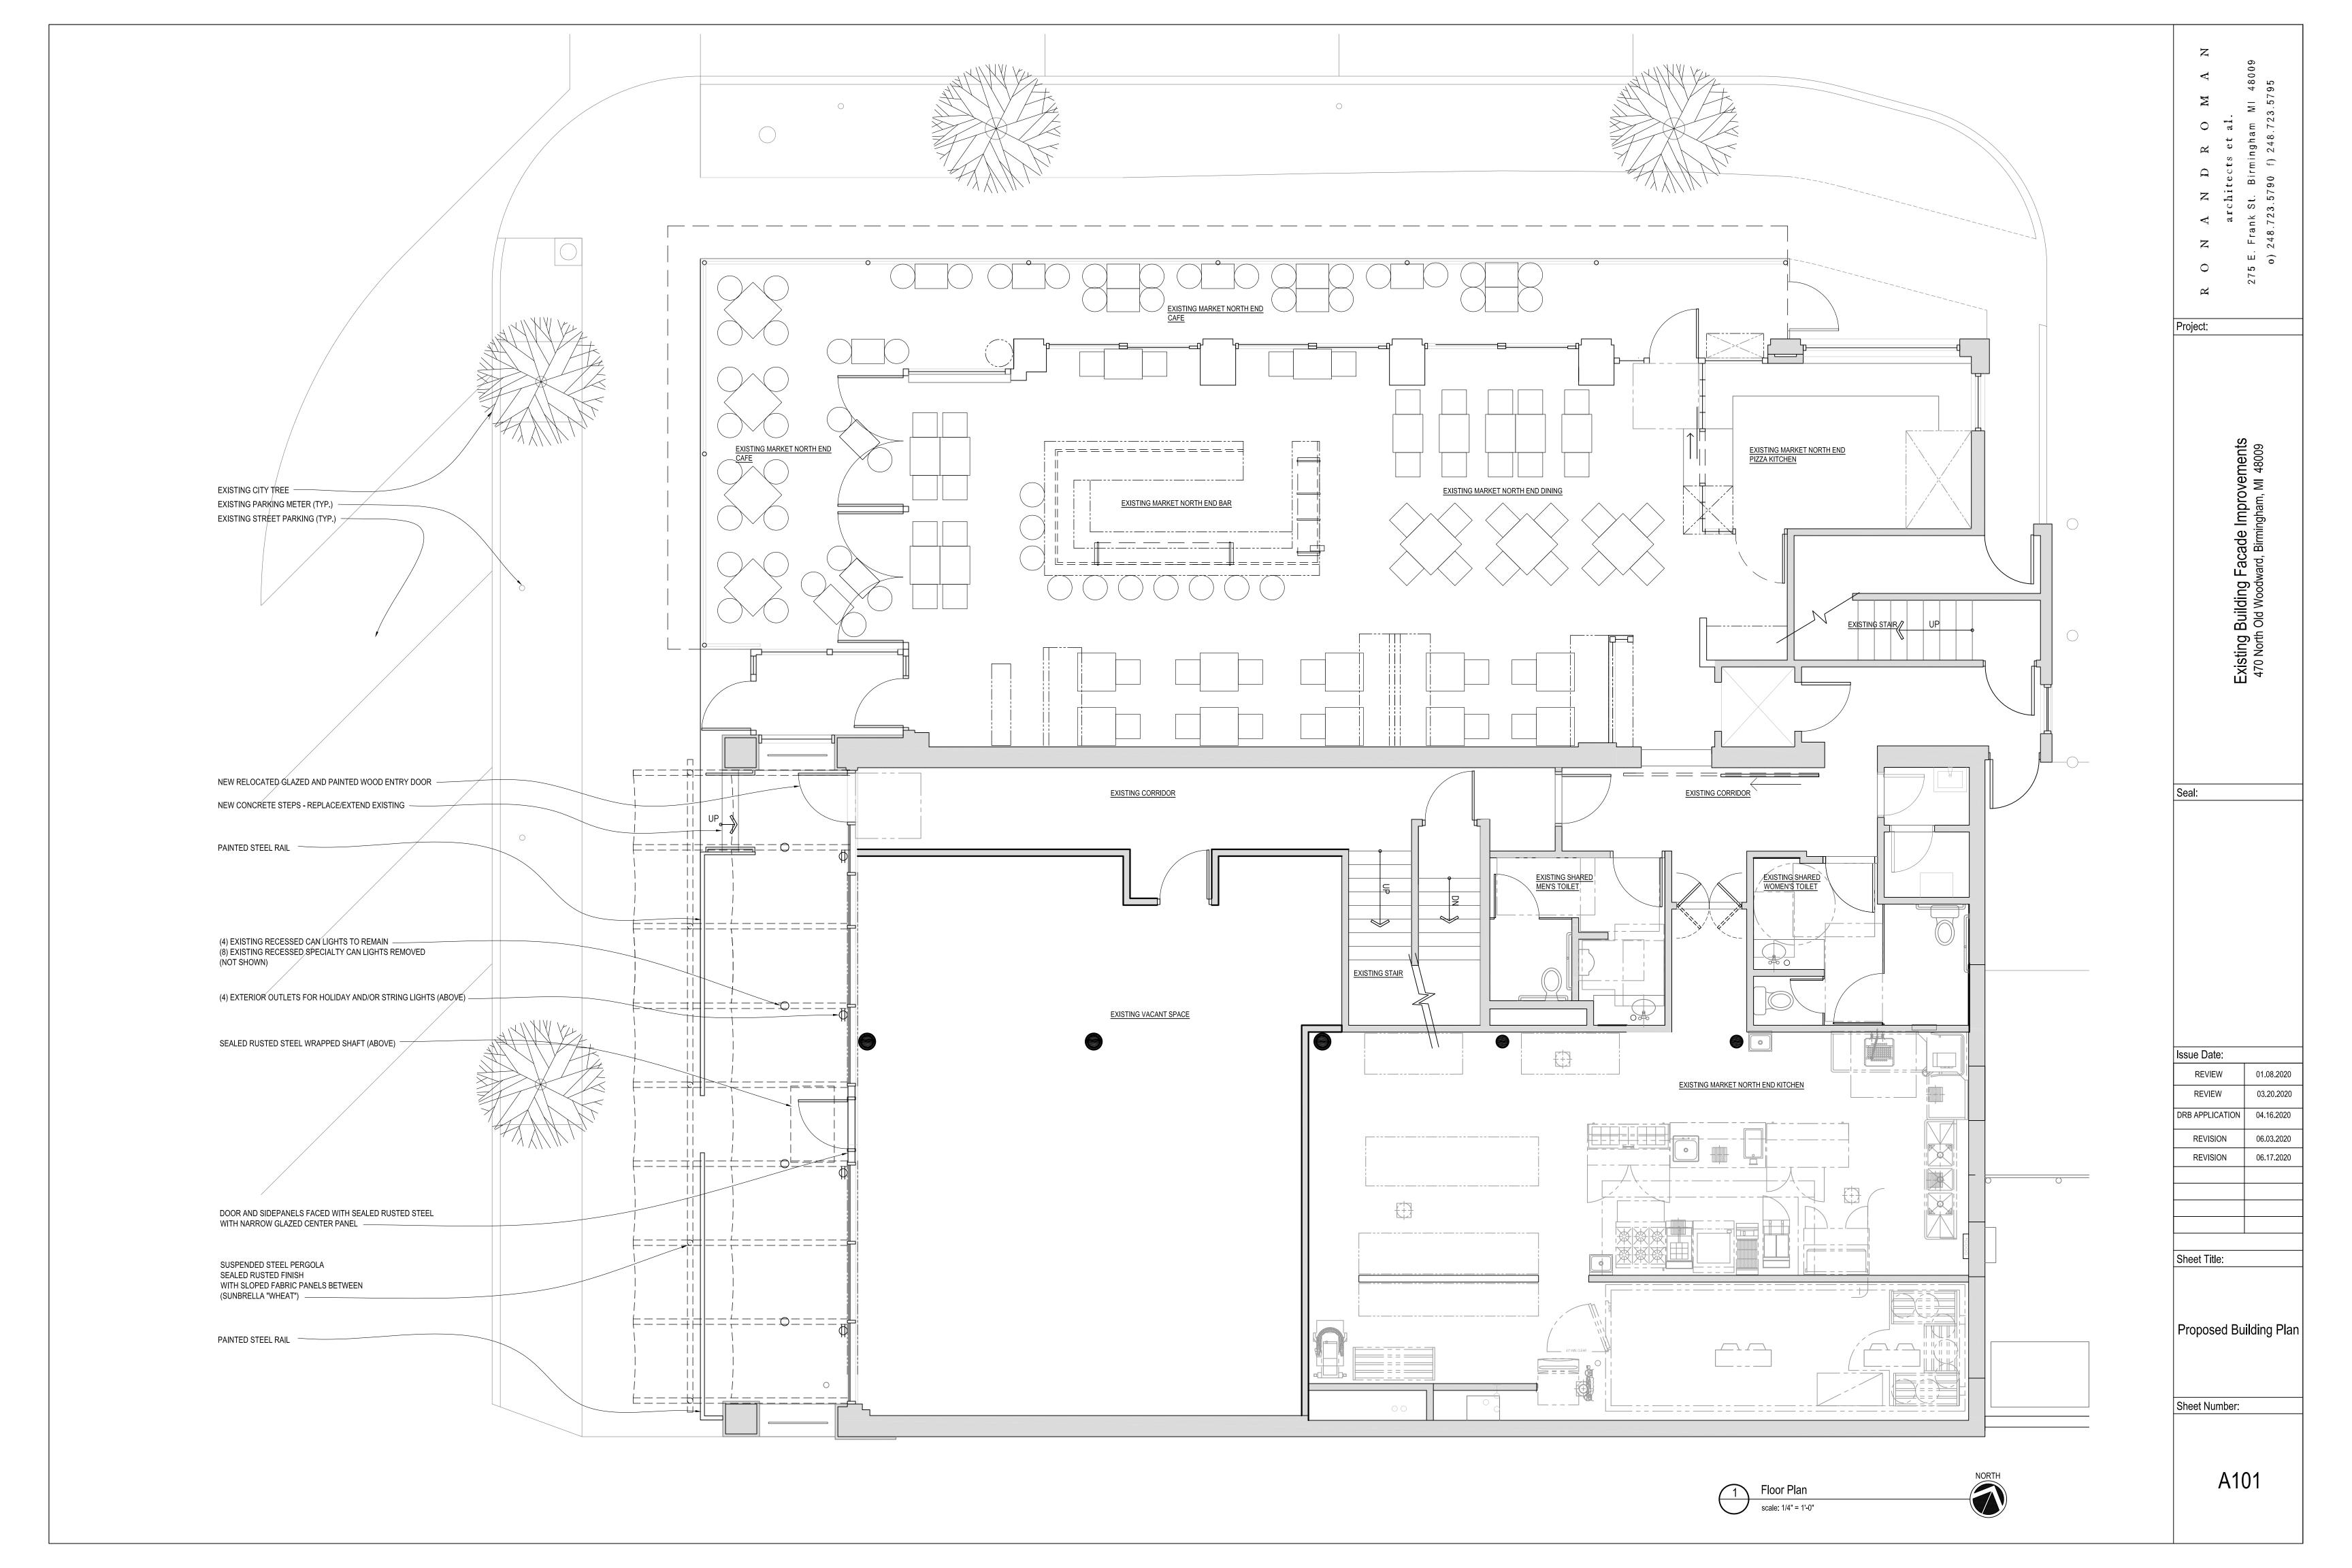

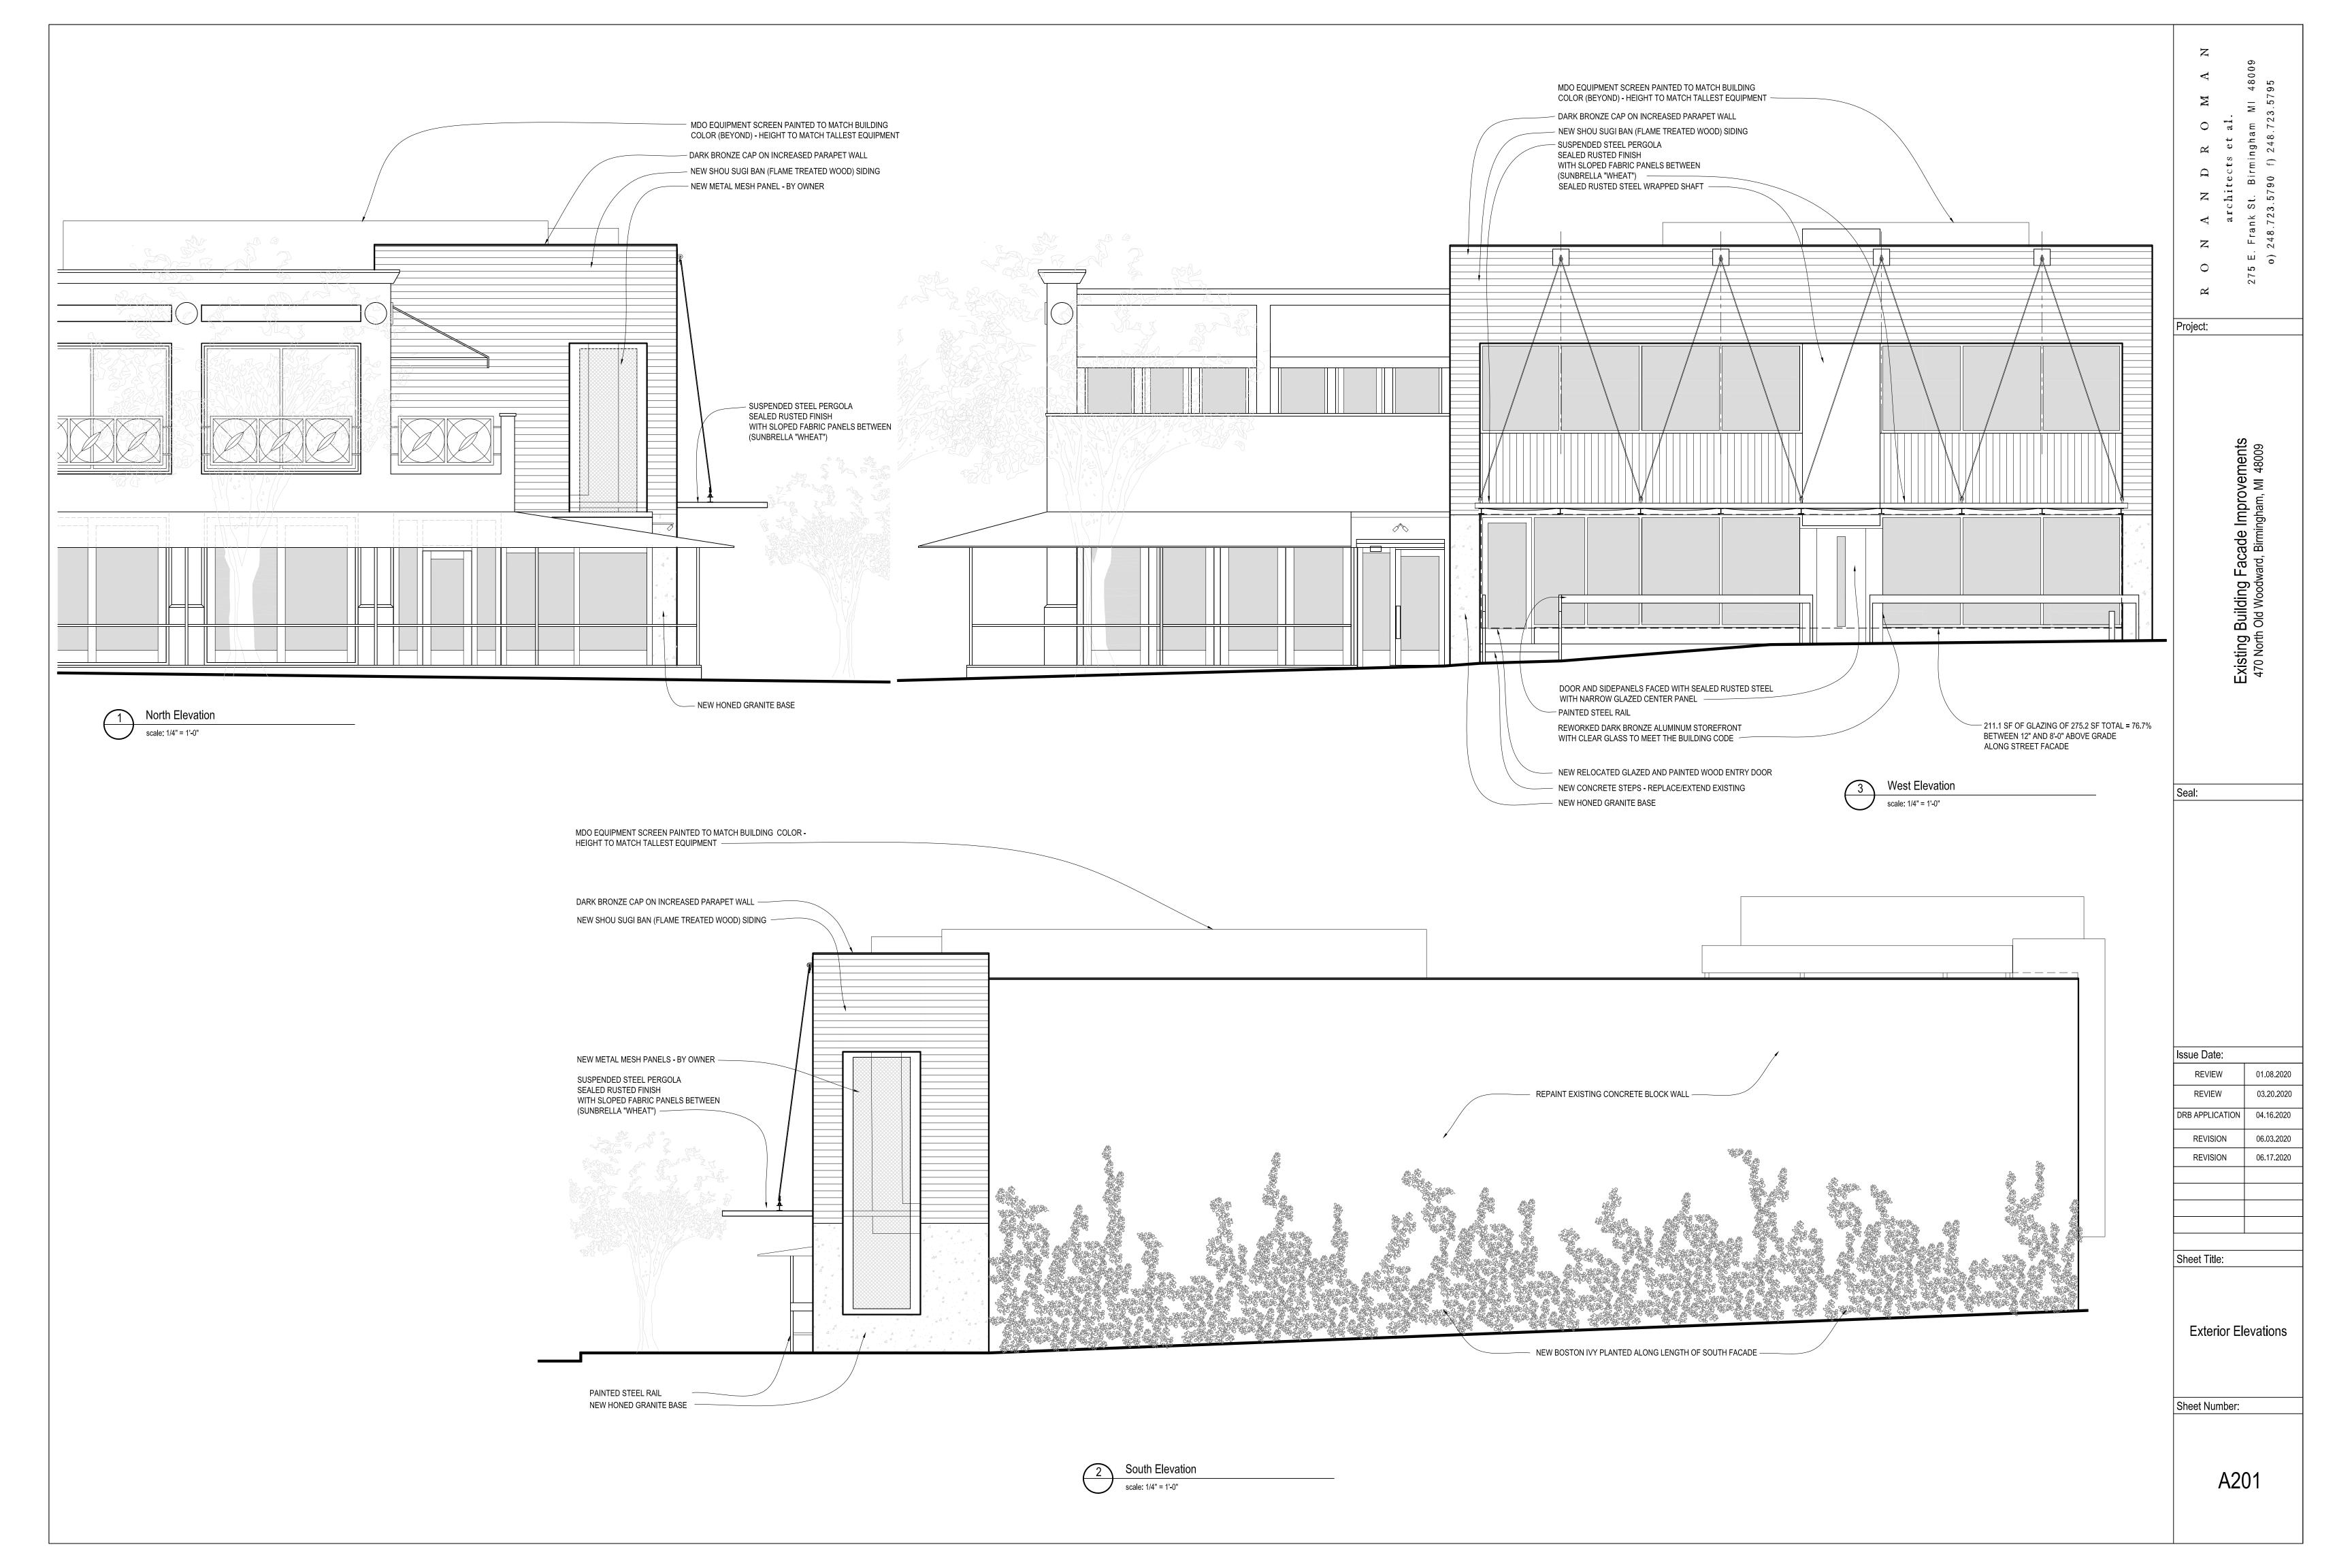

 (4) EXISTING RECESSED CAN LIGHTS TO REMAIN
 (8) EXISTING RECESSED SPECIALTY CAN LIGHTS REMOVED (NOT SHOWN)

NEW BRONZE CAP ON INCREASED PARAPET WALL

- NEW SHOU SUGI BAN (FLAME TREATED WOOD) SIDING

 NEW METAL MESH PANELS - BY OWNER SEALED RUSTED STEEL WRAPPED SHAFT SUSPENDED STEEL PERGOLA SEALED RUSTED FINISH WITH SLOPED FABRIC PANELS BETWEEN (SUNBRELLA "WHEAT")

- DOOR AND SIDEPANELS FACED WITH SEALED RUSTED STEEL WITH NARROW GLAZED CENTER PANEL

— REWORKED DARK BRONZE ALUMINUM STOREFRONT WITH CLEAR GLASS TO MEET THE BUILDING CODE

— PAINTED STEEL RAIL

- NEW HONED GRANITE BASE

NEW GLAZED AND PAINTED WOOD SHARED ENTRY DOOR -

Looking North from Old Woodward



- NEW BRONZE CAP & EXTENDED FASCIA ON INCREASED NEW SHOU SUGI BAN (FLAME TREATED WOOD) SIDING

(4) EXISTING RECESSED CAN LIGHTS TO REMAIN (8) EXISTING RECESSED SPECIALTY CAN LIGHTS REMOVED

_ SEALED RUSTED STEEL WRAPPED SHAFT - SUSPENDED STEEL PERGOLA SEALED RUSTED FINISH WITH SLOPED FABRIC PANELS BETWEEN (SUNBRELLA "WHEAT")

DOOR AND SIDEPANELS FACED WITH SEALED RUSTED STEEL
 WITH NARROW GLAZED CENTER PANEL

— REWORKED DARK BRONZE ALUMINUM STOREFRONT WITH CLEAR GLASS TO MEET THE BUILDING CODE



Looking South from Old Woodward

NEW CONCRETE STEPS - REPLACE/EXTEND EXISTING

- PAINTED STEEL RAIL

- NEW HONED GRANITE BASE

Project:


Issue Date: REVIEW 01.08.2020 03.20.2020 REVIEW DRB APPLICATION 04.16.2020 REVISION 06.17.2020

Sheet Title:

Exterior Renderings

Sheet Number:

A202

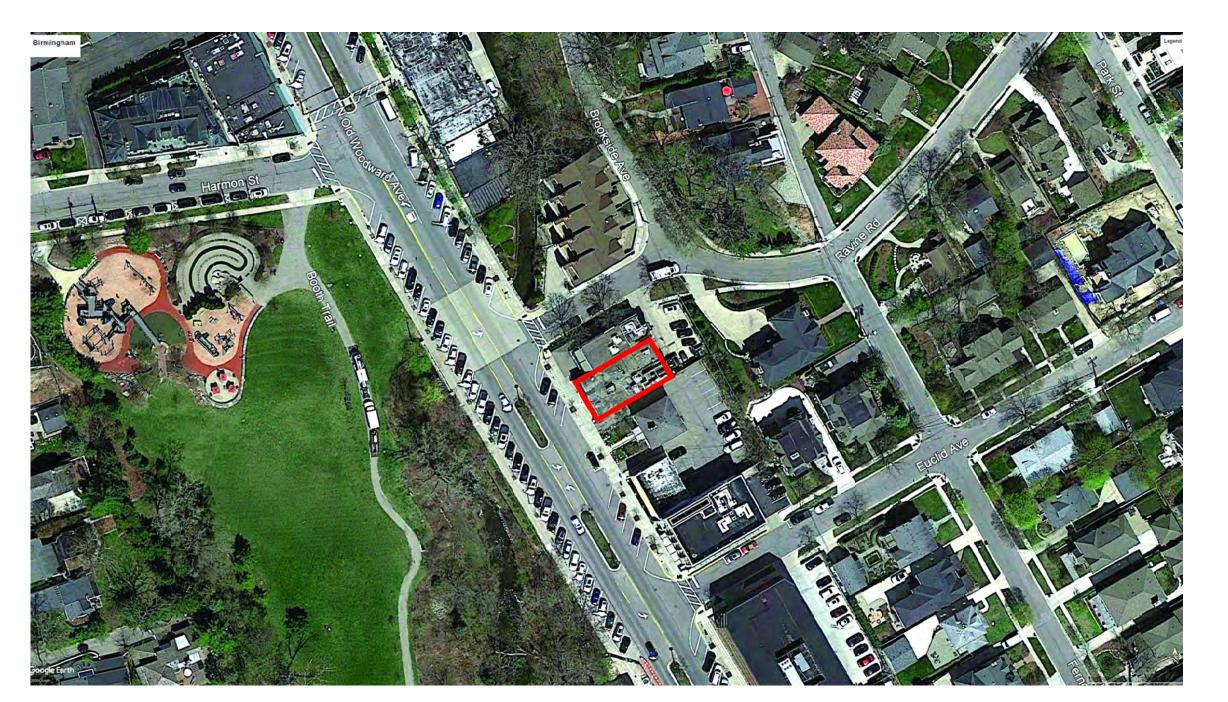

Aerial View of Adjacent Properties



Old Woodward Ave. Street View Looking Northeast



Ravine Road Street View Looking Southeast

N A N D R O M A architects et al. Frank St. Birmingham MI 4800

Proiec

ints

Existing Building Facade Improvements 470 North Old Woodward, Birmingham, MI 48009

eal:

Sheet Title:

Aerial & Street Views

Sheet Number:

A301

FAN #1 ADM2-D.250-G15-MPU - HEATER (MARKET 2.0)

FAN #1 ADM2-D.250-GIS-MPU - HEATER (MARKET 2.0)

1. DIRECT GAS FIRED HEATED MAKE UP AIR UNIT WITH 15' BLOWER

2. INTAKE HODD WITH EZ FILTERS

3. SIDE DISCHARGE - AIR FLOW RIGHT -> LEFT

4. LIDW FIRE START. ALLOWS THE BURNER CIRCUIT TO ENERGIZE WHEN THE MODULATION CONTROL IS IN A LOW FIRE POSITION.

5. GAS PRESSURE GAUGE, 0-35', 2.5' DIAMETER, 1/4' THREAD SIZE


7. 7.5 TON, DUAL CIRCUIT (25/5) MODULAR PACKAGED COOLING POTION FOR SIZE 2 DF/EH MODULAR PACKAGED UNIT. INCLUDES CONDENSER, DX COIL, FILTER/DIFFER KIT, THERMAL EXPANSION VALVE, R410A REFRIGERANT, AND REFRIGERANT PIPING. (2,700 TO 4,500 CFM) NOT BUILT WITH DPPOSITE SIDE CONTROLS OR DPPOSITE AIRFLOW DIRECTION. COINDENSERS REQUIRE SEPARATE 208V, 3 PHASE POWER SUPPLY UNLESS ORDERED WITH SINGLE POINT CONNECTION. COIL = 3EZIIOIC


8. DX COOLING INTAKE AIR THERMOSTAT AND RELAYS MOUNTED IN UNIT - SET POINT FOR THERMOSTAT SHOULD BE 85'F.


*NOTE: SUPPLY DUCT MUST BE INSTALLED TO MEET SMACNA STANDARDS. A MINIMUM STRAIGHT DUCT LENGTH MUST BE MAINTAINED DDWNSTREAM OF UNIT DISCHARGE AS DUTLINED IN AMCA PUBLICATION 201. DO NOT RELY ON UNIT TO SUPPORT DUCT IN ANY WAY. FAILURE TO PROPERLY SIZE DUCTWORK MAY CAUSE SYSTEM EFFECTS AND REDUCE PERFORMANCE OF THE EQUIPMENT. SUGGESTED STRAIGHT DUCT SIZE IS 20' × 20'



WINTER TEMPERATURE = -10°F. TEMP. RISE = 80°F. BTUS CALCULATED DFF ACTUAL AIR DENSITY OUTPUT BIUS AT ALITITUDE OF 0.0 ft. = 2232940 INPUT BTUS AT ALITITUDE OF 0.0 ft. = 533195 OUTPUT BIUS AT ALITITUDE OF 623 ft. = 227743 INPUT BTUS AT ALITITUDE OF 623 ft. = 247547

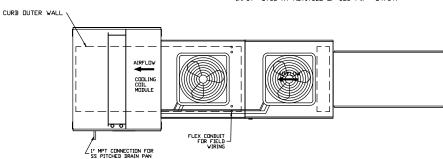

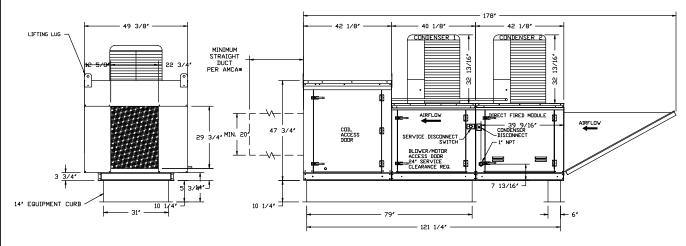

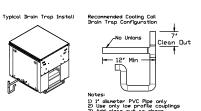








<i>JOB</i> Market 2.0	
LOCATION REDFORD, MI,	
<i>DATE</i> 2/4/2020	<i>JOB #</i> 4211764
DWG # 7	<i>DRAWN BY</i> Janet En
REV.	SCALE 1/4" = 1'-0"

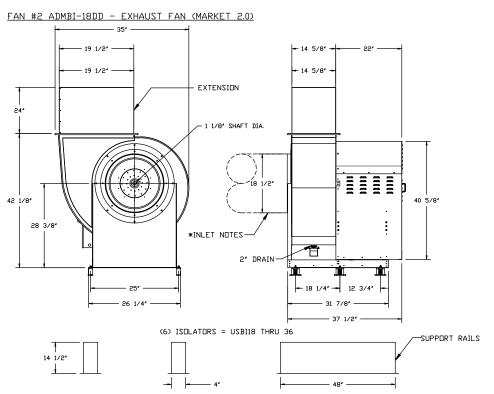

UNTIL ALL FAN PARTS HAVE REACHED THERMAL EQUILIBRIUM, AND WITHOUT ANY DETERIORATING EFFECTS TO THE FAN WHICH WOULD CAUSE UNSAFE OPERATION.

NORMAL TEMPERATURE TEST DIRECT DRIVE EXHAUST FAN MUST OPERATE CONTINUOUSLY WHILE EXHAUSTING AIR AT 350°F (176°C) ** INLET NOTES: LENGTH OF THE STRAIGHT DUCT ON THE INLET TO BE 3 TIMES THE EQUIVALENT DUCT DIAMETER BEFORE CONNECTING TO ANY FITTINGS SUCH AS ELBOWS TO AVOID SYSTEM EFFECT.

FEATURES:

- ROOF MOUNTED FANS
- UL705
- UL762 AND ULC-S645 (RESTAURANT MODEL)
- HIGH HEAT OPERATION DIRECT DRIVE 350°F (176°C)
- HIGH HEAT OPERATION BELT DRIVE 350°F (176°C)
- HEAT SLINGER
- WEATHERPROOF DISCONNECT
- GREASE CLASSIFICATION TESTING
- 2" DRAIN
- MOTOR WEATHER COVER
- FULLY SEALED SCROLL HOUSING
- SCROLL ACCESS DOOR
- FLANGE 1 1/4" 11 THRU 20.
- FLANGE 2" 24 THRU 36.

DPTIONS

UTILITY SET GREASE CUP. BI18 - 24" DISCHARGE EXTENSION. BI - DISCHARGE ORIENTATION VERTICAL UPPER LEFT - CW INLET SIDE. BI18 - INLET RING USED TO CONNECT NON-FACTORY DUCT. UTILITY SET - SPRING VIBRATION ISOLATORS - BI18 / EQUIVALENT SIZED UTILITY SET - INDOOR/OUTDOOR USE.



A.D.M. Air Control

<i>JOB</i> Market 2.0		
LOCATION REDFORD, MI,		
<i>DATE</i> 2/4/2020	JOB #	4211764
<i>DWG</i> # 9	DRAWN	<i>BY</i> Janet Eng
REV.	SCALE	3/8" = 1'-0"

New Project 354

		Visible Light			Ultra	Ultraviolet Solar Energy								herma operti		Links		Soun	Outd oor /	
Make-up Name	Tran smitt ance	Refle	ctance	Color Renderi	Trans	Tdw (T.	Tran smitt ance	Refle	ctance	Abso rptan ce	Solar Heat Gain	Shadin g	Relativ e Heat	U-V	alue	e Winter	Light to Solar Gain (LSG	al Stress (COG)	Tran	Indo or Tran smis
	Visible (τ _V %)	ρ _V % out	ρ _V % in	ng Index (R _a)	%)	IV (τ _{uv} (T _{dw} %)	Solar (τ _e %)	ρ _e % out	ρ _e % in	Solar (α _e %)	Coeffici ent (SHGC)	Coeffici ent (sc)	Gain (RHG)	Winter Night (Btu/hr.f t².F)	Summe r Day (Btu/hr-f t²-F)	Night (hr-ft²-F/ Btu))	`°F/C	Class (STC)	Class (OIT C)
Existing Glass (Assumed)	68	11	12	95.4	30	56	33	33	36	34	0.38	0.43	90	0.29	0.28	3.42	1.80	Go	34	29
Zoning Compliant Glass	80	15	15	96.9	51	72	67	13	13	20	0.74	0.85	178	0.47	0.50	2.11	1.09	Go	34	29
alculation Sta	andard:	NFRC	2010																	
xisting Gla	ss (As	ssume	ed)																	
									Οu	ıtdoor	s									
GLASS 1			(North / = 1/4" (6		1)						 SunGu	ard® S	N 68 (N	lorth Ar	nerica)					
GAP 1		100)% Air, 1	/2" (12	.7mm)															
GLASS 2			(North A		1)															
	Tota	l Unit (l	Nominal) = 1 in						Slo	pe = 90)°			Windo	w Heig	ght = 1 i	meter	_	
	Estin	nated N	Nominal	Glazin	g Weigl	nt: 5.75	lb/ft²													
									In	doors	8									
oning Com	pliant	Glass	3																	
									Ou	ıtdoor	 S									
GI ASS 4	Clea	r Float	(North A	America	1)															
Thickness = 1/4" (6mm) #2																				
GAP 1	GAP 1 100% Air, 1/2" (12.7mm)																			
GLASS 2	Clear Float (North America) #3 Thickness = 1/4" (6mm) #4																			
		•	Nominal	•						Slo	pe = 90)°			Windo	w Heig	ght = 1 i	meter		
	Estin	nated N	Nominal	Glazin	g Weigl	nt: 5.75	lb/ft²													
									In	doors	3									

Important Notes

Calculations and terms in this report are based on NFRC 2010. The performance values shown above represent nominal values for the center of glass with no spacer system or framing.

Laminated products:

It is not guaranteed that modeled laminated configurations will be compliant with relevant laminated safety regulations unless specifically declared for Guardian products. It is the user's sole responsibility to assess if the final laminated product should be



certified according to relevant standards and ensure compliance with laminated safety regulations.

Additional consequences for laminated glass with coating facing interlayer (due to contact between coating and interlayer) may include (not limited to): significant decrease of safety performance for some coating and interlayer combinations; loss of thermal insulation performance of surface facing the interlayer; noticeable color change; other performance deterioration.

Non-specular products (translucent or diffuse):

The performance measurement for non-specular (translucent or diffuse) materials such as translucent interlayers or acid etched glass surface, or surface with ceramic frit is limited by the current experimental technologies. Since measurements capture physically only a part of the resulting radiation, calculated performance results provided herein and based on such measurements are not compliant with any standard (including EN 410) and may only be used as a general reference. Actual values may vary significantly based upon exact fabrication process, as well as type, thickness and color of used non-specular material.

Please note that the Thermal Stress Guideline is only a general guide to the thermal safety of a glazing, and it is not a replacement for detailed thermal stress analysis.

Explanation of Terms

- Visible Light Transmittance (Tv, %) is the percentage of incident light in the wavelength range of 380 nm to 780 nm that is transmitted by the glass.
- **Ultraviolet (UV) Transmittance (Tuv, %)** is the percentage of the incident solar radiation transmitted by the glazing in the 300 nm to 380 nm range.
- **Solar Energy Direct Transmittance (Te, %)** is the percentage of incident solar energy in the wavelength range of 300 nm to 2500 nm that is directly transmitted by the glass.
- Visible Light Reflectance Outdoors/Indoor (Rv out/in, %) is the percentage of incident visible light directly reflected by the glass.
- Solar Direct Reflectance Outdoors/Indoors (Re out/in, %) is the percentage of incident solar energy directly reflected by the glass.
- Solar Energy Absorptance (Ae, %) is the percentage of the sun's energy that is absorbed by glass.
- **U-Value** is the glazing parameter that characterizes the heat transfer through the central part of the glazing, i.e. without edge effects, and expresses the steady-state density of heat transfer rate per temperature difference between the environmental temperatures on each side. US Standard units are Btu/hr-ft²-F and SI / Metric units are W/m² K.
- **Relative Heat Gain (RHG)** is the total net heat gain to the indoors due to both the air-to-air thermal conductance and the solar heat gain. US Standard units are Btu/hr.ft² and SI / Metric units are W/m².
- **Shading Coefficient (sc)** is Solar Factor divided by 0.87. It is a measure of the solar heat gain referenced to 3 mm clear glass which has the designated value of 1.00.
- **Solar Heat Gain Coefficient (SHGC)** is the sum of the solar direct transmittance and the secondary heat transfer factor of the glazing towards the inside, the latter resulting from heat transfer by convection and longwave IR-radiation of that part of the incident solar radiation which has been absorbed by the glazing.
- Light-to-Solar Gain (LSG) is the ratio of visible light gain to solar gain. LSG = (Visible Transmittance) / (SHGC)
- Color Rendering Index in transmission, D65 (R_a) is the change in color of an object as a result of the light being transmitted by the glass.
- **Weighted Sound Reduction Index (Rw)** is a single-number quantity which characterizes the airborne sound insulation of a material or building element over a range of frequencies.
- **Sound Transmission Class (STC)** is a single-number quantity which characterizes the airborne sound insulation of a material or building element over a range of frequencies.

Disclaimer

This performance analysis is provided for the limited purpose of assisting the user in evaluating the performance of the glass products identified on this report.

Spectral data for products manufactured by Guardian reflect nominal values derived from typical production samples or CE Initial Type Testing and subject to variations due to manufacturing and calculation tolerances. Spectral data for products not manufactured by Guardian were derived from the LBNL International Glazing Database and have not been independently verified by Guardian.



Guardian recommends a full-size mock-up be approved.

The values provided herein are generated according to established engineering practices and applicable calculation standards. Many factors may affect glazing characteristics, including glass size, building orientation, shading, wind speed, type of installation, production process and others. The applicability and results of the analysis are directly related to user inputs and any changes in actual conditions can have a significant effect on the results. It is the responsibility of the users of the analysis to ensure that the intended application is appropriate and complies with all relevant laws, regulations, standards, codes of practices, processing guidelines and other requirements. Guardian makes no guarantee that any glazing modeled herein is available from Guardian or any other manufacturer. The user has the responsibility to check with the manufacturer regarding availability of any glass type or make-up.

While Guardian has made a good faith effort to verify the reliability of the tools used for this analysis, they may contain unknown programming errors that could result in inaccurate results. The user assumes all risk relating to the results provided and is solely responsible for selection of appropriate products for user's application. Guardian makes no express or implied warranty of any kind with respect to the tools used by Guardian and this analysis. There are no warranties of merchantability, non-infringement or fitness for a particular purpose with respect to the tools used by Guardian and this analysis and no warranty shall be implied by operation of law or otherwise. The only warranties applicable to Guardian products are those separately provided in writing for each product. In no event shall Guardian be liable for direct, indirect, special, consequential or incidental damages of any kind relating to or resulting from use of Guardian tools and analyses.

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Program Version: 4.1.0.8678 Database Version: 20200601

R O N A N D R O M A N

MEMORANDUM

To: Nicholas Dupuis, City Planner Address:

Planning Department City of Birmingham ss: 151 Martin St. Birmingham, MI 48009

From: Ron and Roman Date: June 19, 2020

Re: 470 North Old Woodward Avenue, Façade Improvements

Mr. Dupuis,

In response to your review dated June 3, 2020 and the comments of the board attendees at the June 3, 2020 meeting, we are submitting attached revised drawings A001, A101, A201, and A202 as well as a revised material/finish sample board to specifically address the concerns regarding the suspended planter, as well as some additional changes to coordinate with the new pergola that replaces the planter element. Please note the following modifications on the attached drawings to the previously submitted proposal:

- 1. Suspended planter has been removed in its entirety and replaced with a suspended steel framed pergola with a sealed, rusted finish with fabric panels between the framing members that project out over the public sidewalk.
- 2. Fabric panels proposed to be Sunbrella "Wheat" color.
- 3. Cladding on the shaft enclosure has been modified to a sealed, rusted steel.
- 4. New door has been modified to a sealed, rusted steel finish as well similar to the shaft enclosure and the pergola framing above.
- 5. Proposed lights have been omitted from the proposal, and existing recessed lights in the overhead shall be utilized. Additionally, (4) four exterior outlets are proposed to accommodate festoon lighting.

Thank you, Darrell J. Dinges Ron and Roman

Attachments:

Revised sheets A001, A101, A201, A202 Revised material finish sample board



Final Site Plan & Design Review Application Planning Division

Form will not be processed until it is completely filled out.

1	Name: ZERO NINE TWO SIX LLC Address: 470 North Old Woodward	2.	Property Owner Name: LPH Ventures IV, LLC
	Birmingham, MI 48009		Address: 2 Corporate Drive, Suite 300
	Phone Number:		Southfield, MI 48076
	Fax Number		Phone Number: 248-613-0300
	Fax Number:		Fax Number: 248-226-1607
	Email address:		Email address: Thomas.Lasky@colliers.com
3.	Applicant's Attorney/Contact Person Name:	4.	Project Designer/Developer Name: Ron And Roman
	Address:		Address: 275 East Frank Street
	w/ Copy to Thomas Lasky, 2 Corporate Drive, Ste 300, Southfield, MI 48076		Birmingham, MI 48009
	Phone Number:		Phone Number: 248-723-5790
	i ax i vuitoci.		Fax Number:
	Email address:		Email address: Darrell@ronandroman.com
5	Required Attachments		
	I. Two (2) paper copies and one (1) digital copy of all project plans including: i. A detailed Existing Conditions Plan including the subject site in its entirety, including all property lines, buildings, structures, curb cuts, sidewalks, drives, ramps and all parking on site and on the street(s) adjacent to the site, and must show the same detail for all adjacent properties within 200 ft. of the subject sites property lines; ii. A detailed and scaled Site Plan depicting accurately and in detail the proposed construction, alteration or repair; iii. A certified Land Survey; iv. Interior floor plans;		v. A Landscape Plan; vi. A Photometric Plan; vii. Colored elevation drawings for each building elevation; II. Specification sheets for all proposed materials, light fixtures and mechanical equipment; III. Samples of all proposed materials; IV. Photographs of existing conditions on the site including all structures, parking areas, landscaping and adjacent structures; V. Current aerial photographs of the site and surrounding properties; VI. Warranty Deed, or Consent of Property Owner if applicant is not the owner; VII. Any other data requested by the Planning Board, Planning Department, or other City Departments.
	Project Information Address/Location of the property: 470 North Old Woodward, Birmingham, MI 48009 Name of development: Existing Building "Park View" Sidwell #: 1925330001 Current Use: Mixed Use: Salon, Pilates Studio, Kitchen for Restaurant, Proposed Use: Same - potential restaurant in Vacancy Area of Site in Acres: Current zoning: B-2, D-2 Overlay Is the property located in the floodplain?	I I I I V	Date of Application for Preliminary Site Plan: Date of Preliminary Site Plan Approval: Date of Application for Final Site Plan: Date of Final Site Plan Approval: Date of Application for Revised Final Site Plan: Date of Revised Final Site Plan Approval: Date of Design Review Board Approval: Vill proposed project require the division of platted lots?
	Name of Historic District Site is Located in: Date of Historic District Commission Approval:	V	Vill proposed project require the combination of platted lots?

	Proposed improvements to exterior of existing building at Tenant's cost per agreement with concludes replacement of existing EIFS on Old Woodward façade with flame tre									
	suspended planter on stainless steel cables, removal of existing stone base (re									
	Rework existing dark bronze storefront to relocate main entrance door, provide new wood entrance door to vacant space, and allow for potential									
	ductwork to rooftop within copper clad enclosure. Please see architectural elevations and color renderings for annotation of proposed work.									
	Increase parapet wall approximately 1'-0" along North Old Woodward façade a									
	increase parapet was approximately 1-5 along total or visouwald layade a	and wrapping north and south lacates - as shown on attached drawings.								
Q	Buildings and Structures									
U.	Number of Buildings on Site: Two	Use of Buildings: Mixed Use								
	Height of Buildings & # of Stories: 2 Stories, varies with grade 25'-	Height of Rooftop Mechanical Equipment: TBD								
	Height of Buildings & # of Stories, 2 delice, failed war grade 20	Height of Roottop Mechanical Equipment; 180								
۵	Floor Use and Area (in Square Feet)									
J.	rioui Ose aliu Alea (ili Squale Feet)									
	Proposed Commercial Structures:									
	Total basement floor area: No new space proposed	Office Canasi								
	Total basement floor area: No new space proposed Number of square feet per upper floor:	Office Space:								
	Lotal Hoose among	Retail Space:								
	Floor area ratio (total floor area ÷ total land area):	Industrial Space:								
	1 1001 area ratio (total 11001 area - total failu area).	Assembly Space:								
	Omen chace:	Seating Capacity:								
	Open space: Percent of open space:	Maximum Occupancy Load:								
	retent of open space.									
	Brancad Besidential Street									
	Proposed Residential Structures:	2.78 5 5 5 5								
	Total number of units: None Number of one bedroom units:	Rental units or condominiums?								
	Number of one bedroom units:	Size of one bedroom units:								
	Number of two bedroom units:	Size of two bedroom units:								
	Number of three bedroom units:	Size of three bedroom units:								
	Open space: Percent of open space:	Seating Capacity:								
	Percent of open space:	Maximum Occupancy Load:								
	Proposed Additions:									
	Total basement floor area, if any, of addition: None	Use of addition:								
	Number of floors to be added: None	Height of addition:								
	Square lootage added per floor:	Office space in addition:								
	Total building floor area (including addition):	Retail space in addition: Industrial space in addition:								
	Floor area ratio (total floor area ÷ total land area):	Industrial space in addition:								
		Assembly space in addition:								
	Open Space:	Maximum building occupancy load (including addition):								
	Percent of open space:									
10.	Required and Proposed Setbacks	Market State Control of the Control								
	Required front setback:0	Proposed front setback: no change								
	Required rear setback: Alley Plus 10'	Proposed rear setback no change								
	Required total side setback:0	Proposed total side setback: no change								
	Side setback:0	Second side setback; no change								
11.	Required and Proposed Parking									
	Required number of parking spaces: 0 - Downtown Overlay District	Proposed number of parking spaces: 5								
	Typical angle of parking spaces:	Typical size of parking spaces: 8'-6" x 19'-0"								
	Typical width of maneuvering lanes:	Number of spaces <180 sq. ft.:5								
	Location of parking on site: Existing Spaces in Rear									
	Location of parking off site: On Street Parking	Number of handicap spaces:								
	Number of light standards in parking area: Building Mounted Lights	Shared parking agreement?								
	Screenwall material: Painted Concrete Block (Existing)	Height of light standards in parking area:								


Location of landscape areas: Suspended Continuous Planter above street facade	Proposed landscape material: Coleus or other consistent leafy green plant in suspended planter			
South Façade	Boston lvy (non-damaging) on south facade			
2 Chroates and				
3. Streetscape				
Sidewalk width: Existing to Remain at 7'-0"	Description of benches or planters:			
Number of benches:				
Number of planters:	Species of existing trees:			
Number of existing street trees: One at 470, three at 474 (includes to				
Number of proposed street trees:	Species of proposed trees:			
Streetscape Plan submitted?				
4. Loading	180			
Required number of loading spaces: Existing	Proposed number of loading spaces: One			
Typical angle of loading spaces: Screenwall material: Painted Concrete Block	Typical size of loading spaces:			
Screenwall material: Painted Concrete Block	Height of screenwall: Varies (Existing Screenwall)			
Location of loading spaces on site: Rear Parking	Typical time loading spaces are used: Early Morning			
E Enterior Marcola D				
5. Exterior Waste Receptacles				
Required number of waste receptacles: One	Proposed number of waste receptacles: Two			
Location of waste receptacles: Rear Parking Lot	Size of waste receptacles: 6 yard dumpster			
Screenwall material: Painted Concrete Block and Stained Wood Gates	Height of screenwall: 6'-0" height minimum to match dumpste			
Utilities and Transformers: Number of ground mounted transformers: No Change Proposed Size of transformers (L•W•H):	Location of all utilities & easements:			
Number of utility easements.				
Screenwall material:	Height of screenwall:			
Ground Mounted Mechanical Equipment:				
Number of ground mounted units: No Change Proposed	Logotion of all			
Size of ground mounted units (I. • W• H).	Location of all ground mounted units:			
Screenwall material:	Height of screenwall:			
Rooftop Mechanical Equipment:				
Number of rooftop units: No Change Proposed				
Type of roofton unite:	Location of all rooftop units:			
Type of rooftop units:	Size of rooftop units (L•W•H):			
Screenwall motorial Existing EIFO	Percentage of rooftop covered by mechanical units:			
Screenwall material: Existing EIFS - any new required shall match exist Location of screenwall:	Height of screenwall: To match any new equipment height			
If necessary West continue of the continue of	Distance from rooftop units to all screenwalls:			
If necessary, West section of existing roof, recessed from existing parapet				
Accessory Buildings				
Number of accessory buildings: None				
Location of accessory buildings; None	Size of accessory buildings:			
Location of accessory buildings:	Height of accessory buildings:			
Building Lighting				
Number of light standards on build	_			
Number of light standards on building:	Type of light standards on building:			
ALCE OF HOME INCHESO (LAWALI).				
Size of light fixtures (L•W•H):	Height from grade:			

NAME OF TAXABLE PARTY.	
Maximum wattage per fixture:	Proposed wattage per fixture:
Light level at each property line:	
19. Site Lighting	
Number of light fixtures: 18 proposed under planter canopy	Type of light fixtures: LED low intensity
Size of light fixtures (L-W-H): recessed with lamp exposed	Height from grade: varies approximately 8'-0" to 9'-0" above grade
Maximum wattage per fixture:	Proposed wattage per fixture: LED 25watt equivalent
Light level at each property line:	Holiday tree lighting receptacles:
20. Adjacent Properties	
Number of properties within 200 ft.: 5	
Property #1	
Number of buildings on site: One	Property Description: 460 North Old Woodward - Junior League
Zoning district: B-2, D-2	
Use type: Office	
Square footage of principal building:	
Square lootage of accessory buildings:	
Number of parking spaces:	North, south, east or west of property? South
	rozul, south, east of west of property?
Property #2	
Number of buildings on site: One	Property Description: 450 North Old Woodward - Offices
Zoning district: B-2, D-2	rioperty Description, 100 to 1
Use type: Office	
Square footage of principal building:	
Square footage of accessory buildings:	
Number of parking spaces:	North, south, east or west of property? South
	riorus, souns, cast of west of property?
Property #3	
Number of buildings on site: One	Property Description: 501-541 Brookside
/ Inning / Increict: 10-2	Troperty Description.
Use type: Residential	
Square footage of principal building:	
Square footage of accessory buildings:	
Number of parking spaces:	North, south, east or west of property? North
	room, soun, east of west of property?
Property #4	
Number of buildings on site: One	Property Description: 180 Ravine - Single Family Home
Zoning district: R-2	
Use type: Residential	
Square footage of principal building:	
Square footage of accessory buildings:	
Number of parking spaces:	North, south, east or west of property? East
	rest of property?
Property #5	
Number of buildings on site:	Property Description: 475 North Old Woodward - Booth Park
Zoning district: PP	Topoli Joseph Million Control of the
Zoning district: PP Use type: Public Park	
Square tootage of principal building:	
Square 100tage of accessory buildings.	
Number of parking spaces:	North, south, east or west of property?
	rotal, sound, cast of west of property?
Property #6	
Number of buildings on site:	Property Description:
Zonnig district:	Pricy 2-0001 photos,
Out if put	
Square footage of principal building:	
Square 100tage of accessory buildings:	
Number of parking spaces:	North south east or west of
	North, south, east or west of property?

The undersigned states the above information is true and correct, and understands that it is the responsibility of the applicant to advise the Planning Division and / or Building Division of any additional changes made to an approved site plan. The undersigned further states that they have reviewed the procedures and guidelines for Site Plan Review in Birmingham, and have complied with same. The undersigned will be in attendance at the Planning Board meeting when this application will be discussed.

Signature of Owner:	momy	Date: 4.21.20
Print Name: Thomas L	asky, Authorized Age	
Signature of Applicant:	R	Date: 4/24/20
Print Name: 10 % PM	Provisionaly	
Signature of Architect:		Date: 04.17.2020
Print Name: Roman B	onislawski	
	Office Use Only	
Application #:	Date Received:	Fee:
Date of Approval:	Data of Daniel	A

ay

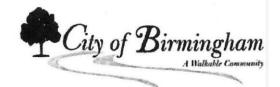


FINAL SITE PLAN & DESIGN REVIEW APPLICATION CHECKLIST - PLANNING DIVISION Applicant: ZERO NINE TWO SIX, LLC Case #: Date: Address: 470 N. Old Woodward Project: Façade Improvements on Existing Buil All site plans and elevation drawings prepared for approval shall be prepared in accordance with the following specifications and other applicable requirements of the City of Birmingham. If more than one page is used, each page shall be numbered sequentially. All plans must be legible and of sufficient quality to provide for quality reproduction or recording. Plans must be no larger than 24" x 36", and must be folded and stapled together. The address of the site must be clearly noted on all plans and supporting documentation. **Final Site Plan** A full Site Plan detailing the proposed changes for which approval is requested shall be drawn at a scale no smaller than 1" = 100' (unless the drawing will not fit on one 24" X 36" sheet) and shall include: Name and address of applicant and proof of ownership; 2. Name of Development (if applicable); Address of site and legal description of the real estate; 4. Name and address of the land surveyor; 5. Legend and notes, including a graphic scale, north point, and date: 6. A separate location map: 7. A map showing the boundary lines of adjacent land and the existing zoning of the area proposed to be developed as well as the adjacent land; 8. Aerial photographs of the subject site and surrounding properties: 9. A detailed and scaled Site Plan depicting accurately and in detail the proposed construction, alteration or repair; 10. A detailed Existing Conditions Plan including the subject site in its entirety, including all property lines, buildings, structures, curb cuts, sidewalks, drives, ramps and all parking on site and on the street(s) adjacent to the site, and must show the same detail for all adjacent properties within 200 ft. of the subject site's property lines; 11. Interior floor plans;

12. A chart indicating the dates of any previous approvals by the Planning Board, Board of Zoning Appeals,

Design Review Board, or the Historic District Commission ("HDC");

~	13	. Existing and proposed layout of streets, open space and other basic elements of the plan;
V	14	. Existing and proposed utilities and easements and their purpose;
V	15	Location of natural streams, regulated drains, 100-year flood plains, floodway, water courses, marshes, wooded areas, isolated preserve-able trees, wetlands, historic features, existing structures, dry wells, utility lines, fire hydrants and any other significant feature(s) that may influence the design of the development;
V	16	. General description, location, and types of structures on site;
~	17	Location of sidewalks, curb cuts, and parking lots on subject site and all sites within 200 ft. of the property line;
~	18	Details of existing or proposed lighting, signage and other pertinent development features;
~	19	Elevation drawings showing proposed design;
V	20	Screening to be utilized in concealing any exposed mechanical or electrical equipment and all trash receptacle areas;
~	21.	Location of all exterior lighting fixtures;
	22.	A Photometric Plan depicting proposed illuminance levels at all property lines;
V	23.	A Landscape Plan showing all existing and proposed planting and screening materials, including the number, size, and type of plantings proposed and the method of irrigation; and
	24.	Any other information requested in writing by the Planning Division, the Planning Board, or the Building Official deemed important to the development.
Elevation	n Dr	awings
Complete smaller th	ele an l	vation drawings detailing the proposed changes for which approval is requested shall be drawn at a scale no "= 100' (unless the drawing will not fit on one 24" X 36" sheet) and shall include:
V	25.	Color elevation drawings showing the proposed design for each façade of the building;
V	26.	List of all materials to be used for the building, marked on the elevation drawings;
V	27.	Elevation drawings of all screenwalls to be utilized in concealing any exposed mechanical or electrical equipment, trash receptacle areas and parking areas;
V	28.	Details of existing or proposed lighting, signage and other pertinent development features;
V		A list of any requested design changes;
V	30.	Itemized list and specification sheets of all materials, light fixtures, and mechanical equipment to be used, including exact size specifications, color, style, and the name of the manufacturer;
	31.	Location of all exterior lighting fixtures, exact size specifications, color, style and the name of the manufacturer of all fixtures, and a photometric analysis of all exterior lighting fixtures showing light levels to all property lines; and
	32.	Any other information requested in writing by the Planning Division, the Planning Board, or the Building Official deemed important to the development.

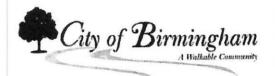

Notice Signs - Rental Application Community Development

1. Applicant		rioperty Owner		
Name: ZERO NINE TWO SIX LLC		Name: LPH Ventures IV, LLC		
Address: 470 North Old Woodward		Address: 2 Corporate Drive, Suite 300		
Birmingham, MI 48009		Southfield, MI 48076		
Phone Number:		Phone Number: 248-613-0300		
Fax Number:		Fax Number: 248-226-1607		
Email address:	to be a second or the second or the second of the second o	Email address: Thomas.Lasky@colliers.com		
2. Project Information				
Address/Location of Property: 470 North C	Old Woodward	Name of Historic District site is in, if any:		
Name of Development: Existing Park View Building		Current Use: Mixed Use		
Area in Acres: Current Zoning: B-2, D-2		Current Zoning: B-2, D-2		
3. Date of Board Review				
		Board of Zoning Appeals:		
Board of Building Trades Appeals:	The state of the s	Design Review Board:		
City Commission:		Housing Board of Appeals:		
Planning Board:		Trousing Board of Appeals.		
project will be reviewed by the remains posted during the enti pay a rental fee and security de immediately following the date will be refunded when the Notice	appropriate board or re 15 day mandatory eposit for the Notice S of the hearing at whice ce Sign(s) are returne	n(s) at least 15 days prior to the date on commission, and to ensure that the Not posting period. The undersigned furthe sign(s), and to remove all such signs on the project was reviewed. The securid undamaged to the Community Develo	ice Sign(s) r agrees to the day ity deposit pment	
Department. Failure to return t	the Notice Sign(s) and	l/or damage to the Notice Sign(s) will re	44 9	
forfeiture of the security depos			suit in	
			sult in	
Signature of Applicant:		Date: 04.17.2020		
Signature of Applicant:		Date: 04.17.2020	-	
		Ise Only	-	
Signature of Applicant: Application #:	Office U	Ise Only	- -	



MEMORANDUM

Planning Division

DATE: July 1st, 2020

TO: Design Review Board

FROM: Nicholas Dupuis, City Planner

SUBJECT: 1740 W. Maple – Holiday Market Select – Design Review

Zoning: B1 (Neighborhood Business)

Existing Use: Two, One-Story Commercial Buildings

Introduction

The applicant is proposing to complete façade renovations to two existing one-story commercial buildings in the neighborhood commercial center at Maple and Chesterfield. The renovations come as a part of an expansion of Holiday Market Select into an adjacent tenant space (formerly Level One Bank). The renovations intend to continue the façade design of the current Holiday Market Select to create one contiguous storefront.

Building Exterior

As described above, the applicant is proposing exterior changes to the existing building façades. The existing storefront is proposed to be made taller through a parapet extension and mesh metal crown that will extend across the adjacent tenant space. The existing entry door and entry awning on the west side (on Mills Pharmacy) is proposed to be removed and replaced with a solid door. The existing large window, 4 gooseneck light fixtures, reclaimed wood facade and "Holiday Market Select" sign will remain.

The adjacent storefront will receive several treatments to match the existing storefront. The existing entry door and storefront windows will remain, which (along with the trim) will be painted to match the Holiday Market theme. The existing brick façade will be clad over with exterior grade wood that will also be painted. This entryway will act as the new main entrance for the market. Above the entryway, a canopy is proposed with new trim above that will contain additional signage. Due to the existing sloped roof, an existing gutter will remain above the canopy trim/sign band that will also be painted to match. Finally, 10 new light fixtures are proposed. 5 of the light fixtures are gooseneck lights to match the existing fixtures, 3 wall sconces will be placed on the revamped storefront, 1 light fixture is proposed to run along the mesh metal crown, and 1 light fixture will be placed underneath the gutter to illuminate new signage.

A complete review of lighting and signage will be provided in their respective sections below. Please see the following table for a detailed list of proposed materials and color schemes:

New Material (Color)	Location	
Reclaimed Wood (Match existing)	Parapet Extension	
Mesh Metal Crown (Gunmetal PVD)	Top of Parapet	
Parapet Cap (Match Existing)	Cap of Parapet	
Canopy Area Trim (Tricorn Black)	Above Canopy	
Canopy (Black w/ White Stripes)	Above Storefront Door/Window	
Existing Entry Door (Tricorn Black)	West of Existing Storefront (to be closed off)	
Exterior Wood Cladding (Tricorn Black)	Covering Existing Brick Facade	
New Entry Door (Holiday Market Purple)	At New Storefront Entry (Existing Door)	
Existing Gutter (Tricorn Black)	At Existing Roofline	

Signage

As discussed above, the applicant has provided elevation drawings showing two areas with signage. The first area on the existing storefront is proposed to remain as-is with the "Holiday Market Select" sign. Above the canopy, the words "Deli, Bakery, Produce, Meats, Beer, Wine, Dinner" are shown as dimensional exterior grade letters. HOWEVER, the applicant has indicated at this time that there are still some internal discussions being had in regards to signage. Thus, NO NEW SIGNAGE WILL BE A PART OF THIS APPROVAL. It is also worth mentioning, for informational purposes (for the design team), the Design Review Board has often decided against signs with excessive descriptors, which is often handled on a case-by-case basis. The Design Review Board should offer some opinions to the design team on the initial signage proposal. The Planning Division or Design Review Board must approve all new signs before they may be installed.

Lighting

The elevation drawings submitted show 10 newly proposed light fixtures and 4 existing light fixtures for a proposed 14 total light fixtures. The 10 new fixtures consist of 5 gooseneck fixtures, 3 wall sconces, and 2 light-bars made up of 17 individual fixtures. All of the proposed fixtures are fully cut-off as required by Article 4, Section 4.21 (D) of the Zoning Ordinance.

Light Fixture	Quantity	Color	Manufacturer	Lumens per Lamp
Gooseneck	5	Match Existing	RLM Classics	1830
Light Bar	17	Black Anodized	KLUS Designs	350
Wall Sconce	3	Black	Cylinders/Cooper	505

There are some discrepancies across several of the plan sheets that must be resolved in terms of quantity and specifications in regards to the proposed wall sconces. The rendering-based design set shows 3 proposed wall sconces, and the material table at the end states that the manufacturer is Cooper Light. The architectural drawings (Sheet A.200) show only 1 wall sconce on the elevation drawings, and show the manufacturer as Cylinders. Finally, the photometric plan shows only 2 wall sconces, and has the manufacturer as Cylinders.

As required, the applicant has submitted a photometric plan documenting the illumination levels at the property line of the proposed project site. There exist a couple of issues with the photometric plan provided:

- 1. The photometric plan does not show the light fixtures proposed at the top of the mesh metal crown. Although this lighting will be unlikely to affect the light levels at the property line significantly, all fixtures are required to be shown on the photometric plan. Additionally, the plan only shows 2 wall sconces where 3 seem to be proposed.
- 2. The illumination levels were not calculated correctly. The photometric plan notes that the calculations are shown in foot-candles at 0 ft. 0 in. Article 4, Section 4.21 of the Zoning Ordinance requires light intensity to be measured at 6 ft. above ground level on a vertical plane.
- 3. For this project, the illumination levels shall not exceed 1.5 maintained foot-candles at any property line. The intensity of light on a site which provides a front setback of less than 5 ft. shall be measured from 5 ft. beyond the front property line. The subject buildings fit this criteria. Although the photometric plan is not to scale (not uncommon), the site plans show the canopy at a 5 ft. 7 in. extension, which we may use as a rough reference. Using the canopy, it appears as though there is at least one figure that may currently exceed the illumination levels permitted in that area at 1.6 foot-candles (east side of canopy). When a new photometric plan is submitted, there are likely to be more issues. There are also some high foot-candle measurements as the measurements continue east and/or west.

In summation, the applicant must submit revised site & photometric plans showing consistent lighting information and illumination levels that do not exceed 1.5 foot-candles at the east/west property lines and 5 ft. beyond the front (south) property line.

Planning and Zoning

The plans submitted show the proposed canopy at roughly 8 ft. 3 in. from grade. Article 4, Section 4.74 of the Zoning Ordinance outlines the standards for encroachments into the right-of-way (ROW). Removable architectural elements above 8 ft. such as awnings, canopies, and marquees may be approved by the Design Review Board to project into the right of way provided that they are constructed to support applicable loads without any ground mounted supports on public property. Encroachments with less than 15' of clearance above the sidewalk shall not extend into or occupy more than two-thirds of the width of the sidewalk or 5 feet, whichever is less, and must not interfere with any existing or planned streetscape elements or infrastructure.

The sidewalk in front of the building is noted at 6 ft. The above requirements would indicate that two-thirds of the width of the sidewalk is 4 ft. This would require the applicant to redesign the canopy to extend no more than 4 ft. into the ROW, as that is the smaller figure. Thus, **the applicant must submit revised drawings showing a canopy that projects no more than 4 ft. into the ROW**. Additionally, the Design Review Board should discuss the projection and determine whether or not to approve such.

In terms of building height, the Planning Division reviewed the development standards of the B1 Zoning District to ensure the parapet extension did not exceed the maximum building height permitted. The site plans submitted show a building height of 17 ft. 8 in. to the top of the parapet crown.

Design Recommendation

When reviewing the project against the standards of Article 7, Section 7.09 of the City of Birmingham Zoning Ordinance, staff makes the following observations:

- 1. All of the materials required by this section have been submitted for review.
 - The applicant has submitted all required application materials.
- 2. All provisions of this Zoning Ordinance have been complied with.
 - The applicant has NOT fully complied with the Zoning Ordinance in regards to projections into the right-of way and site illumination.
- 3. The appearance, color, texture and materials being used will preserve property values in the immediate neighborhood and will not adversely affect any property values.
 - The proposed improvements to the building will not likely adversely affect property values.
- 4. The appearance of the building exterior will not detract from the general harmony of and is compatible with other buildings already existing in the immediate neighborhood.
 - The overall design elements proposed does not appear to detract from the general harmony of the existing buildings in the neighborhood, and is compatible with the immediate neighborhood.
- 5. The appearance of the building exterior will not be garish or otherwise offensive to the sense of sight.
 - It does not appear that the proposed design elements are garish or otherwise offensive to the sense of sight.
- 6. The appearance of the building exterior will tend to minimize or prevent discordant and unsightly properties in the City.
 - The proposed improvements to the exterior of the building are not unsightly nor discordant.
- 7. The total design, including but not limited to colors and materials of all walls, screens, towers, openings, windows, lighting and signs, as well as treatment to be utilized in concealing any exposed mechanical and electrical equipment, is compatible with the intent of the urban design plan or such future modifications of that plan as may be approved by the City Commission.
 - It appears as though the design elements proposed are compatible with the intent of the urban design plan.

Recommendation

The Planning Division recommends that the Design Review Board **APPROVE** the Design Review application for 1740 W. Maple – Holiday Market Select – with the following conditions:

- This approval does NOT include any changes to the signage on the property;
- 2. The applicant must submit revised site & photometric plans showing consistent lighting information and illumination levels that do not exceed 1.5 foot-candles at the east/west property lines and 5 ft. beyond the front (south) property line;
- 3. The applicant must submit revised drawings showing a canopy that projects no more than 4 ft. into the ROW; and
- 4. The Design Review Board APPROVES the projection into the right-of-way.

Sample Motion Language

Motion to **APPROVE** the Design Review application for 1740 W. Maple – Holiday Market Select – with the following conditions:

- 1. This approval does NOT include any changes to the signage on the property;
- 2. The applicant must submit revised site & photometric plans showing consistent lighting information and illumination levels that do not exceed 1.5 foot-candles at the east/west property lines and 5 ft. beyond the front (south) property line;
- 3. The applicant must submit revised drawings showing a canopy that projects no more than 4 ft. into the ROW; and
- 4. The Design Review Board APPROVES the projection into the right-of-way.

OR

Motion to **POSTPONE** the Design Review application for 1740 W. Maple – Holiday Market Select – pending receipt of the following:

1.	
2.	
3.	

OR

Motion to **DENY** the Design Review application for 1740 W. Maple – Holiday Market Select; the proposal does not meet the requirements of Article 7, Section 7.09 of the Zoning Ordinance.





EXTERIOR DESIGN DEVELOPMENT

June 11, 2020





















EXISTING BRICK TO REMAIN

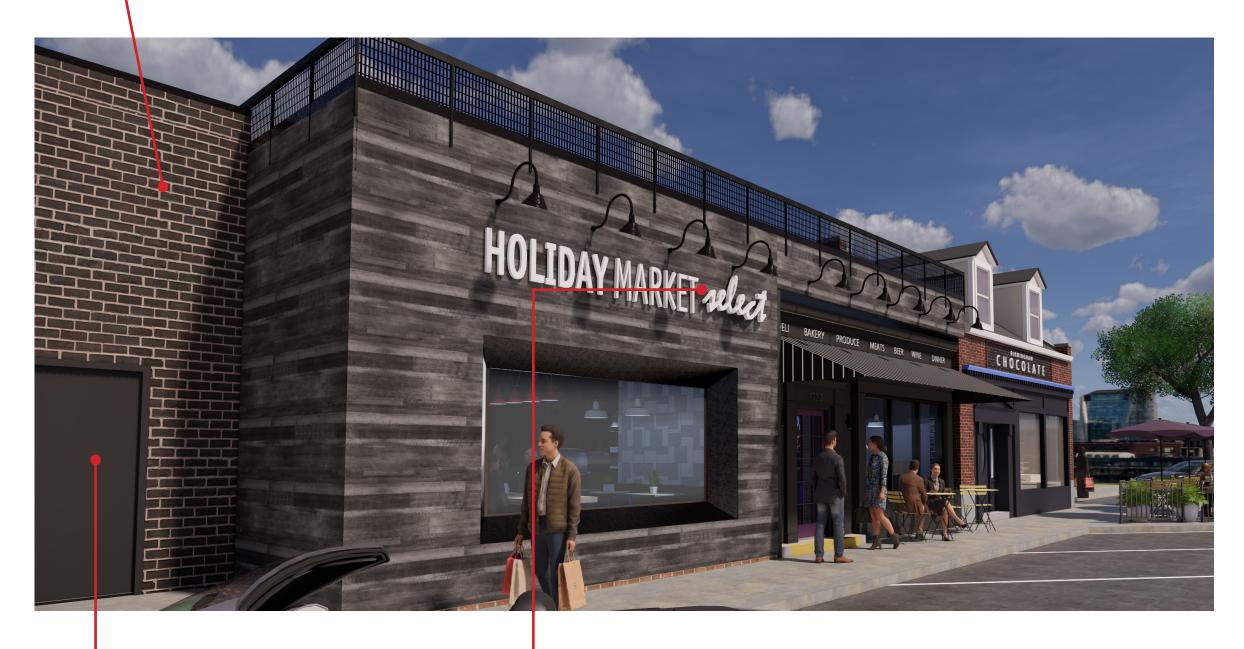

EXISTING DOOR TO BE CLOSED OFF. DOOR AND FRAME TO BE PAINTED (P4) TRICORN BLACK SW 6258 SIGN POSSIBLY TO BE MODIFIED-PENDING NAME CHANGE FROM EXISTING

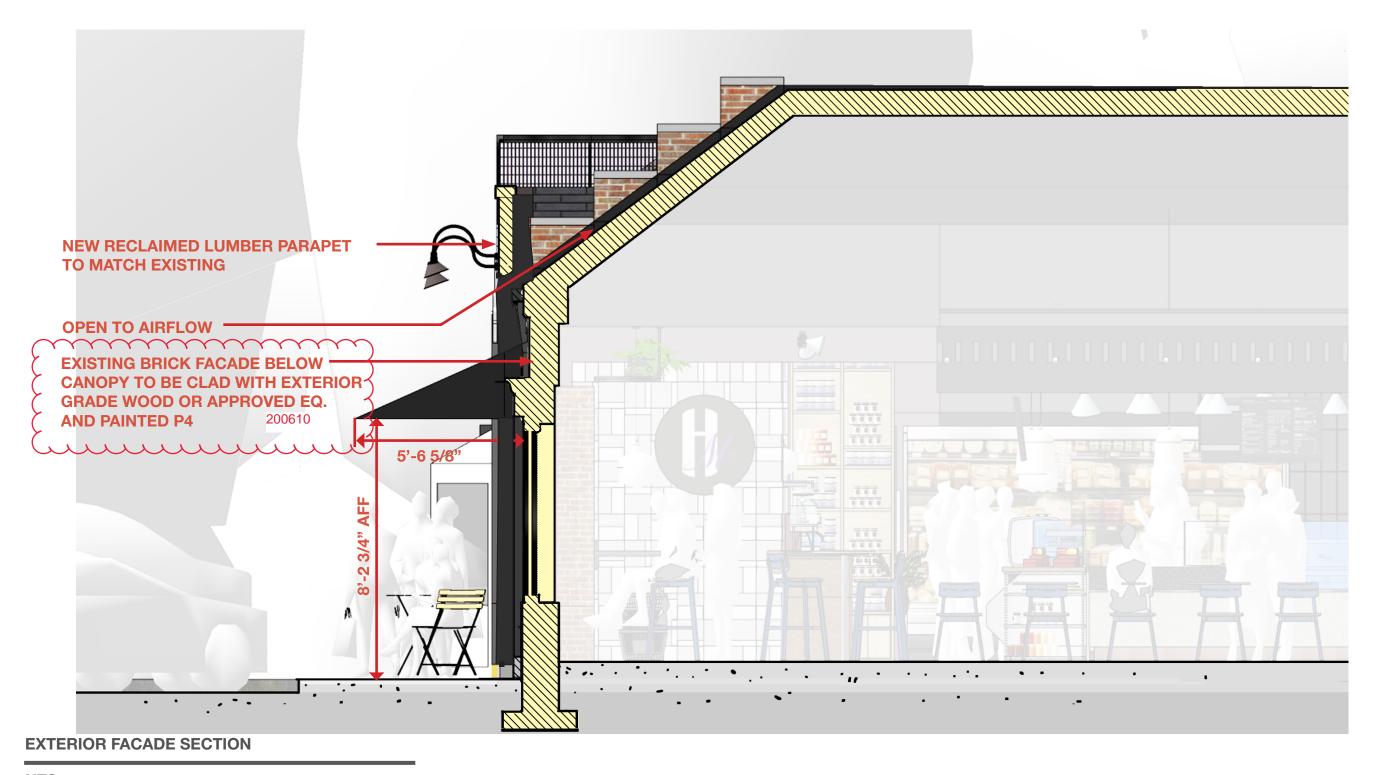

NTS



CANOPY DETAIL

NTS


NOTE: VERIFY ALL DIMENSIONS IN FEILD PRIOR TO PURCHASE/FABRICATION. PROVIDE MOCK UP OF CUSTOM PRINT CANOPY MATERIAL WITH WHITE STRIPES TO STUDIOH2G FOR APPROVAL PRIOR TO PURCHASE/FABRICATION

KLUS PDS4-ALU LIGHT CONCEAL MOUNTED BELOW TOP FRAM-ING-REFER TO MANUF. INSTALLATION

L-SHAPE TOP METAL

BANKER WIRE (M3) LZ-55 LARGE WOVEN WIRE MESH FACE. COLOR **GUNMETAL PVD**


1"W X 1" D VERTICAL **FRAMING- COLOR TO** MATCH (M3) MESH MET-**AL LZ-55 FINISH (GUN-METAL PVD)**

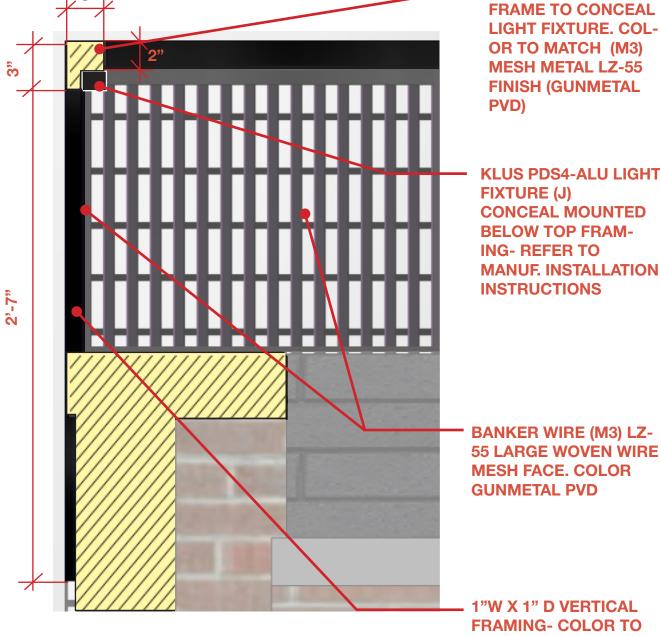

METAL CROWN SECTION

NTS

NOTE: VERIFY ALL DIMENSIONS IN FEILD PRIOR TO PURCHASE/FABRICATION. PROVIDE MOCK UP TO STUDIOH2G FOR APPROVAL PRIOR TO PURCHASE/FABRI-**CATION**

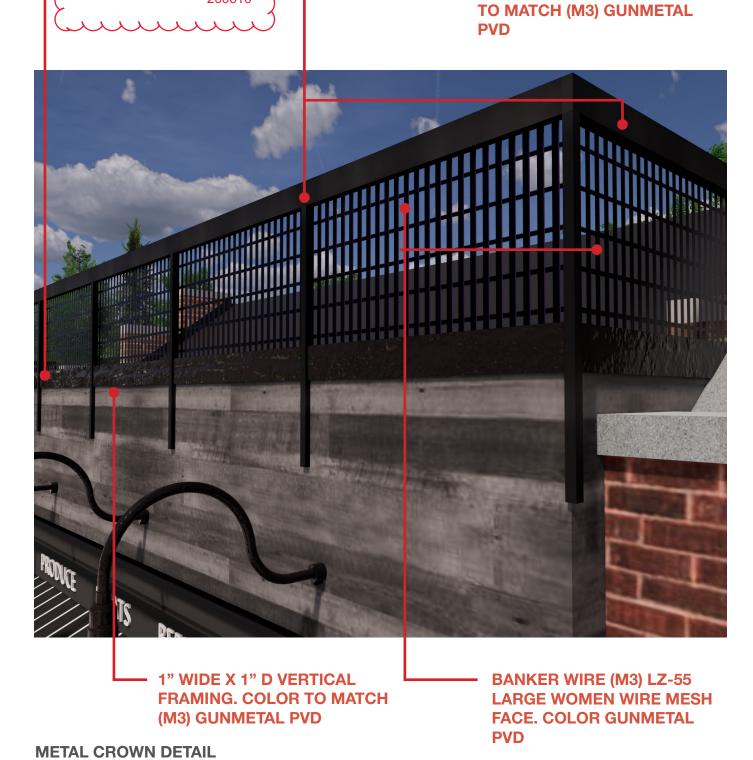

L-SHAPE TOP METAL

FRAME WITH CONCEAL

LIGHT FIXTURE (J). COLOR

NTS

NEW CAP TO MATCH

200610

EXISTING

PAINTED (P4) TRICORN BLACK SW 6258

KLUS PDS4-ALU LIGHT FIXTURE (J) **SURFACE MOUNTED BELOW GUTTER- RE-**FER TO MANUF. IN-STALLATION INSTRUC-**TIONS**

EXISTING GUTTER/ ROOF SYSTEM TO BE

EXTERIOR GRADE WOOD OR APPROVED EQ. TRIM TO BE PAINTED (P4) TRICORN **BLACK SW 6258**

5"H X 1/2 D EXTERIOR **GRADE DIMENSIONAL METAL LETTERS FLUSH MOUNTED TO TRIM- TO BE PAINTED WHITE**

TRIM SECTION

NTS

5/8"

NOTE: VERIFY ALL DIMENSIONS IN FEILD PRIOR TO PURCHASE/FABRICATION. PROVIDE MOCK UP TO STUDIOH2G FOR APPROVAL PRIOR TO PURCHASE/FABRI-**CATION**

KLUS PDS4-ALU FIXTURE (J) SURFACE **MOUNTED BELOW GUTTER**

EXISTING GUTTER/ROOF SYSTEM TO REMAIN. PAINTED TO MATCH (P4) TRICORN BLACK SW 6258.



EXTERIOR GRADE WOOD OR APPROVED EQ. TRIM TO **BE PAINTED (P4) TRICORN BLACK SW 6258**

DIMENSIONAL EXTERIOR **GRADE METAL LETTERS TO BE FLUSH MOUNT ON TRIM FACE. PAINTED WHITE**

TRIM DETAIL

NTS

Project Name: Holiday Market Select

Project Number:

Location: 1740 W Maple Rd, Birmingham, MI 48009

Materials + Finishes Schedule

Date: April 27, 2020

Revisios:



		Banker Wire	C.I. Banker Wire & Iron Works	QTY: TBD	Location in Project:
		LZ-55 Large Woven Wire	Headquarters	Lead Time: TBD	Exterior metal canopy
		Mesh Pattern	123 W. Boxhorn Drive		
		color: Gunmetal PVD	Mukwonago, WI 53149		
		framing to match	sales@bankerwire.com		
M3			262-363-6120		
		Paint	Dawn M Cenowa, CSI	QTY: TBD	Location in Project:
		Color: Tricorn Black	The Sherwin-Williams Company	Lead Time: TBD	Exterior brick, trim, door
		Code: SW 6258	2550 S Telegraph Rd, Suite 118,		& frames
	SHERWIN-WILLIAMS		Bloomfield Hills, MI 48302		
			P:248.660.3067		
Tricorn Black SW 6258			dawn.m.cenowa@sherwin.com		
P4					
		Paint	rep: tbd	QTY: TBD	Location in Project:
		Collection: tbd		Lead Time: TBD	exterior entry door and
Holiday Market Durnla		Color: tbd			frame
Holiday Market Purple	SHERWIN-WILLIAMS	Code: tbd			
P5					

Project Name: Holiday Market Select

Project Number:

Location: 1740 W Maple Rd, Birmingham, MI 48009

Lighting Schedule Date: April 27, 2020

Revisios:




Fixture	Manufacturer	Description	Source	QTY/Delivery	Remarks
	COOPER LIGHT	Lumiere Collection: Westwood 912- Color: Black BK Code:912-2 Size: Lamp Type: exterior wall sconce	Amanda Leporowksi 30775 Barrington Street Madison Heights MI, 48071 248.677.0850	QTY: 3 Lead Time: TBD	Location in Project: exterior façade- painted brick wall
	KLUS DESIGNS	Code: PDS4-ALU Size: Lamp Type: TBD	Josh Dickerson Gasser Bush Associates 30984 Industrial Livonia, MI 48150 P:734.266.6705 C:248.688.8001 jdickerson@gasserbush.c om	QTY:TBD Lead Time: TBD	Location in Project: surface mounted to façade- under metal mesh crown trim & existing gutter

Thank You.



2299 E Lincoln Birmingham, MI 48009 USA +1 248.671.4640 www.studioH2G.com

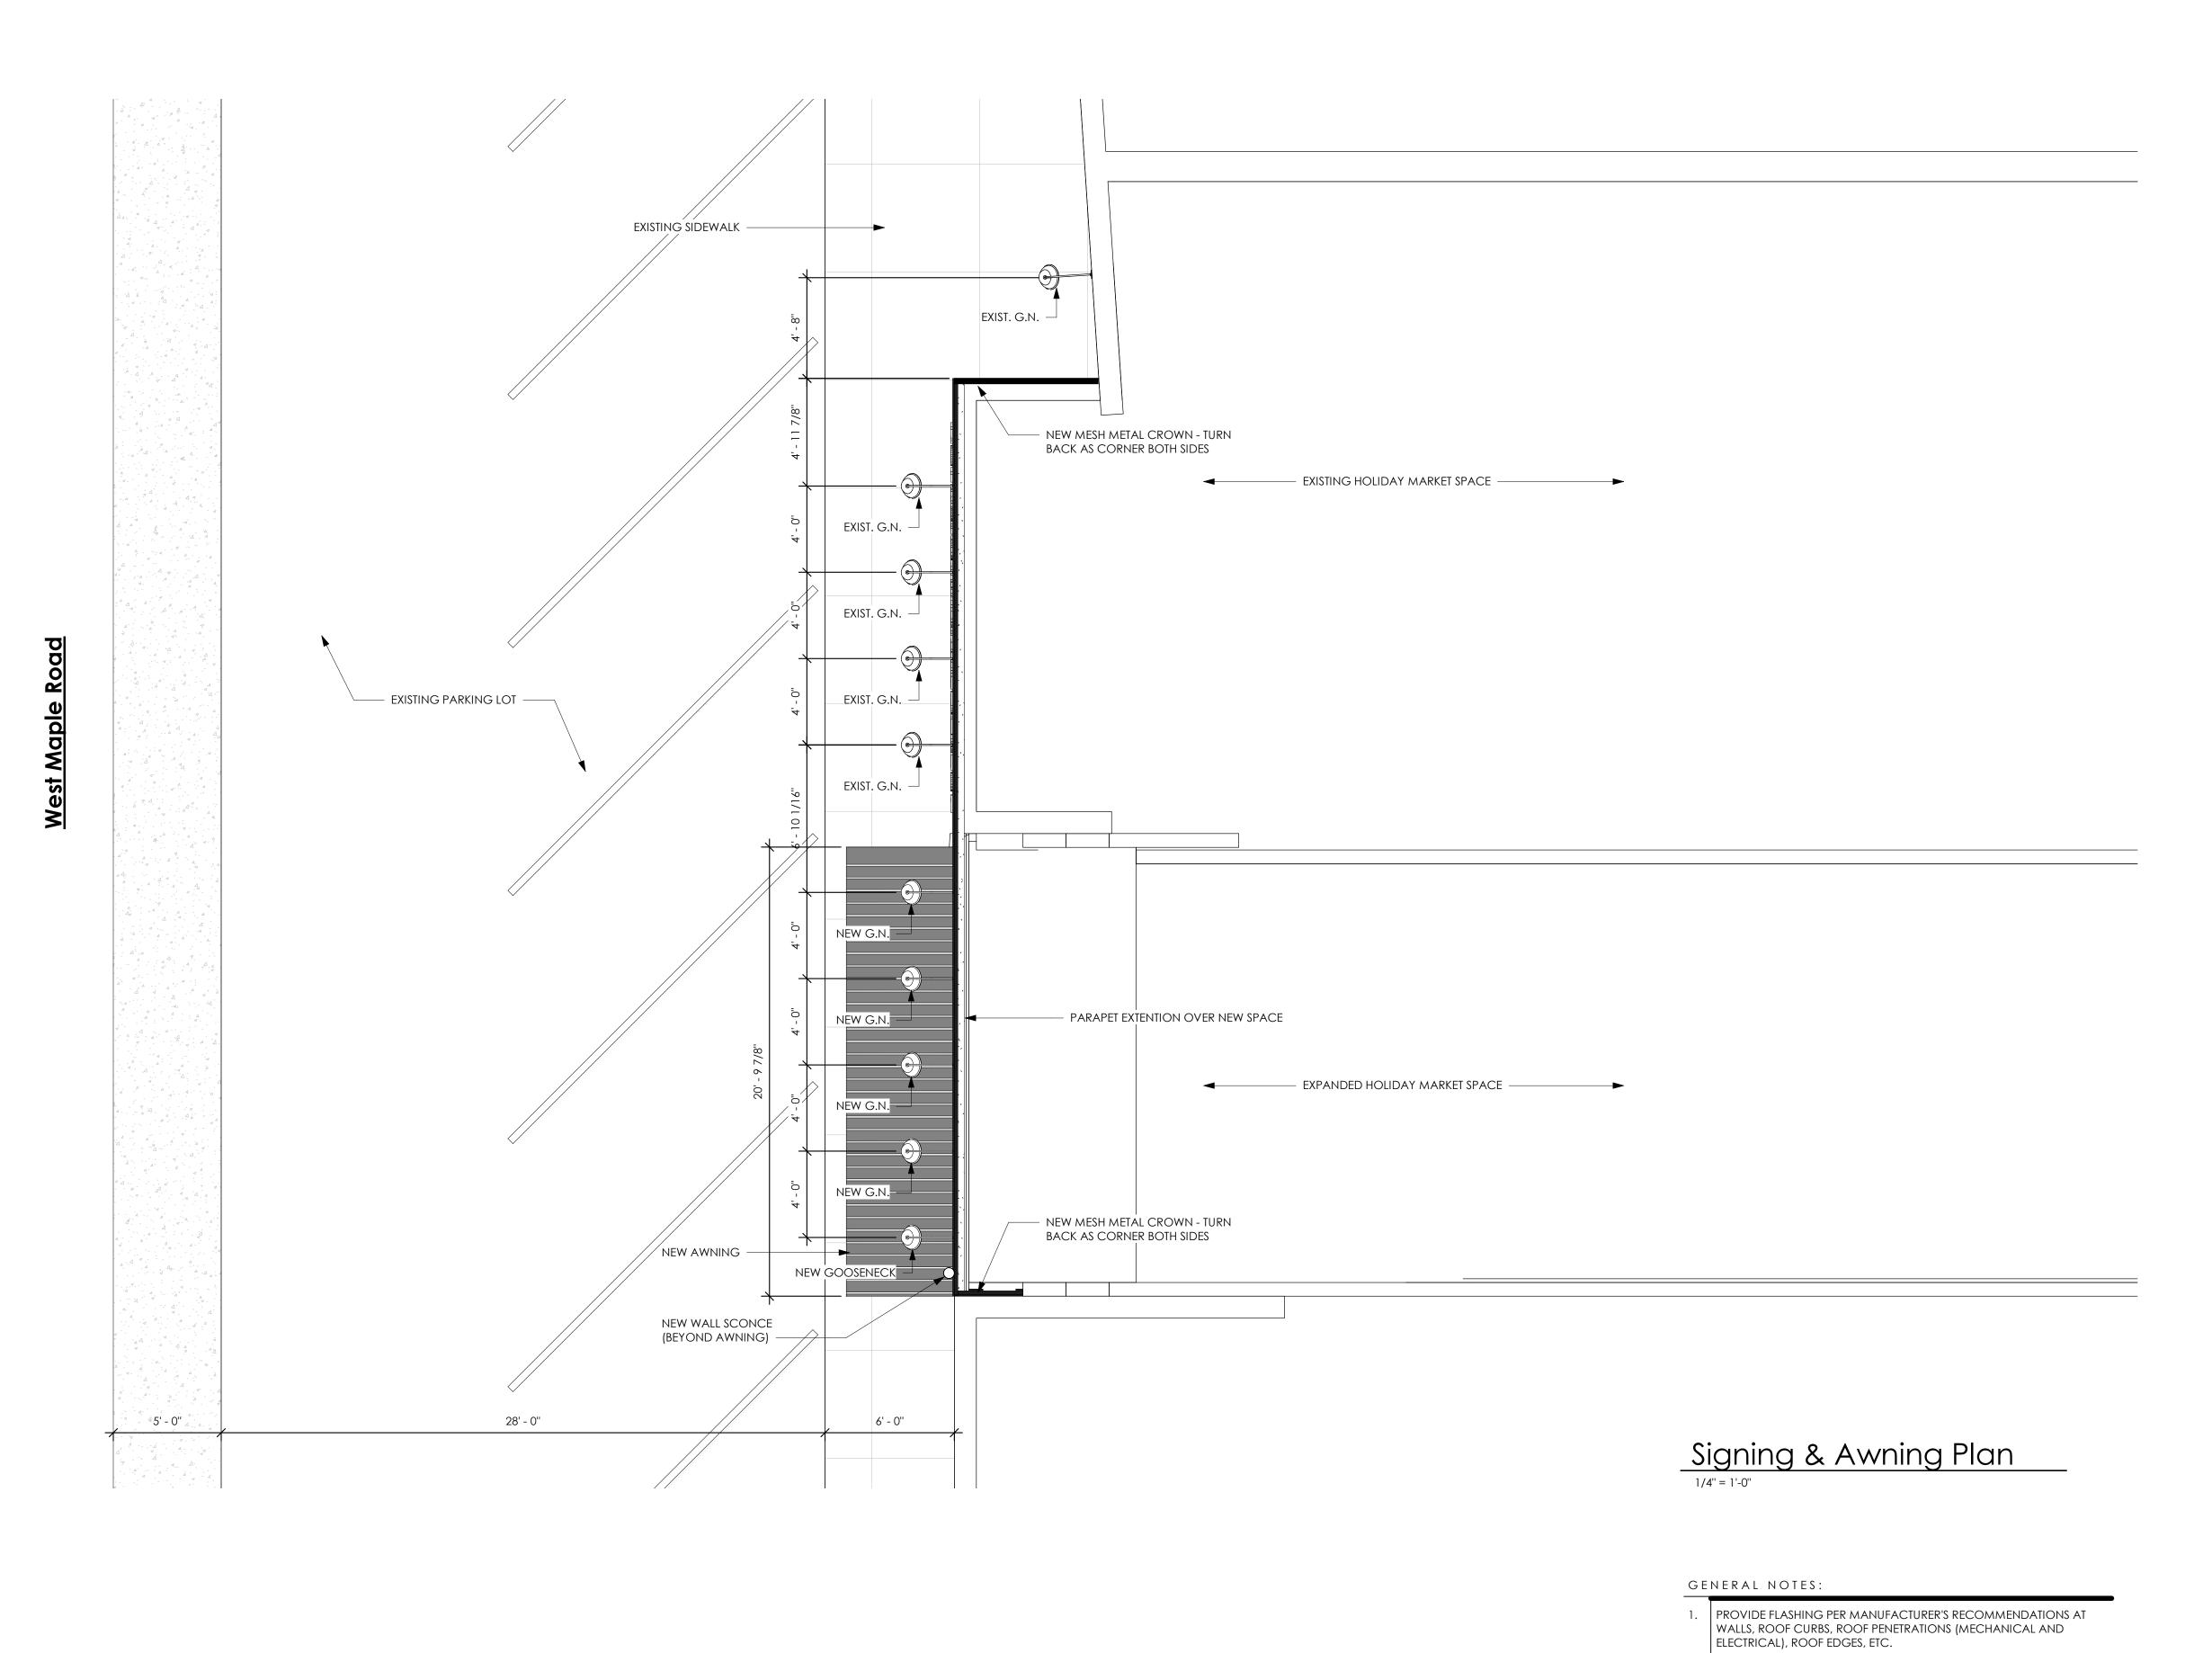

krieger klatt

ARCHITECTS

architecture interiors consulting 1412 E. 11 Mile Rd. | Royal Oak, MI 48067 **P:** 248.414.9270 **F:** 248.414.9275 **www.kriegerklatt.com**

Client:


Viogold 4, LLC 1203 S. Main St. Royal Oak, MI 48067

Project:

Holiday Market Select 1740 W Maple Rd., Birmingham, MI 48009


Issued	Description Design Review Board
06-15-2020	Design Review Board

Seal:

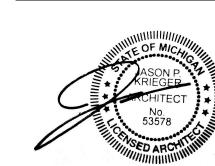

Note:

Do not scale drawings. Use calculated dimensions only.
Verify existing conditions in field. North Arrow:

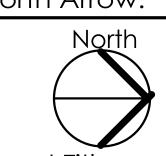

Sheet Title:

Signing & Awning Plan

Project Number:

19-100

2. | FIELD VERIFY EXISTING ROOF CONDITIONS AND PENETRATIONS PRIOR

3. NOTIFY ARCHITECT OF ANY AND ALL DISCREPANCIES OF EXISTING

5. EXISTING PARKING SPACES AND PARKING LOT TO REMAIN AS IS

4. PROVIDE SPACE NECESSARY BETWEEN GUTTER DOWNSPOUT AND NEW AWNING PER ANY MANUFACTURER SPECIFICATIONS REGARDING

TO COMMENCEMENT OF WORK.

6. EXISTING LIGHT FIXTURES TO REMAIN

Sheet Number:

krieger klatt

architecture interiors consulting
1412 E. 11 Mile Rd. | Royal Oak, MI 48067
P: 248.414.9270 F: 248.414.9275
www.kriegerklatt.com

Client:


Viogold 4, LLC 1203 S. Main St. Royal Oak, MI 48067

Project:

Holiday Market Select 1740 W Maple Rd., Birmingham, MI 48009



Seal:

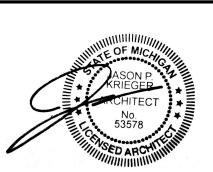

Note:

Do not scale drawings. Use calculated dimensions only. Verify existing conditions in field. North Arrow:

Sheet Title:


South Front Elevation


Project Number:

19-100

Sheet Number:

A.200

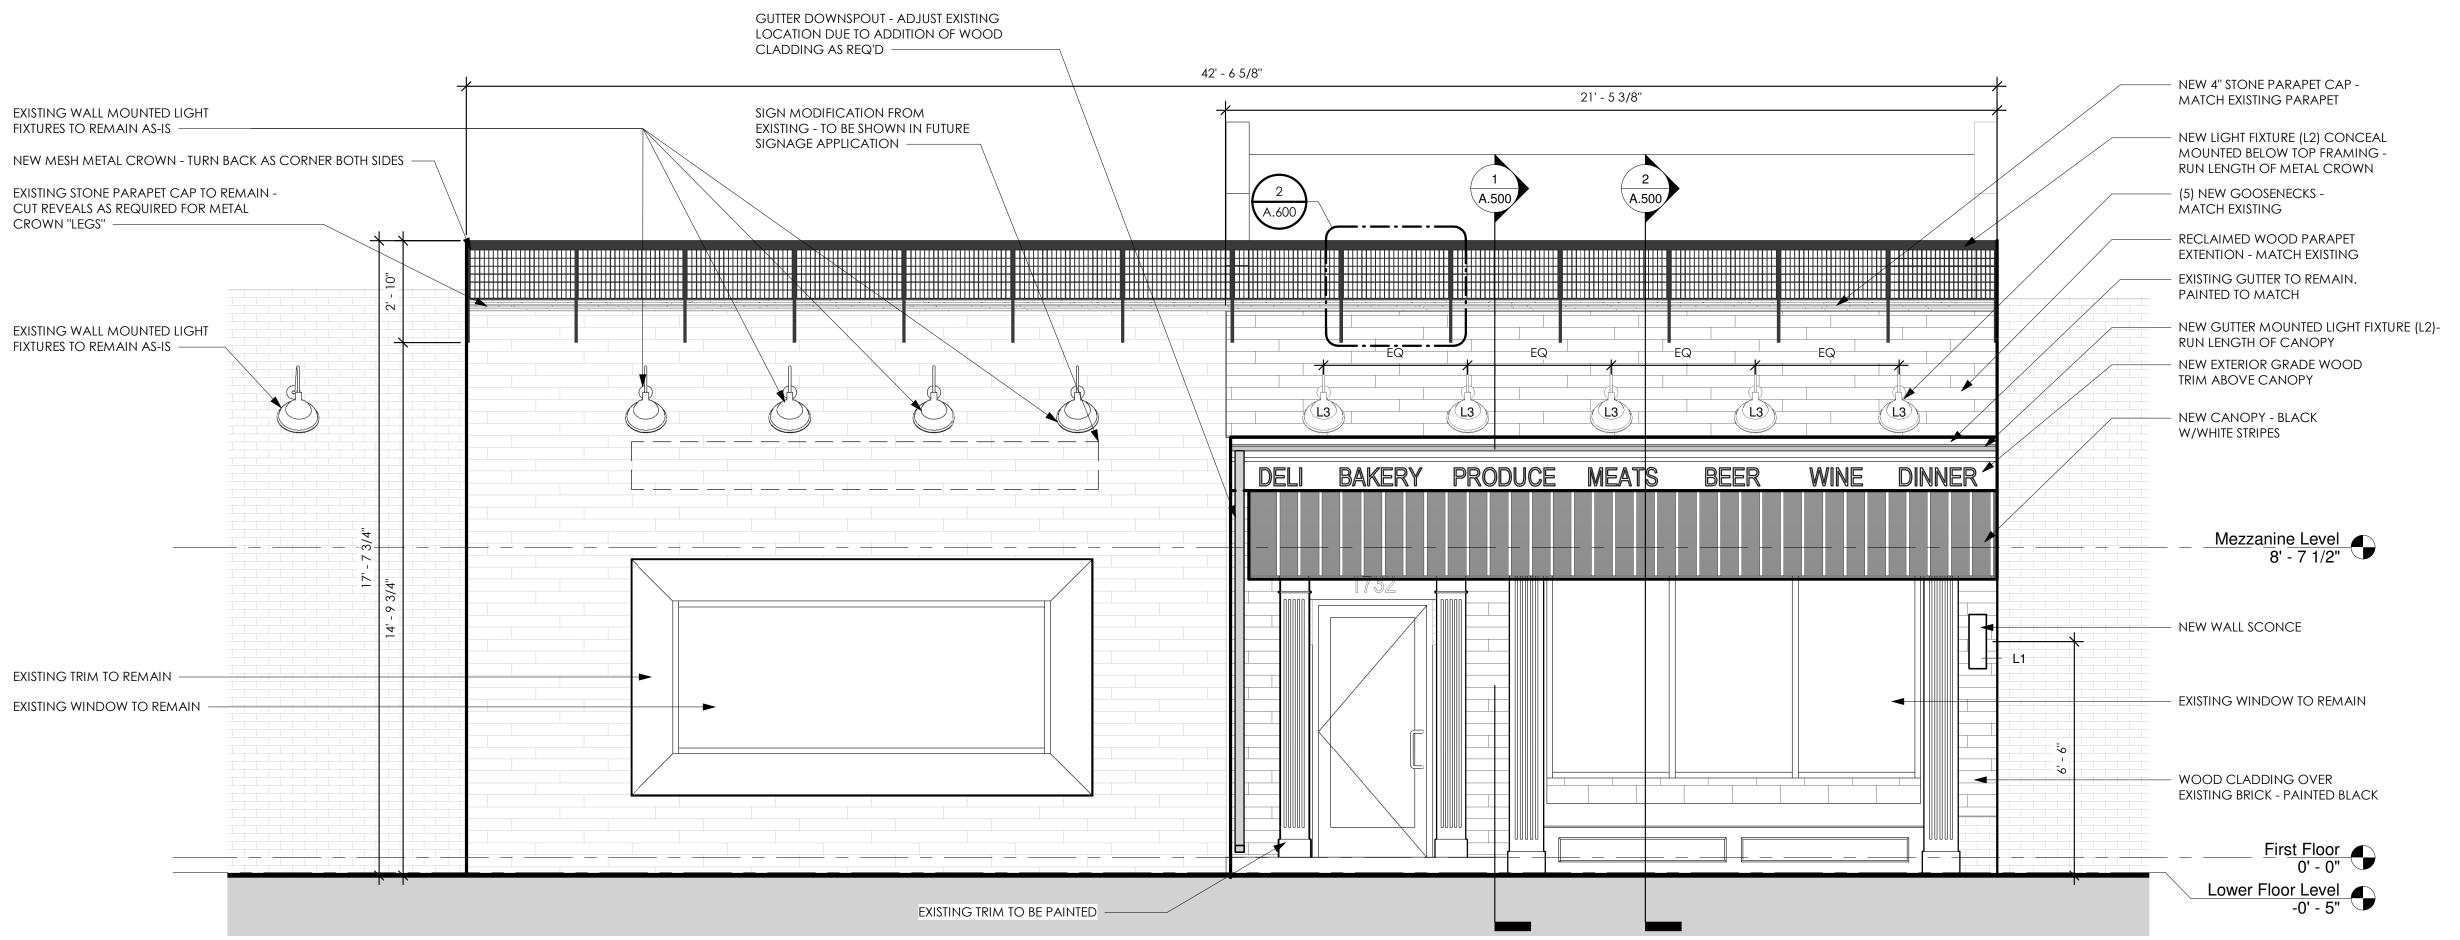

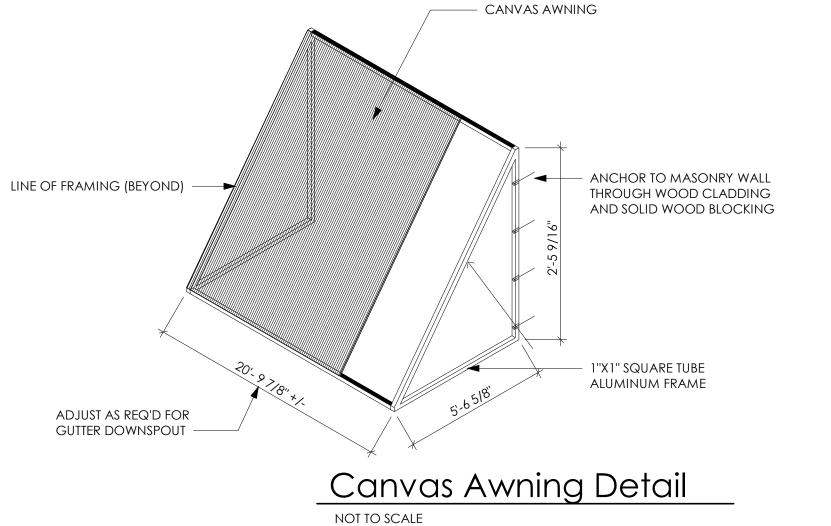

Exterior Light Fixture: L1

MANUF: CYLINDERS
COLOR: BLACK BK
CODE: C0310UDXT - WALL MOUNT



Exterior Light Fixture: L2

MANUF: KLUS DESIGNS
COLOR: BLACK ANODIZED
CODE: PDS4-ALU

Exterior Light Fixture: L3 MANUF: RLM CLASSICS


South (Front) Elevation

aht Fixture: L3 1. EXISTING FEATURES (LIGHT FIXTRES, DOORS, TRIM, ETC.) TO REMAIN AS IS UNLESS OTHERWISE NOTED

MANUF: RLM CLASSICS
COLOR: BLACK ANODIZED
CODE: AR1214GV-27L-35K-EX-TF1-MW1

2. SIGNAGE CHANGES / ADDITIONS TO BE COMPLETED WITH FUTURE SIGNAGE PERMIT APPLICATION

GENERAL NOTES:

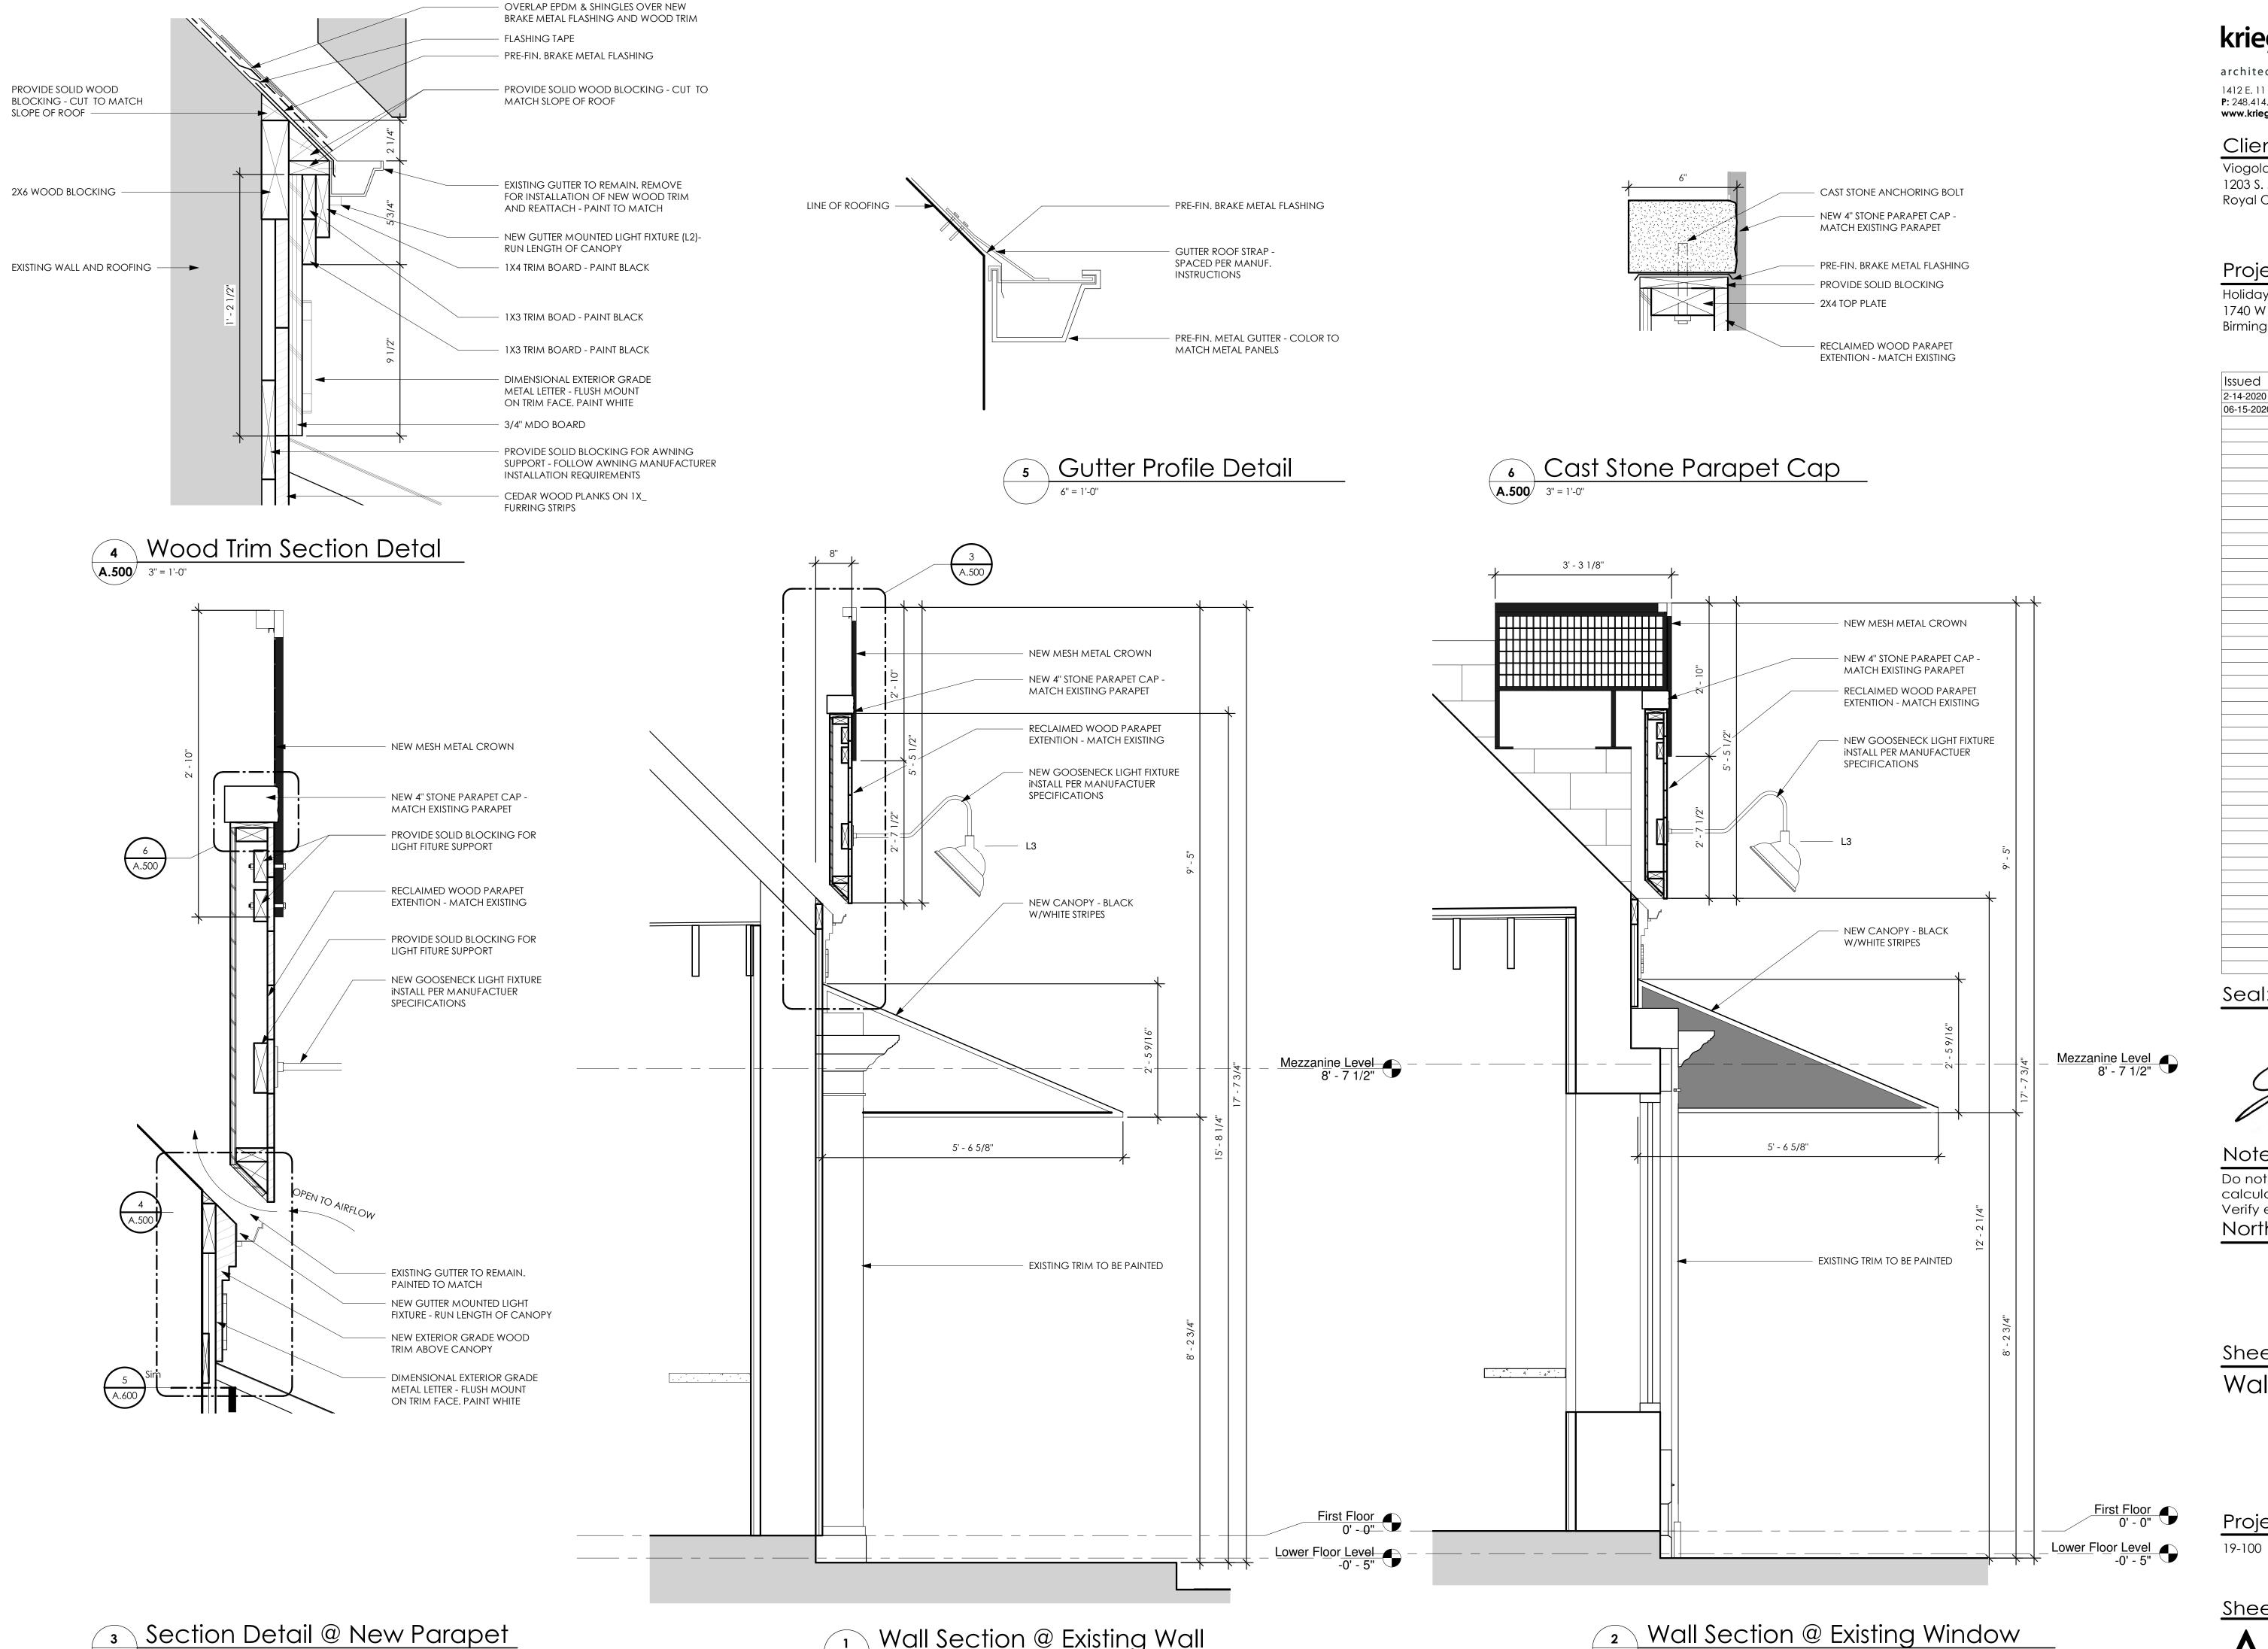

architecture interiors consulting 1412 E. 11 Mile Rd. | Royal Oak, MI 48067 P: 248.414.9270 F: 248.414.9275 www.kriegerklatt.com

Client:


Viogold 4, LLC 1203 S. Main St. Royal Oak, MI 48067

Project:

Holiday Market Select 1740 W Maple Rd., Birmingham, MI 48009

Issued	Description	
2-14-2020	Building Permit	
06-15-2020	Design Review Board	

Seal:

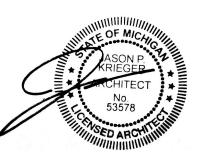

Note:

Do not scale drawings. Use calculated dimensions only.

Verify existing conditions in field. North Arrow:


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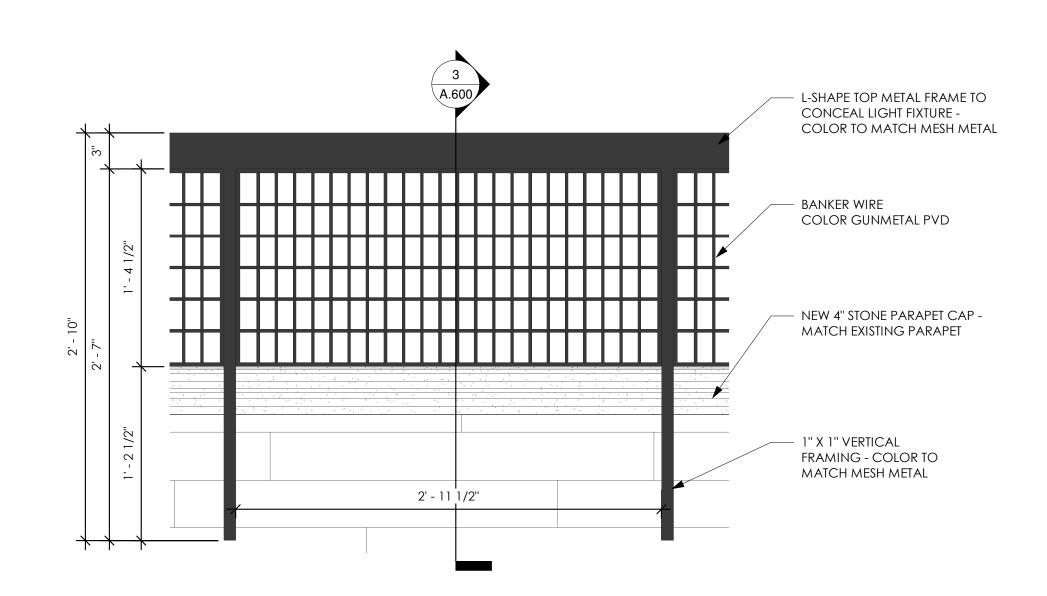
Wall Sections

Project Number:


Sheet Number:

A.200 3/4" = 1'-0"




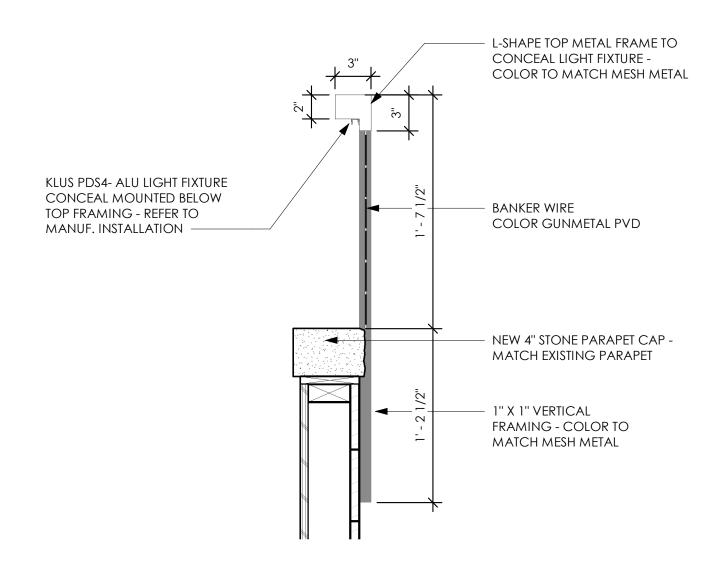


Metal Crown Elevation

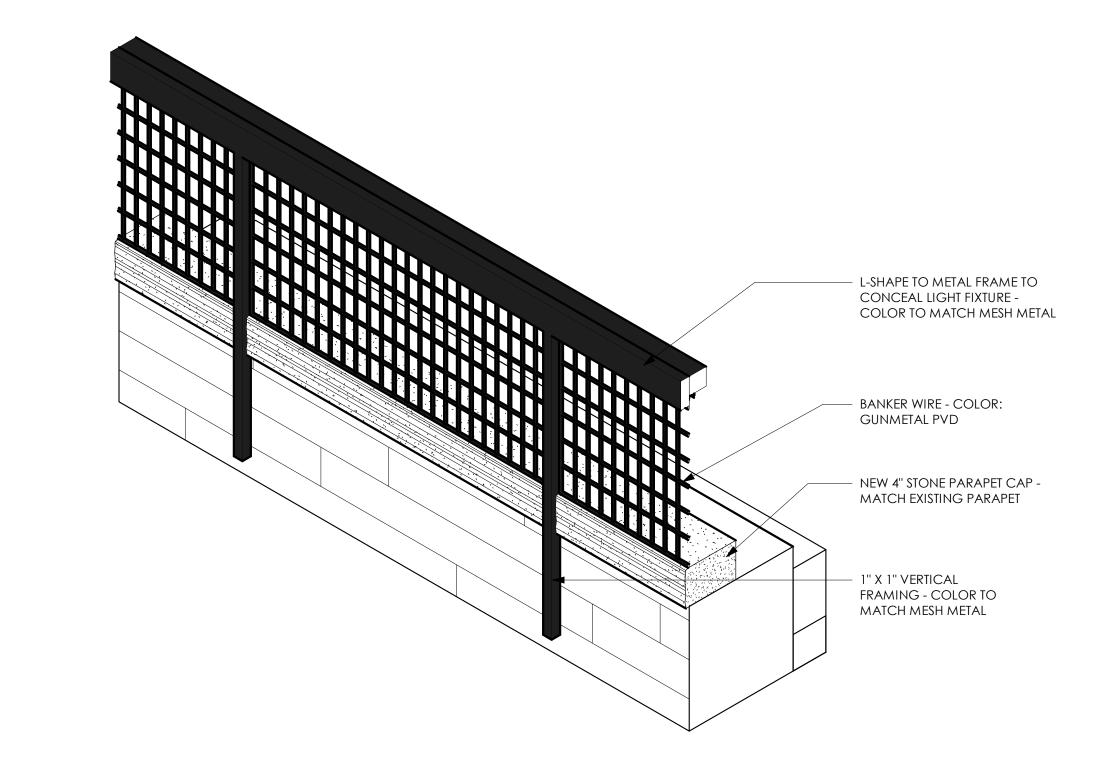

Metal Crown Section Detail A.600 1 1/2" = 1'-0"

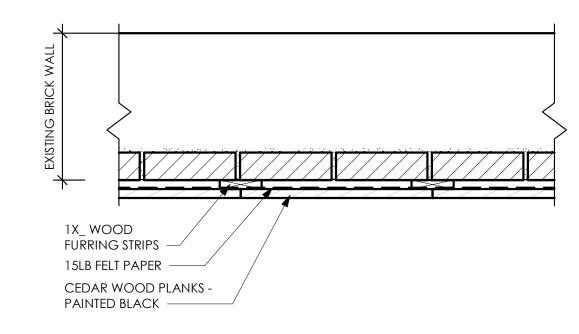

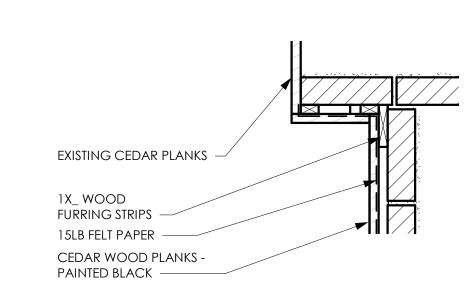


Wood Cladding Plan Detail

A.500 1 1/2" = 1'-0"

Wood Cladding Plan Detail @ Existing Building Corner

A.100 1 1/2" = 1'-0"

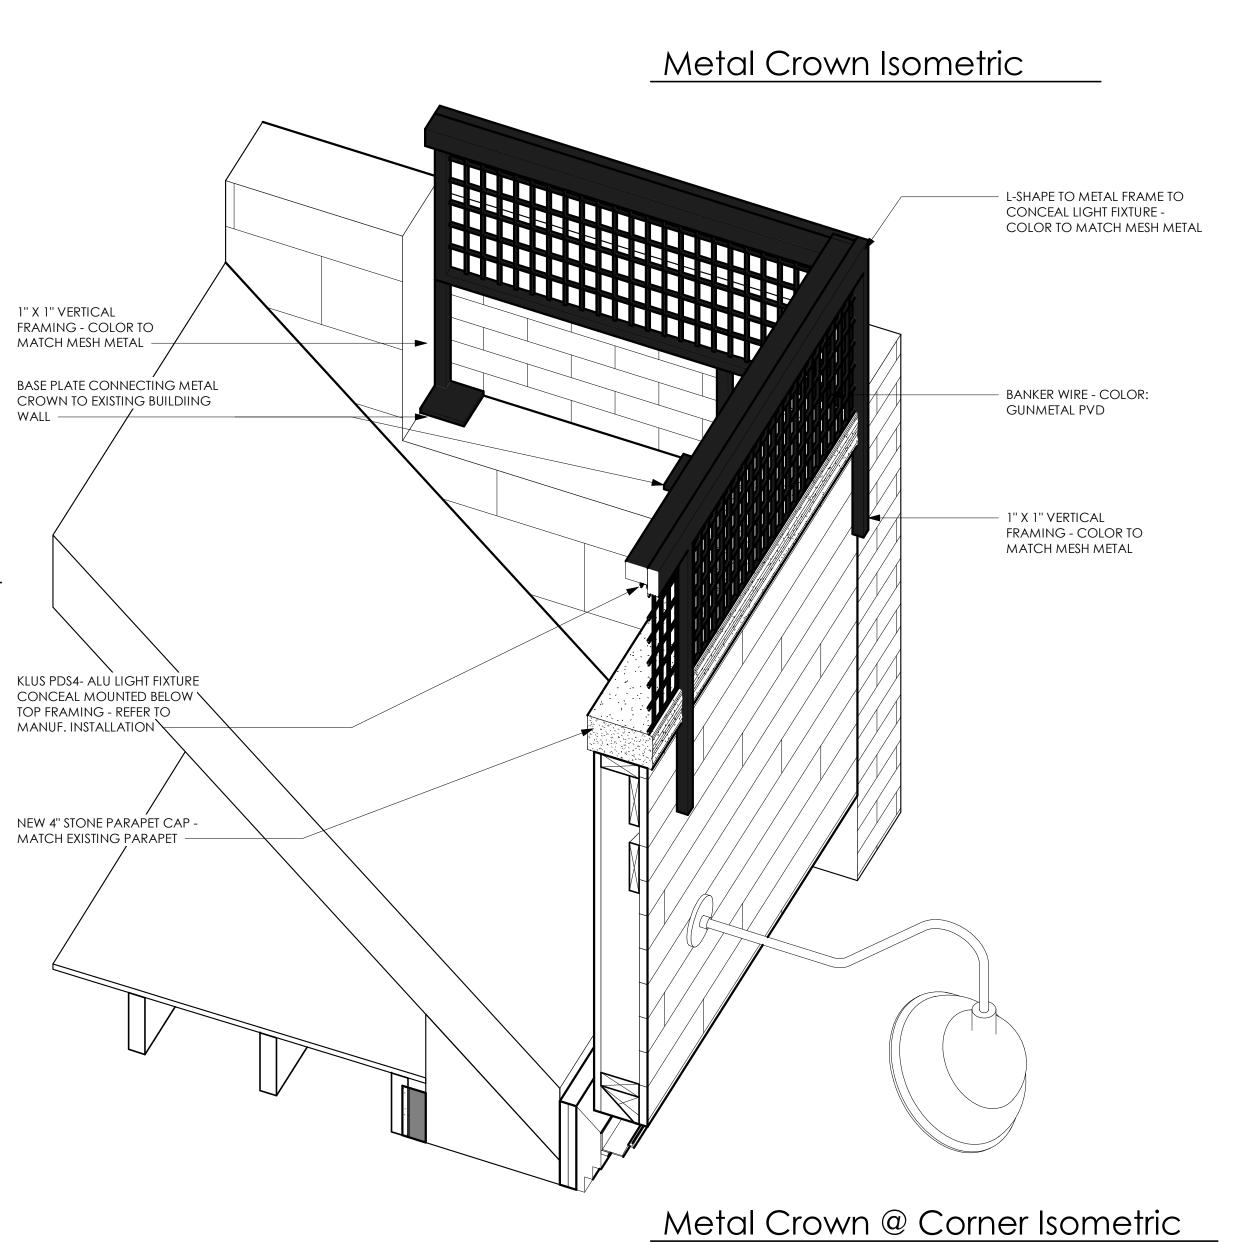

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P: 248.414.9270 F: 248.414.9275
www.kriegerklatt.com

Client:


Viogold 4, LLC 1203 S. Main St. Royal Oak, MI 48067

Project:

Holiday Market Select 1740 W Maple Rd., Birmingham, MI 48009

Issued	Description
2-14-2020	Building Permit
06-15-2020	Design Review Board
	3 3 3 3 3 3 3 3 3 3 3 3 3 3 3 3 3 3 3 3

Seal:

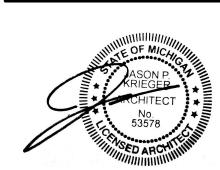

Note:

Do not scale drawings. Use calculated dimensions only. Verify existing conditions in field. North Arrow:

Sheet Title:


Construction Details


Project Number:

19-10

Sheet Number:

A.600

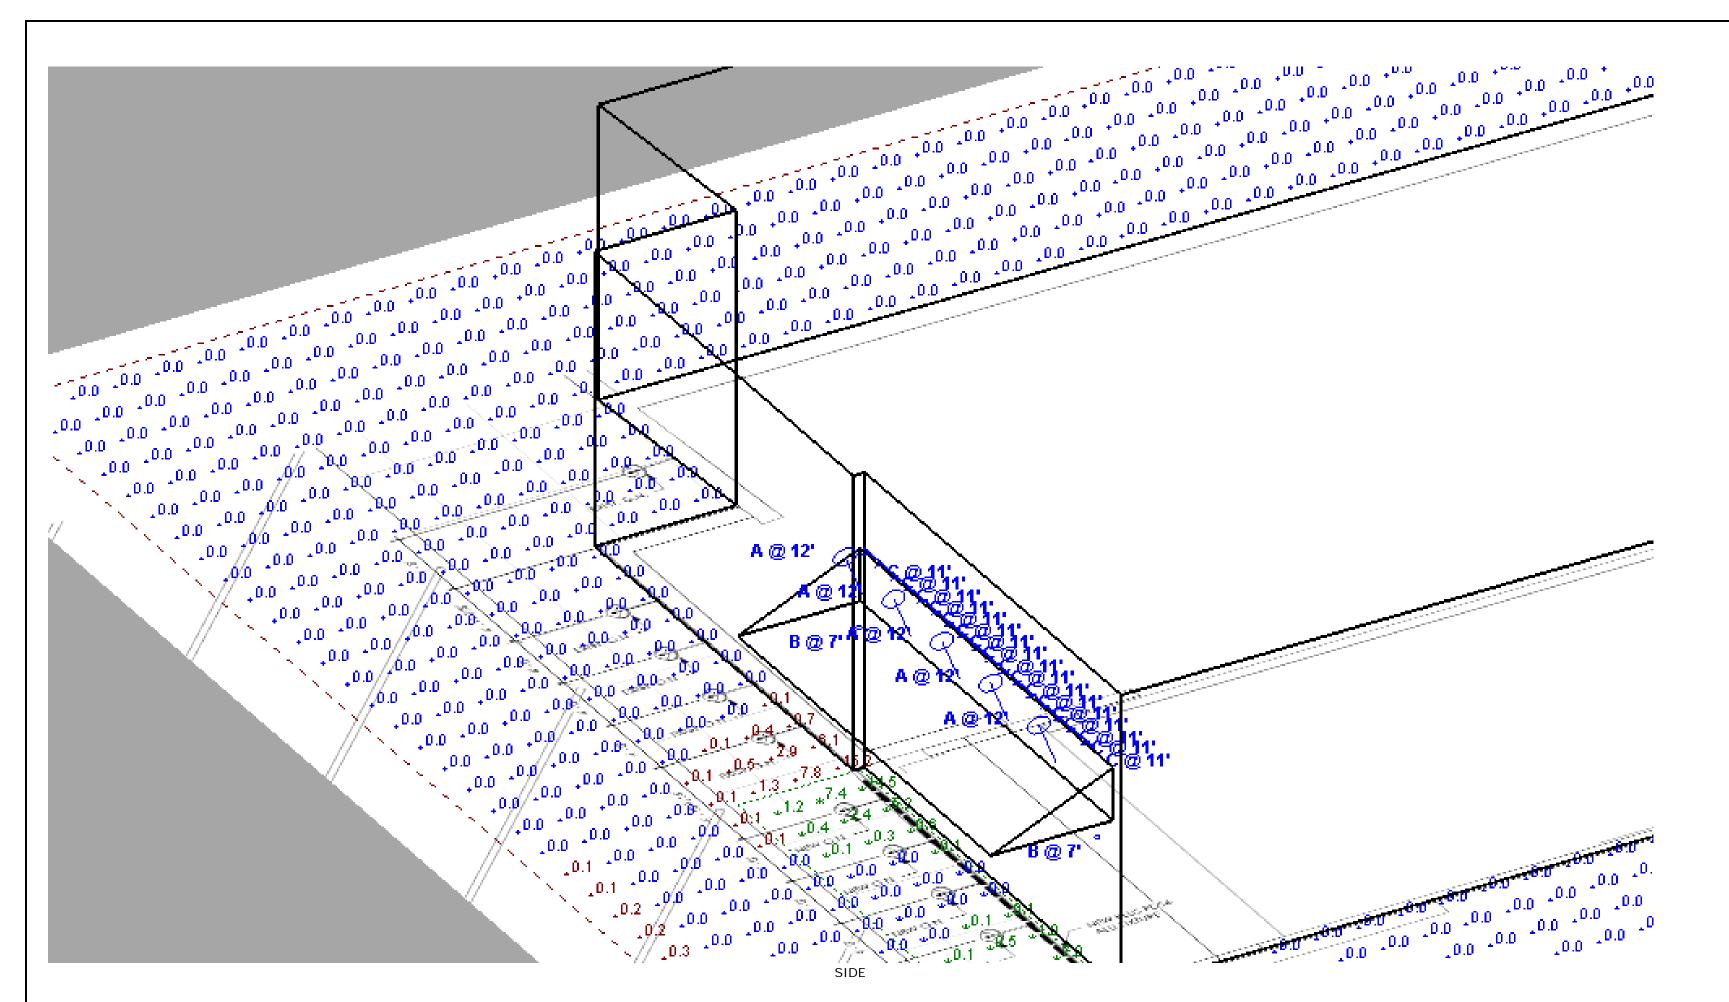

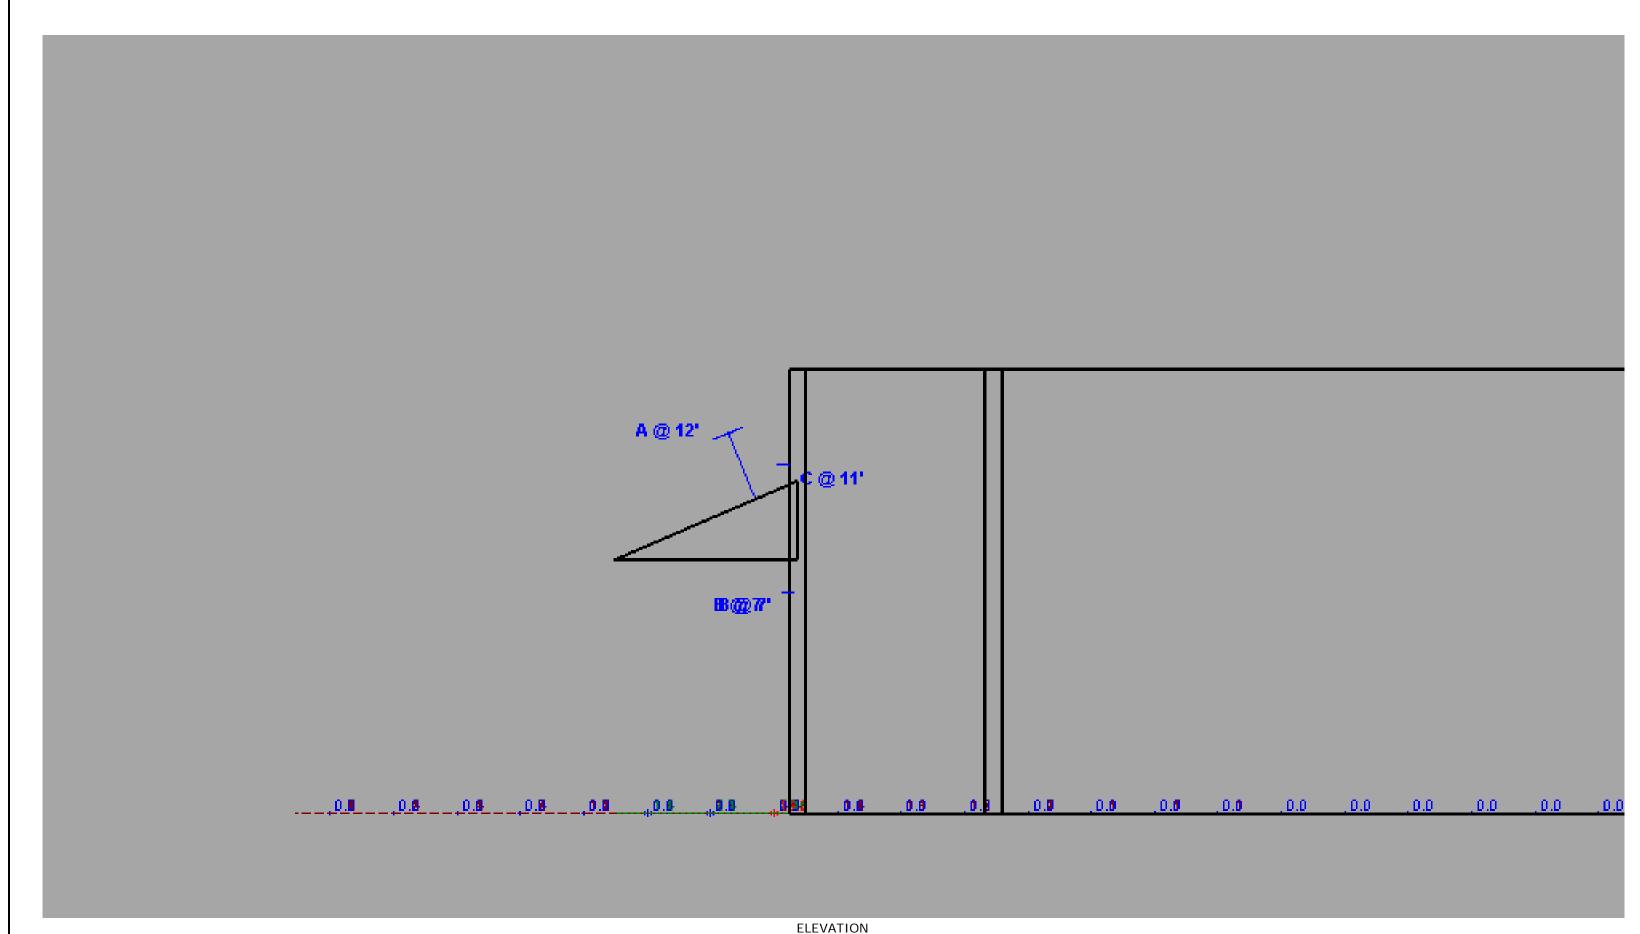

Schedul	e								
Symbol	Label	QTY	Catalog Number	Description	Lamp	Number Lamps	Lumens per Lamp	LLF	Wattage
	A	5	AR1214GV-27L-35K-EX- TF1-MWI	Angled Reflectot, 12" Nom. Diam Open Aperture x 14" H	N/A, Gen3	1	1830	0.9	18
	В	2		Nom. 3" Diam. x 10"H Direct Cylinder	N/A	1	505	0.9	6.2
	С	17	PDS-4-ALU (LED K-30- 1275 3000K)	Extrusion PDS-4-ALU with cover KA-PRO clear	LED 1x 12" 30cm K- 30-1275 3000K	1	350	0.9	4

Statistics							
Description	Symbol	Avg	Max	Min	Max/Min	Avg/Min	Avg/Max
BUILDING PERIMETER	+	0.1 fc	16.2 fc	0.0 fc	N/A	N/A	0.0:1
UNDER CANOPY	Ж	2.4 fc	16.2 fc	0.0 fc	N/A	N/A	0.1:1

1. SEE LUMINAIRE LABELS FOR MOUNTING HEIGHT. 2. CALCULATIONS ARE SHOWN IN FOOTCANDLES AT: 0' - 0"

THE ENGINEER AND/OR ARCHITECT MUST DETERMINE APPLICABILITY OF THE LAYOUT TO EXISTING / FUTURE FIELD CONDITIONS. THIS LIGHTING LAYOUT REPRESENTS ILLUMINATION LEVELS CALCULATED FROM LABORATORY DATA TAKEN UNDER CONTROLLED CONDITIONS IN ACCORDANCE WITH ILLUMINATING ENGINEERING SOCIETY APPROVED METHODS. ACTUAL PERFORMANCE OF ANY MANUFACTURER'S LUMINAIRE MAY VARY DUE TO VARIATION IN ELECTRICAL VOLTAGE, TOLERANCE IN LAMPS, AND OTHER VARIABLE FIELD CONDITIONS. MOUNTING HEIGHTS INDICATED ARE FROM GRADE AND/OR FLOOR UP.

THESE LIGHTING CALCULATIONS ARE NOT A SUBSTITUTE FOR INDEPENDENT ENGINEERING ANALYSIS OF LIGHTING SYSTEM SUITABILITY AND SAFETY. THE ENGINEER AND/OR ARCHITECT IS RESPONSIBLE TO REVIEW FOR MICHIGAN ENERGY CODE AND LIGHTING QUALITY COMPLIANCE.

UNLESS EXEMPT, PROJECT MUST COMPLY WITH LIGHTING CONTROLS REQUIRMENTS DEFINED IN ASHRAE 90.1 2013. FOR SPECIFIC INFORMATION CONTACT GBA CONTROLS GROUP AT ASG@GASSERBUSH.COM OR 734-266Ordering Note


6705.

HEIGHT.

FOR INQUIRIES CONTACT GASSER BUSH AT QUOTES@GASSERBUSH.COM OR 734-266-

Mounting Height Note MOUNTING HEIGHT IS MEASURED FROM GRADE TO FACE OF FIXTURE. POLE HEIGHT SHOULD BE CALCULATED AS THE MOUNTING HEIGHT LESS BASE

THIS DRAWING WAS GENERATED FROM AN ELECTRONIC IMAGE FOR ESTIMATION PURPOSE ONLY. LAYOUT TO BE VERIFIED IN FIELD BY OTHERS.

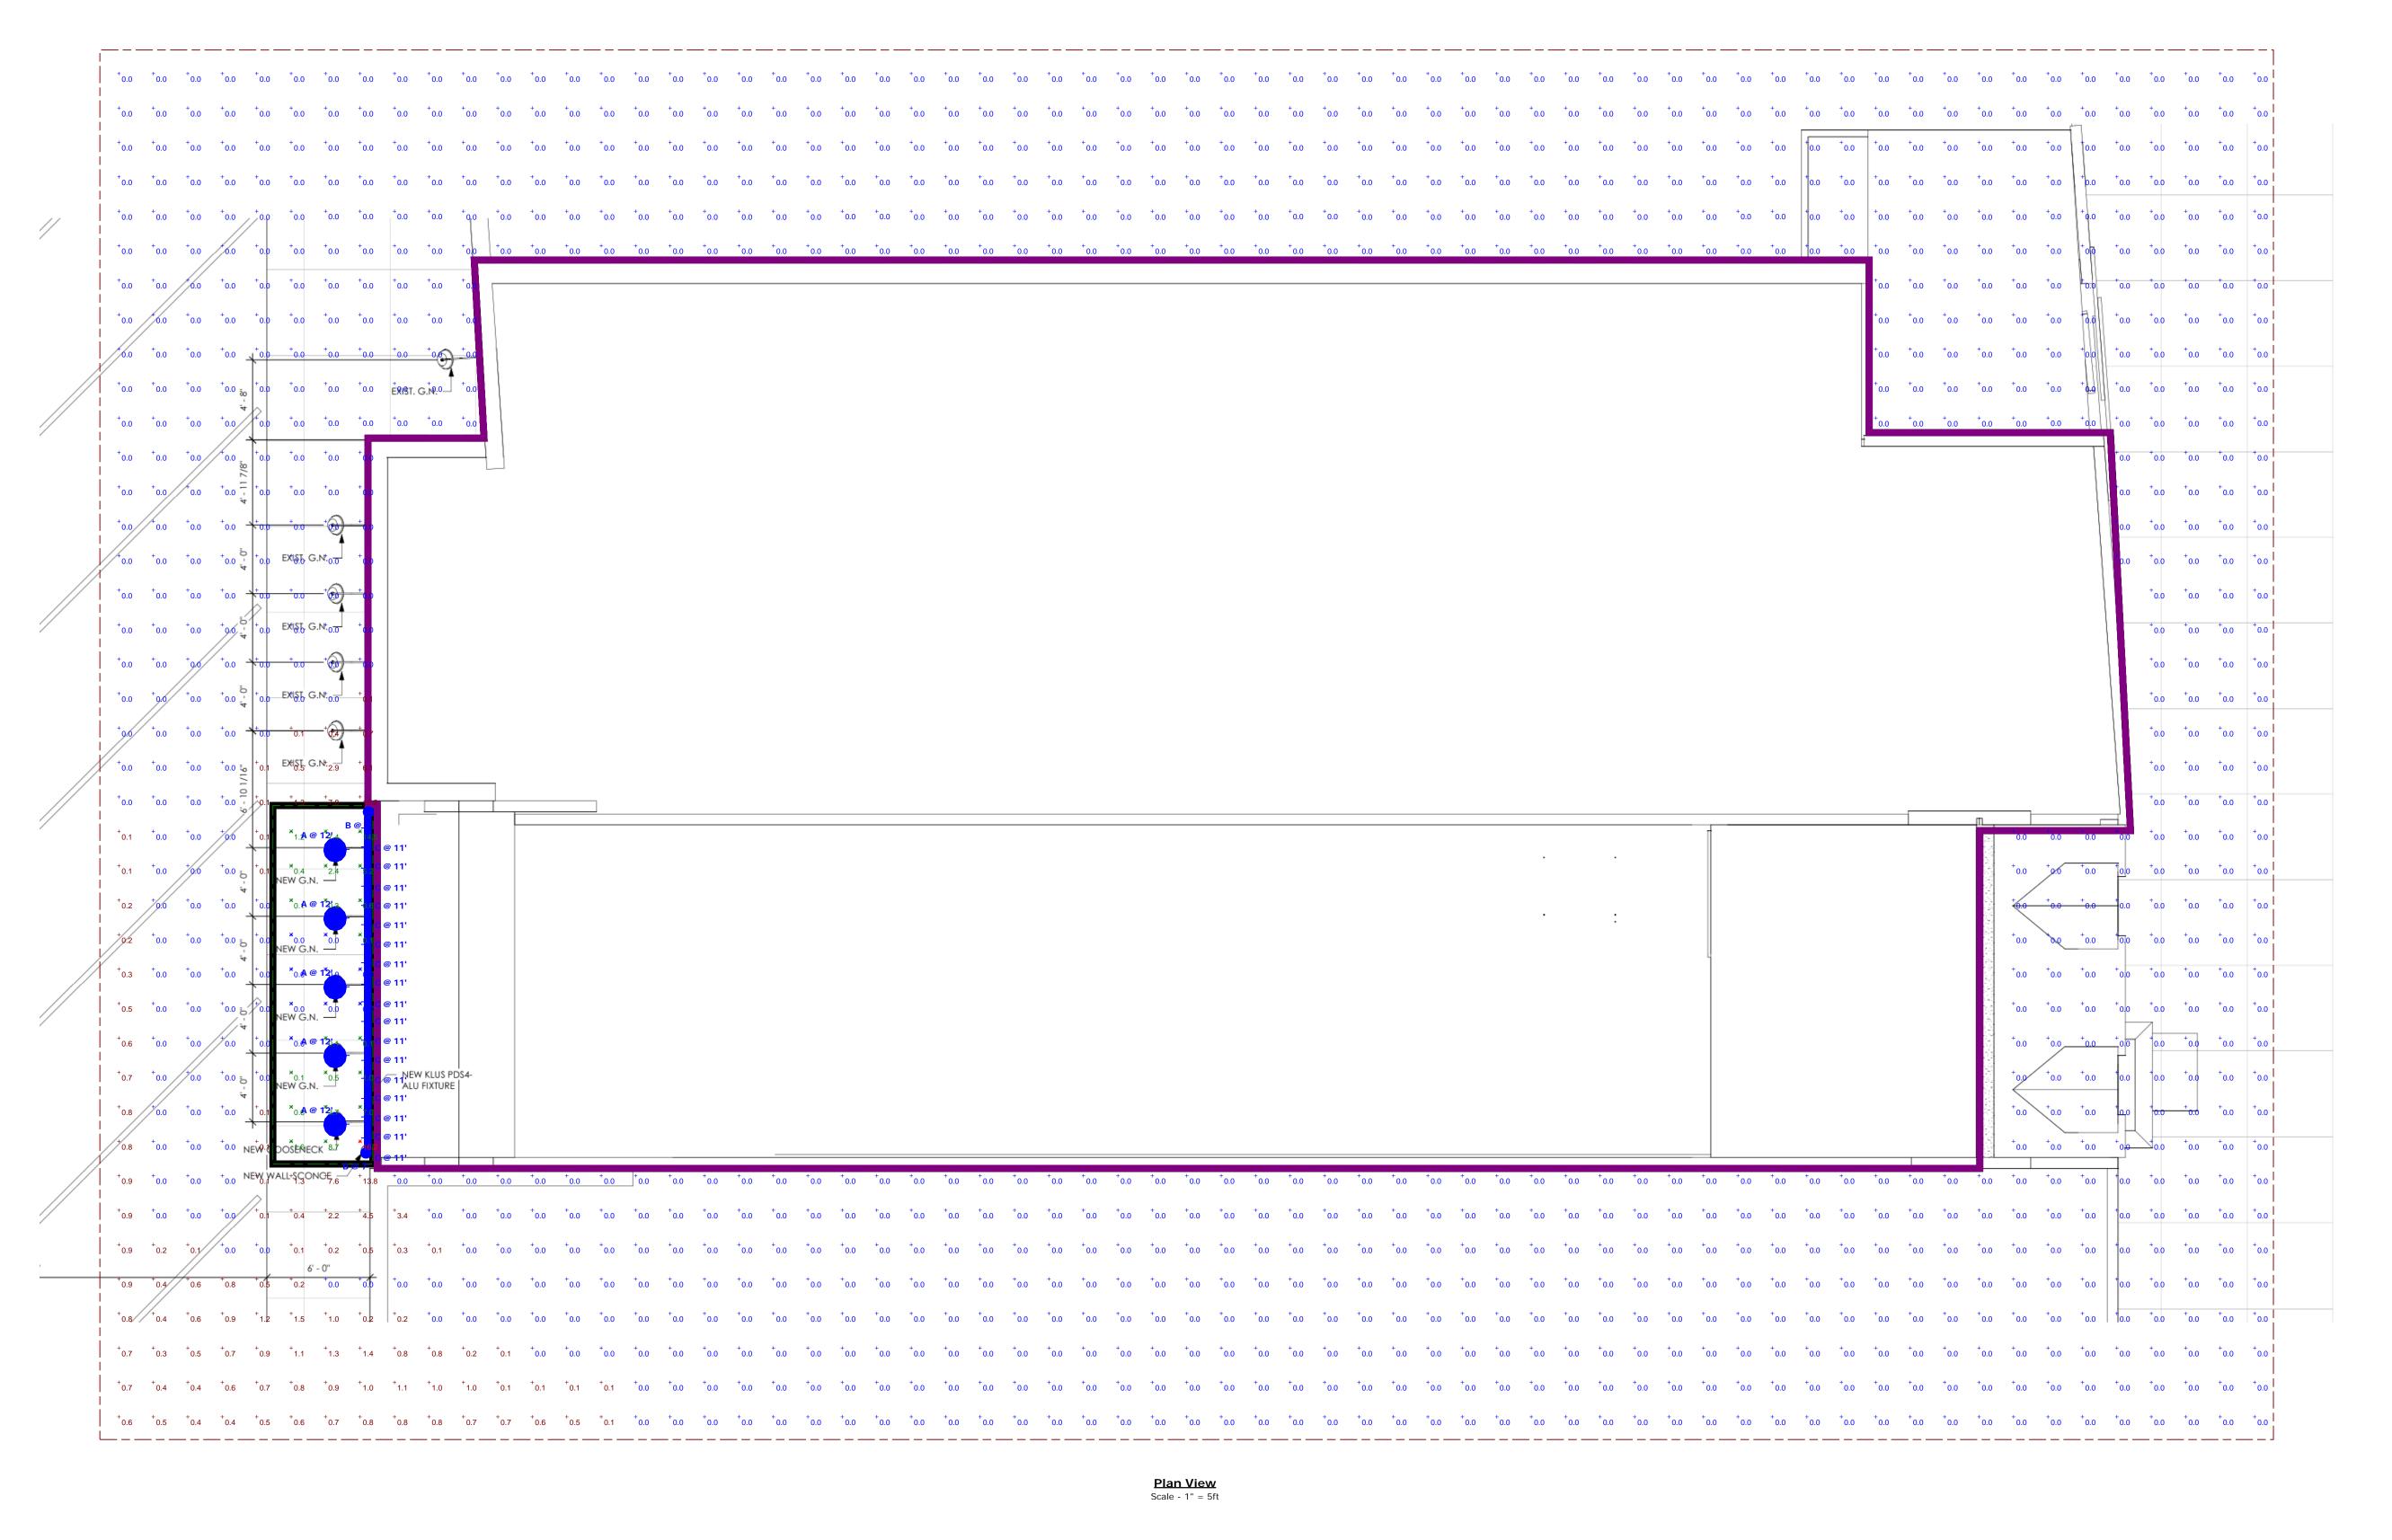



Non anodized (raw) Silver anodized Black anodized

metal and plastic mounting brackets, as well as adjustable mounting brackets

	Fill empty fields
Product nr.	
Fixture type	
Company	
Job name	
Date	

Designed to reach an IP67 waterproof rating

Housing for LED strips up to 0.39' / 10 mm wide

Ability to obtain a line of light

Good heat dissipation

FINISH:

For multiple applications

TECHNICAL SPECIFICATION

Application

- designed for the construction of lighting fixtures and backlighting luminaires. In furniture, exhibition, interior design elements like stair treads, platforms, shelves, niches, etc. - can be embedded in narrow grooves

- can be used for external illumination in the sealed version, except for applications where it would be exposed to considerable mechanical forces

- can be mounted with appropriately selected mounting adhesives, professional double-sided adhesive tapes,

More accessories on our page www.klusdesign.com





C0310UDXT - WALL MOUNT

3" round x 10" high direct / indirect wall luminaire for accent, area and ambient Spectrum's Cylinder series provides traditional architectural style with high performance and energy efficient illumination. Rugged design with flexible mounting, finish and LED options make these extremely versatile fixtures. Integral LED driver, Quick change LED module with interchangeable optics for job site flexibility and fixture upgrade.

Multi-stage polyester powder-coat process applied on our dedicated paint lines, See mounting and color pages for standard finishes. All exposed materials are chromate pretreated to resist corrosion. LED system features Xicato LED module with proprietary phosphor technology that

provides consistent stable color with CCT control of +/- 100K over life of the light engine.

Base CRI is 83 with 2-step MacAdam Ellipse binning. High CRI is 98 with 1 x 2-step MacAdam Ellipse binning. Variety of electronic 120V/277V and dimming drivers.

1 or 2 circuit operation. Fabricated seamless aluminum fixture housing. Specular primary optics provide high efficiency illumination. Stainless steel hardware with galvanized brackets to resist CODE COMPLIANCE BAA compliant, ETL certified to meet US and Canadian standards, Suitable for dry

or damp locations. Wet Location Option. Manufactured and tested to UL standards

10L 1000 Lm ND 22* 10L 1000 Lm ND 30* 30K 3000K D\$10X 10% 0-10V, Resistant PT* PI	Matte White Matte Black Platinum Silve Custom Colo
98 CRI LENS EMERGENCY BATTERY OPTIONS See	se Page 5
30HK 300K SQF Mirror Prism EMEN 7W Demote with Engine up Cold	full Range of plor Options 83-90095)

Ditmensions and values shown are nominal. Spectrum Lighting continually works to improve products and reserves the right to make changes which may after the performance or appearance of products.

WWW.SPECLIGHT.COM • 994 JEFFERSON STREET, FALL RIVER, MA 02721 • 508.678.2303 FAX 508.678.2260



SERIES	LU	MENS ¹	С	СТ		DRIVER / DIMMING ²	A	CCESSORIES ⁵		MOUNTING ⁷		FINISH14
AR0808LW	15L	1500 Lm	27K	2700K	EX	Electronic Driver, 120V/277V	TF1-	3" Frosted Dome		WALL MOUNT	MW	Matte White
AR1012LW AR1214LW	LLW 35K 3500K DO10X³ 1%, 0-10V, 120V/277V MF1 3" Frosted Mini 40K 400K DS2W1 ELV/MLV, 120V MG1 3" Short Wire Gu DLTE1* Lutron* 2-Wire Forward Phase FJ1 3" Frosted Toll	35K 3500K DO10X* 1%, 0-10V, 120V/277V MF1 3" Frosted Mini 40K 4000K DS2W1 ELV/MLV, 120V MG1 3" Short Wire Guard C	35K 3500K DO10X ² 1%, 0-10V, 120V/277V MF1 3" Frosted Mini CP10 40K 4000K DS2W1 ELV/MLV, 120V MG1 3" Short Wire Guard CP6/RN	\$10%, 0-10V, 120V/277V TG1 3" Dome Wire Guard CP104" Sma \$100000 19%, 0-10V, 120V/277V MF1 3" Frosted Mini CP106" Larg \$2001 ELV/MEV, 120V MG1 3" Short Wire Guard CP6/RMD Rem	Small Driver Canopy Large Driver Canopy Remote Mount Driver Mounting Arm Style	PT° CC	Matte Black Platinum Silv Custom Col ee Page 5					
	П				DIREY	(MLV), 120V 1%, Lutron® EcoSystem®,	10.000	3" Tall Wire Guard		CEILING MOUNT	for	full Range of
					oue.	Fades to Black, 120V/277V			CP13 PM ^{10/11} HM ^{10/11/12} EMCR ¹³ EMRM	Small Driver Canopy Large Driver Canopy Rigid Pendant Mount Hang Straight 10W Large Driver Canopy EM 7W Remote Wth Enclosure		olor Options

6/12/2020 Not to Scale Drawing No. #20-50936 V1



Final Design Review Application – Design Review Board Planning Division

Name: Krieger Klatt Architects / Jason Krieger	Name: Jerry Mills
Address: 2120 E. 11 Mile Road, Royal Oak , MI 48067	Address: 737 Kensignton Lane, Bloomfield Hills, MI 48304
Phone Number: 248-414-9270	Phone Number: 248-421-1101
Fax Number: 248-414-9275	Fax Number: N/A
Email Address: jason@kriegerklatt.com	Email Address: jerry@millspills.com
2. Applicant's Attorney/Contact Person	Project Designer/Developer
Name: Jason Krieger	Name: Studio H2G
Address: 2120 E. 11 Mile Road, Royal Oak , MI 48067	Address: 2299 E Lincoln, Birmingham, MI 48009
Phone Number: 248-414-9270	Phone Number: 248-220-3064
Fax Number: 248-414-9275	Fax Number: N/A
Email Address: jason@kriegerklatt.com	Email Address: ngiammarco@studioh2g.com
3. Required Attachments	
	Ten (10) folded copies of scaled plans including site plan and color elevations showing all materials and an itemized list of all changes for which approval is requested with the changes marked in color Required fee (see Fee Schedule for applicable amount) One (1) Digital set of plans
4. Project Information	
Address/Location of Property:	Name of Historic District site is in, if any:
1740 W. Maple, Birmingham, MI, 48009	Date of Planning Board Approval, if any:
Name of Development: Holiday Market Select	Date of DRB Approval, if any:
Sidwell #:	
Current Use: Grocery / Food to Go	
Proposed Use: No Change	
Area in Acres:	
Current Zoning: B-1	
5. Details of the Nature of Work Proposed (Attach s (Please specifically list all materials and colors to be used)	separate sheet if necessary)
Extension of parapet w/reclaimed wood to match existing.	New mesh metal crown. New trim above canopy with
	conces. Existing brick to be covered by wood cladding (painte
black. Existing Trim to be painted. Existing door painted. Nev	w lights above canopy. Existing door to be closed off.

6. Buildings and Structures

Number of Buildings on site: Holiday Market Select	Use of Buildings: Grocery / Food to go
7. Addition	
Proposed use: Number of floors: Number of sq. ft. on each floor: Retail space in sq. ft.: Assembly space in sq. ft.:	Industrial space in sq. ft.:
8. Landscaping	
Location of landscape areas: None	
17. D. '11' L'.14'	
17. Building Lighting	W #6
Number of light standards on building: 3 Size of light fixtures (LxWxH): SEE PHOTOMETRIC	Type of light standards on building: Wall Sconce, LED Strip, Gooseneck Height from grade: 6'-6" Wall Sconce 13'-6" Gooseneck [Match Existing], 12'-0" & 17'-4 3/4" LED Strip
Maximum wattage per fixture: Light level at each property line: SEE PHOTOMETRIC	Proposed wattage per fixture: 6.2, 4,18 Number & location of holiday tree lighting receptacles: None



The undersigned states the above information is true and correct, and <u>understands that it is the responsibility of the applicant to advise the Planning Division and / or Building Division of any additional changes made to an approved site plan.</u> The undersigned further states that they have reviewed the procedures and guidelines for site plan review in Birmingham, and have complied with same. The undersigned will be in attendance at the Planning Board meeting when this application will be discussed.

Date of Approval:	Date of Denial:	Accepted by:	
Application #:	Date Received:	Fee:	
	Office Use On	ly	
Signature of Architect:	eger	Date:	8/2020
Signature of Applicants		Date: 6/8	18080
Signature of Owner: Print Name: JERomé D.	Miles	وسار ساد المسادة والمادة والما	
Signature of Owner:	e O. Mills	Date: <u>6-3</u>	-20



Transmittal

0 1)"			Design Review Board			
Sent Via:	☐ Mail	☐ Express Mail	☐ Hand Delivered	Fax		
Enclosed her	ewith, please find	the following:				
	eview and appro		Per your request			
☐ For your re			☐ For your use			
			,			
COPIES	DESCRIPTION					
10 Sets	Exterior Faça	Exterior Façade Architectural Sheets				
10 Sets	Exterior Faça	Exterior Façade Design Sheets				
10 Sets	Photometric	Photometric Plan (Light Specifications included)				
10 00.0		Transmittal				
1	Transmittal					
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MEMORANDUM

Planning Divisions

DATE: July 1st, 2020

TO: Design Review Board

FROM: Nicholas Dupuis, City Planner

SUBJECT: Murals & Public Art – Study Session

The Planning Division has received several requests recently for the installation of murals on private buildings. Traditionally, the City has considered a mural as a type of sign, and uses the Sign Ordinance (and the definition of Sign) to justify that stance:

... "Any object, device, logo, display or structure, or part thereof, which is intended to advertise, identify, display, or direct or attract attention to an object, person, institution, organization, business, product, service, event or location by any means."

As murals have begun to proliferate themselves as a valid form of public art, numerous cities and downtowns have utilized murals to activate dead space, express cultural heritage, foster civic pride, and provide an enhanced urban experience for residents and visitors alike.

FERNDALE, M








ROYAL OAK, MI



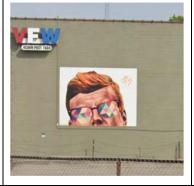



BERKLEY, MI







The City's stance that a mural is a form of signage essentially rules them out all together for the following reasons:

- 1. Buildings are allowed a combined sign area that may not exceed 1 sq. ft. (1.5 sq. ft. for Woodward addresses) per 1 ln. ft. of principal building frontage. With murals considered a sign, the combined sign area would be exceeded, and in most cases exceeded generously.
- 2. The Sign Ordinance does not permit signs to be painted directly onto the building surface.

At this time, City Staff feels as though murals should be reconsidered and separated from signage within the Sign Ordinance. The attached amendments to the Sign Ordinance are changes proposed to do just that, addressing several different sections relevant to the issue.

City Staff also understand that there must be additional amendments made to the full Zoning Ordinance to provide a review process and specific standards for murals and public art placed on private buildings. Sections such as the Via Activation Overlay District encourage the use of art to activate the City's network of alleys and passages, but do not outline standards for such. More specific standards will need to be added. These amendments will also address which public review body (or bodies) will be a part of the review process. At this time the Design Review Board, Historic District Commission and Public Arts Board are the likely candidates.

Suggested Action:

To recommend approval to the City Commission the proposed amendments to Articles 1 and 3 of the Sign Ordinance to amend the Sign Requirements and add the definitions of Mural and Public Art.

CITY OF BIRMINGHAM

ORDINANCE NO
THE CITY OF BIRMINGHAM ORDAINS:
AN ORDINANCE TO AMEND THE SIGN ORDINANCE OF THE CITY OF BIRMINGHAM:
TO AMEND ARTICLE 1, SECTION 1.03 (D), SIGN REQUIREMENTS, TO AMEND PAINTED SIGNS
1.03 Sign Requirements
This Sign Requirements section applies to the following districts:
PP R1A R1 R2 R3 R4 R5 R6 R7 R8 O1 O2 B1 B2 B2B B2C B3 B4 MX
The following sign requirements apply:
 A. <u>Illumination.</u>(no changes) B. <u>Obscene Matter.</u>(no changes) C. <u>Obstructions.</u>(no changes) D. <u>Painted Signs.</u> No sign may be painted directly onto any building surface. For the purposes of this Chapter, murals and other forms of public art are no considered signs.
ORDAINED this day of, 2020 to become effective upon publication.
Pierre Boutros, Mayor
Alexandria Bingham, City Clerk Appointee

CITY OF BIRMINGHAM

ORDINANCE NO. _____

THE CITY OF BIRMINGHAM ORDAINS:
AN ORDINANCE TO AMEND THE SIGN ORDINANCE OF THE CITY OF BIRMINGHAM:
TO AMEND ARTICLE 3, SECTION 3.02, DEFINITIONS, TO AMEND THE LIST OF DEFINITIONS TO INCLUDE A NEW DEFINITION FOR MURAL AND PUBLIC ART.
3.02 Definitions
<u>Light Box Sign</u> : A permanent wall mounted sign with an exposed frame, a translucent face, and internal illumination
Monument Sign: See Ground Sign.
<u>Mural</u> : A painting or other work of art executed directly on a wall that contains no advertisements, products, or service offerings for a commercial enterprise.
Name Letter Sign: A sign composed of individually constructed and applied letters, numbers, or characters, which may or may not include an electrical raceway.
<u>Projecting Sign</u> : A sign which extends beyond the building wall, where the horizontal sign surface is not parallel to the building wall.
<u>Public Art</u> : Works of art in any media, which are exhibited in a public space including publicly accessible buildings.
Rear Entry Sign: A wall sign which is located near the rear entry door on a building
ORDAINED this day of, 2020 to become effective upon publication.
Pierre Boutros, Mayor
Alexandria Bingham, City Clerk Appointee

CITY OF BIRMINGHAM
Date 06/05/2020 10:34:42 AM
Ref 00169497
Receipt 534837
Amount \$100.00



Administrative Sign Approval Application Planning Division

Form will not be processed until it is completely filled out.




1.	Applicant Name: Soventia Ham S Address: 1324 Whitehave Ct Dochester Hills M 1 48306 Phone Number: 248 259 0974 Fax Number: Email Address: Soventiassalungmail Con		Property Owner Name: Address: 177 Then with 1970 Phone Number: 248 229 1375 Fax Number: Email Address: MCOPT FSF 7 & Canada
3.	Applicant's Attorney/Contact Person Name:	4.	Project Designer/Developer Name: Stivels Design Studio Address: 25505 7 Mile road Pedford M. 48240 Phone Number: 313 289 0152 Fax Number: Email Address: Stixelz Ogmal. Com
5.	Project Information Address/Location of Property: 588 N.O.C. Name of Development: Parcel ID#: Current Use: Area in Acres: Current Zoning:		Name of Historic District if any: Date of HDC Approval, if any: Date of Application for Preliminary Site Plan: Date of Preliminary Site Plan Approval: Date of Application for Final Site Plan: Date of Final Site Plan Approval: Date of Revised Final Site Plan Approval:
6.	Required Attachments Two (2) folded paper copies of plans including details of the following: Dimensions of proposed sign(s) Dimensions of building frontage Illumination Height from grade		 Location of proposed sign(s) Colors and materials Authorization from Property Owner(s) (if applicant is not the owner) Material Samples Digital Copy of Plans
7.	Details of the Request for Administrative Appro Projected Sign 2FT X bFT Al Mainted to the Wall	val	inum Brush Letters Stud
8.	Location of Proposed Sign(s) 588 N. Old Woodward Bir	m	mg/mm M1 48009
9.	Type of Proposed Sign(s) Wall: Soventias Salon Ground: Name Letter: Canopy:	Proj Buil	ecting (Post-Mounted):ecting (Wall-Mounted)ding Identification:er:



CONSENT OF PROPERTY OWNER

I, Jucia Contese, OF THE STATE OF Michigan AND (Name of Property Owner)
COUNTY OF DAIC MA STATE THE FOLLOWING:
1. That I am the owner of real estate located at 588 N. Dlawood Ward; (Address of Affected Property)
2. That I have read and examined the Application for Administrative Approval made to the City of
Birmingham by: Sovertia T. Harrs; (Name of Applicant)
3. That I have no objections to, and consent to the request(s) described in the Application made to the City of
Birmingham.
By providing your e-mail to the City, you agree to receive news notifications from the City. If you do not wish to receive these messages, you may unsubscribe at any time.
Name of Owner (Printed): Lycia Cortese
Signature of Owner: Accie Cortese Date: 5/16/20

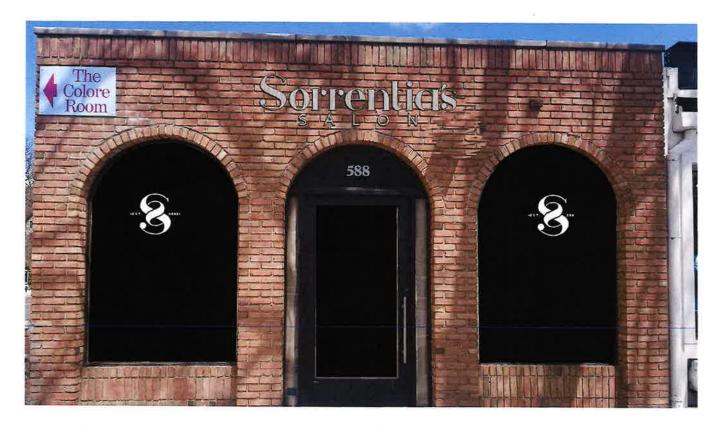

6 ft

Sorrentias

letters to be aluminum brushed finish stud mounted to wall





CITY OF BIRMINGHAM

Date 86/17/2020 9:58:52 AM

Ref 00169831

Receipt 535317

Amount \$100.00

Administrative Approval Application Planning Division

APPROVED 6/17/200

Form will not be processed until it is completely filled out.

1.	Applicant Name: Exclusive Custom Homes	2.	Property Owner
	Address: 1550 North Milford rd Suite 102A		Name: David and Amy Vazquez Address: 449 North Eton Unit #507
	ASISI MI 40004		Birmingham MI 48009
	Phone Number: 248-310-4590		Phone Number: 248-798-5479
	Fax Number:		Fay Number:
	Fax Number: Email Address: rick@ricklindbeckdesign.com		Fax Number: Email Address:
	Limin i regioni.		Email Additions.
3.	Applicant's Attorney/Contact Person Name: Matt Hewson - Builder Address:	4.	Project Designer/Developer Name: Address:
	Phone Number: 248-752-2612		Phone Number:
	Fax Number:		Fax Number:
	Email Address:		Email Address:
5.	Project Information		
٠.	Address/Location of Property: 449 North Eton Unit #507		Name of Historic District if any: N/A
	Birmingham MI 48009		Date of HDC Approval, if any: N/A
	Name of Development:		Date of Application for Preliminary Site Plan: N/A
	Parcel ID#:		Date of Preliminary Site Plan Approval: N/A
	Current Use:		Date of Application for Final Site Plan: N/A
	Area in Acres:		Date of Final Site Plan Approval: N/A
	Current Zoning:		Date of Revised Final Site Plan Approval: N/A
6.	Required Attachments		
•	Warranty Deed with legal description of property		• One (1) digital copy of plans
	 Authorization from Owner(s) (if applicant is not 		• Two (2) folded copies of plans including an
	owner)		itemized list of all changes for which
	 Completed Checklist 		administrative approval is requested, with the
	 Material Samples 		changes marked in color on all elevations
	 Specification sheets for all proposed materials, fixtures, and/or mechanical equipment 		 Photographs of existing conditions on the site where changes are proposed
7.	Details of the Request for Administrative Approach Add two bath van vents on exterior	oval	
	The undersigned states the above information is true an	ıd coı	rrect, and understands that it is the responsibility of the
	applicant to advise the Planning Division and/or Building	g Div	ision of any additional changes to the approved site plan.
	Signature of Applicant:		Date; 6/11/20
	Application #: PAA-20 -00 33 Date Received:		Only 1712020 Fee: \$100.00
	Date of Approval: 6 17-1360 Date of Denial:	~	Reviewed By:



Administrative Approval Application Planning Division

Form will not be processed until it is completely filled out.

1.	Applicant Name: Exclusive Custom Homes Address: 1550 North Miliford nd Suite 102A	2.	Property Owner Name: David and Arny Vazquez
	SEPANAL AND APPROPRIATE TO A SEPANAL AND A S	é	Address: 449 North Eton Unit #507
	Phone Number: 248-310-4590		Birminghum MI 48009
	Fay Number		Phone Number: 248-768-5479
	Fax Number: Email Address: rick@rickfindbeckdesign.com		Fax Number:
	Elitali Addiess.		Email Address:
3.	Applicant's Attorney/Contact Person Name: Matt Howson - Builder Address:	4.	Project Designer/Developer Name: Address:
	Address:		Address:
	Phone Number: 248-752-2812		
	Fax Number:		Phone Number:
	Email Address:		Fax Number:Email Address:
5.	Project Information		
	Address/Location of Property: 449 North Eton Unit #507		Name of Historic District if any: NA
	Name of Development:		Date of HDC Approval, if any: NA
	Name of Development:		Date of Application for Preliminary Site Plan: NA
	rarcel ID#:		Date of Preliminary Site Plan Approval: NA
			Date of Application for Final Site Plan: NA
	11.44 11.710100.		Date of Final Site Plan Approval: NA
	Current Zoning:		Date of Revised Final Site Plan Approval: NA
_	Dominad 6th along		
6.	1-11-11-11-11-11-11-11-11-11-11-11-11-1		
	 Warranty Deed with legal description of property 		 One (1) digital copy of plans
	 Authorization from Owner(s) (if applicant is not owner) 		Two (2) folded copies of plans including an itemized list of all changes for which
	 Completed Checklist 		administrative approval is requested, with the
	Material Samples		changes marked in color on all elevations
	Specification sheets for all proposed materials,		Photographs of existing conditions on the site
	fixtures, and/or mechanical equipment		where changes are proposed
7.	Details of the Request for Administrative Appro	val	
	The undersigned states the above information is true an applicant to advise the Planning Division and/or Building	d cor	rect, and understands that it is the responsibility of the sion of any additional changes to the approved site plan.
	Signature of Applicant		Date: 8/11/20
	Office	Use	Only
	Application #: Date Received:		221.51
	Date of Approval: Date of Denial:		Reviewed By:




CONSENT OF PROPERTY OWNER

I, Any K-Vay, UPZ , OF THE STATE OF MICHIGAN AND
COUNTY OF OAKLAND STATE THE FOLLOWING:
1. That I am the owner of real estate located at 449 N.Etm St. #507 (Address of Affected Property) (Address of Affected Property)
2. That I have read and examined the Application for Administrative Approval made to the City of
Birmingham by: Exclusive Custom Homes ; (Name of Applicant)
3. That I have no objections to, and consent to the request(s) described in the Application made to the City of
Birmingham.
By providing your e-mail to the City, you agree to receive news notifications from the City. If you do not wish to receive these messages, you may unsubscribe at any time.
Name of Owner (Printed): Amy K-Vazguez
Signature of Owner: Date: 6.11.20








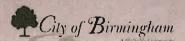

Administrative Approval Application Planning Division


Form will not be processed until it is completely filled out.

1.	Applicant 2	u u is completely julea out. Property Owner
	Name: GRACO BLOG, CORP,	Name: JOHN S. REINHAPT
	Address: 6025 WALL ST	Address: 9 MANORWOOD, BL. HILLS MI
	STEELING HET'S, MI 48312	redices. The occords by the same
	Phone Number: 586, 699, 8347	Phone Number: 313 - 919 - 3313
	Email Address: DERAHAME ERACOBULDINGCO	Finail Address: + Cas Hall Communication
	Con	A LEMM Address, 33 PRINTER & GIANTET COM
3		Brainet Designar/Designar
	Name: SAME AS ABOVE	. Project Designer/Developer
	Address:	Name: LUCKEN BACH, ZHEGERNAN, GARNER PL
	Address.	Address: 555 3.000 wooduged
	Phone Number:	ni 11 1 200 / /// 2200
	E- br t	Phone Number: 248. 644 · 3990
	Email Address:	Fax Number:
	Email Address.	Email Address: GRONGE - ARCH 1@ SBCOWRE. NE
_	Design A to Consult	
5.	Project Information	
	Address/Location of Property: 555 S. NO WORLD	Name of Historic District if any:
		Date of HDC Approval, if any:
	Name of Development:	Date of Application for Preliminary Site Plan: N/A
	Parcel ID#:	Date of Preliminary Site Plan Approval:
	Current Use: OREICES/GOLF STUDIO	Date of Application for Final Site Plan:
	Area in Acres:	Date of Final Site Plan Approval:
	Current Zoning:	Date of Revised Final Site Plan Approval:
6.	Required Attachments	
	Warranty Deed with legal description of property	0
		One (1) digital copy of plans
	• Authorization from Owner(s) (if applicant is not	 Two (2) folded copies of plans including an
	owner)	itemized list of all changes for which
	Completed Checklist	administrative approval is requested, with the
	Material Samples	changes marked in color on all elevations
	Specification sheets for all proposed materials,	Photographs of existing conditions on the site
	fixtures, and/or mechanical equipment	where changes are proposed
7.	Details of the Request for Administrative Approva	
٠.	NEW ENTRY INTO ATM ROOM FO	Eugen " 010'
	DAM ELLIN HOW L	sein - Vield of prine.
		The second secon
	The undersigned states the above information is true and c	orwest and understands that it is the control in
	applicant to advise the District Division and/or Division Di	orrect, and understands that it is the responsibility of the
	applicant to advise the Planning Division and/or Building Di	ivision of any auditional changes to the approved site plan.
	Sint State Marille	Date: 6.18.20
	Signature of Applicant: Naud U. Sul	Date: 6.10.00
	PAAR Office Us	
	Application #: PAA-20 - 005 3 Date Received: 6	/12/200 Fee: \$100-go
110	Date of Approval: 6/19/200 Date of Denial:	N/A Reviewed By:

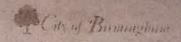

CONSENT OF PROPERTY OWNER

John S. Keinhart (Name of Property Owner)	, OF THE STATE OF	MI	AND
COUNTY OF OMKLOND	STATE THE FOLLOWIN	IG:	
		555 Com	
1. That I am the owner of real estate loca	ned at	Old Woods ess of Affected Property)	weed
2. That I have read and examined the Ap	plication for Administrativ	e Approval made to th	e Cirvini
Dirmingham by: David A	I Sul-PRE		
(Na	me of Applicant)		
3. That I have no objections to, and consc	ent to the request(s) describ	sed in the Application	made to the Ciry
Birmingham,			
By probiding your s-mail to the City, you agree to these mussages	o recaive news notifications f s, you may unsubscribe at an	rom the City. If you do n y time.	i ot wish to passiva
one of Owner (Printed): John). Keinhart		
21 24	.0_		
conture of Owner: John He	enant	Date:	

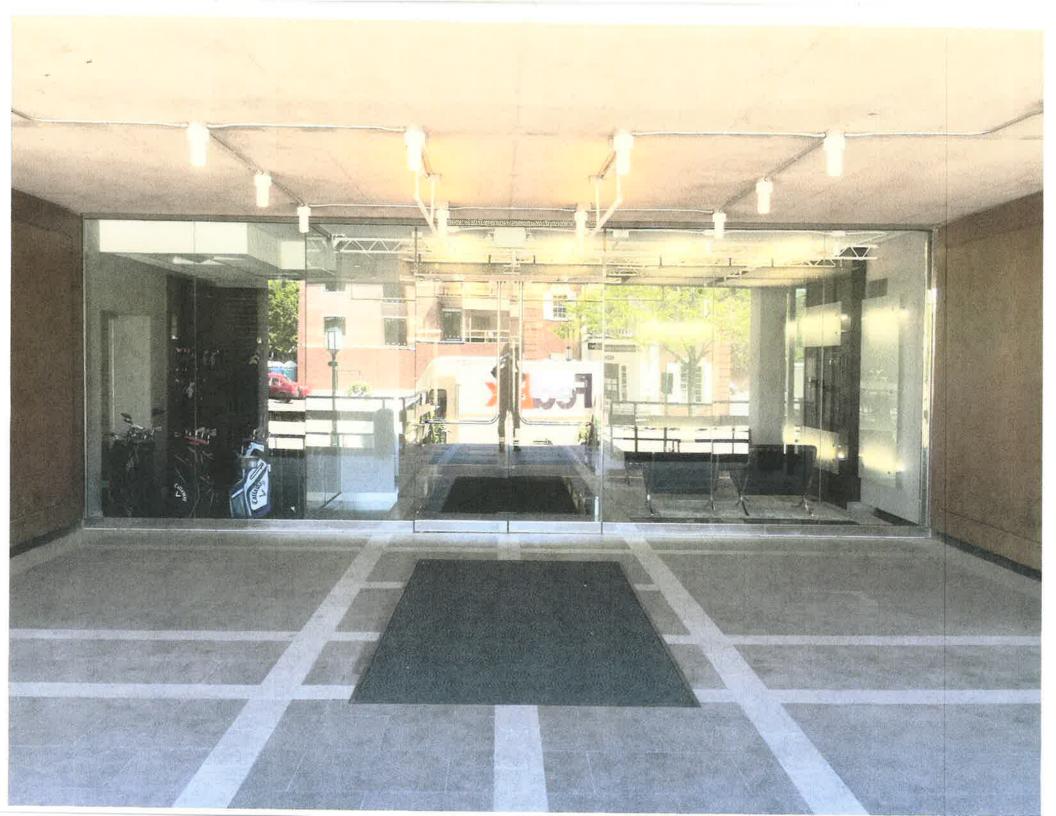

Design Review Board Action List – 2020

Design Review Board	Quarter	Rank	Status
Redesign/Update DRB Board Applications	1 st (January-March)	1	
Update Sign Ordinance	2 nd (April-June)	2	
Create New Informational Artwork for Sign Ordinance	3 rd (July-September)	3	
Sign Ordinance Enforcement	4 th (October-December)	4	

Updates:

- 1. Updated Design Review application as of June 2020
 - a. Simplified, reformatted, and trimmed unnecessary sections
 - b. Updated PDF to be a fillable form