

The City recommends members of the public wear a mask if they have been exposed to COVID-19 or have a respiratory illness. City staff, City Commission and all board and committee members must wear a mask if they have been exposed to COVID-19 or actively have a respiratory illness. The City continues to provide KN-95 respirators and triple layered masks for attendees.

- 1) Roll Call
- 2) Approval of the HDC Minutes of November 16, 2022
- 3) Courtesy Review
- 4) Historic Design Review
 - A. 320 Martin St. Birmingham Post Office
- 5) Sign Review
- 6) Study Session
 - A. Historic Design Guidelines Update
- 7) Miscellaneous Business and Communication
 - A. Pre-Application Discussions
 - **B.** Draft Agenda
 - 1. December 21, 2022
 - C. Staff Reports
 - 1. Administrative Sign Approvals
 - 2. Administrative Approvals
 - 3. Demolitions
 - 4. Action List 2022
- 8) Adjournment

Link to Access Virtual Meeting: https://zoom.us/j/91282479817

Telephone Meeting Access: 877 853 5247 US Toll-free

Meeting ID Code: 912 8247 9817

<u>Notice:</u> Individuals requiring accommodations, such as interpreter services for effective participation in this meeting should contact the City Clerk's Office at (248) 530-1880 at least on day in advance of the public meeting.

Las personas que requieren alojamiento, tales como servicios de interpretación, la participación efectiva en esta reunión deben ponerse en contacto con la Oficina del Secretario Municipal al (248) 530-1880 por lo menos el día antes de la reunión pública. (Title VI of the Civil Rights Act of 1964).

A PERSON DESIGNATED WITH THE AUTHORITY TO MAKE DECISIONS MUST BE PRESENT AT THE MEETING.

^{*}Please note that board meetings will be conducted in person once again. Members of the public can attend in person at Birmingham City Hall, 151 Martin St., OR may attend virtually at:

Historic District Commission Minutes Of November 16, 2022

151 Martin Street, City Commission Room 205, Birmingham, MI

Minutes of the regular meeting of the Historic District Commission ("HDC") held Wednesday, November 16, 2022. PD Dupuis called the meeting to order at 7:00 p.m.

1) Rollcall

Present: Board Members Gigi Debbrecht, Natalia Dukas, Patricia Lang, Michael

Willoughby; Alternate Board Member Steven Lemberg; Student Representative

Charlie Vercellone

Absent: Chair John Henke; Board Members Keith Deyer, Dustin Kolo; Student

Representative Meghan Murray

Staff: Planning Director Dupuis; City Transcriptionist Eichenhorn

Noting the absence of the Chair and Vice-Chair, PD Dupuis asked the HDC to elect an acting chair to facilitate the meeting.

11-62-22

Motion by Ms. Dukas

Seconded by Ms. Lang to nominate Michael Willoughby to serve as acting chair for the duration of the meeting.

Motion carried, 5-0.

VOICE VOTE

Yeas: Dukas, Debbrecht, Willoughby, Lemberg, Lang

Nays: None

2) Approval of the HDC Minutes of October 19, 2022

11-63-22

Motion by Ms. Dukas

Seconded by Ms. Debbrecht to approve the HDC Minutes of October 19, 2022 as submitted.

Motion carried, 5-0.

VOICE VOTE

Yeas: Dukas, Debbrecht, Willoughby, Lemberg, Lang

Nays: None

3) Courtesy Review

4) Historic Design Review

Historic District Commission Minutes of November 16, 2022

5) Sign Review

6) Study Session

A. Historic Design Guidelines – Update

PD Dupuis stated that the next deliverable in the process would be available in December 2022 or January 2023.

7) Miscellaneous Business and Communication

A. Pre-Application Discussions

1. 320 Martin – Birmingham Post Office

Kevin Biddison, architect, and Sam Surnow, developer, spoke regarding proposed changes to the project. Mr. Biddison explained the proposed changes would entail the first column at the entry sliding south, the addition of another column, the moving of the barrier-free entrance to Martin, the raising of the level of the entry floor to the current level of the post office floor, and the expansion of the building five feet to the west on the third, fourth, and fifth floors.

PD Dupuis and Messrs. Biddison and Surnow answered informational questions from the HDC.

Ms. Dukas and Mr. Lemberg said they would prefer the proposed changes be submitted for a historic design review by the HDC before voting on the appropriateness of the changes.

AC Willoughby, Ms. Debbrecht, and Ms. Lang said they were comfortable allowing the proposed changes to be administratively approved.

11-64-22

Motion by Ms. Lang

Seconded by Ms. Debbrecht to allow PD Dupuis to administratively approve the changes presented during the present meeting.

Motion failed, 3-2.

VOICE VOTE

Yeas: Debbrecht, Willoughby, Lang

Nays: Lemberg, Dukas

- B. Draft Agenda
- C. Staff Reports
 - 1. Administrative Sign Approvals
 - 2. Administrative Approvals
 - 3. Demolitions
 - 4. Action List 2022

8) Adjournment

No further business being evident, the HDC motioned to adjourn at 7:57 p.m.

Nicholas Dupuis Planning Director

Laura Eichenhorn City Transcriptionist



MEMORANDUM

Planning Division

DATE: October 19, 2022

TO: Historic District Commission Members

FROM: Nicholas Dupuis, Planning Director

SUBJECT: 555 Stanley – Hood House – Design Review

Zoning: C, (Community), B-4 (Business-Residential) & D-4 (Downtown Overlay)

Existing Use: Two-Story Commercial Building

History

The Birmingham Post Office was erected in 1939 as a part of the federal government's program of public works during the depression. The original reports in local papers stated that the building would be of "English Type" architecture in conformity with the municipal building and the library. Although residents were initially perturbed by the "Neo-Classical" style, the building gained acceptance over the years as a valued part of the Birmingham Civic Center. The Post Office gained its most prominent notoriety because of its interior treatments. The building interior was decorated in an Art Deco style. Interior murals, which were executed by renowned W.P.A. artist Carlos Lopez, were considered controversial because of the depiction of several Birmingham pioneers and contemporary political figures. Local figures accused Lopez of depicting characters of the mural with inappropriate features. Lopez responded with citations of the historical records and photographs he used as backgrounds for his work. Although many lobbied for the immediate destruction of the murals, they ultimately survived and have since undergone preservation treatments by a student of Lopez's.

Introduction

A Revised Historic Design Review application has been submitted for changes to the 5-story addition to the historic Birmingham Post Office in the Shain Park Historic District of Birmingham that was approved by the Historic District Commission on March 16, 2022 (<u>Agenda</u> – <u>Minutes</u>).

The Shain Park Historic District consists of the Birmingham City Hall, Baldwin Public Library, Community House and the subject property.

On November 16, 2022, the applicant came before the Historic District Commission (HDC) at a pre-application discussion level. After some conversation, the HDC moved to permit administrative approval of the proposed changes by a vote of 3-2. The HDC's Rules of Procedure dictates the following:

"Four members of the Historic District Commission shall constitute a quorum for the conduct of its business. The concurring affirmative vote of four members of the Historic District Commission shall be required for approval of plans before the Historic District Commission for review or for the adoption of any resolution, motion or other action by the Historic District Commission."

Based on the Rules of Procedure, the motion failed and the applicant was then required to bring the changes to the HDC for a Design Review.

Proposal

In general, the proposal as approved in March 2022 in terms of materials, use and general design is not changing. After going through the design-development process for the project, the applicant has decided to pursue some changes to accommodate some structural changes, as well as changes to increase the square footage of some of the upper floors, both of which affect the exterior of the building. In summary, the applicant is proposing three main changes to the building that affect the current Historic Design Review approval:

- Floors 3-5 will be expanded to the west, floor 5 is proposed to be expanded slightly to the south in select areas.
- The entrance on Bates will be revised to include new column placement and stair location.
- The glass "hyphen" connecting the historic Birmingham Post Office with the new addition, which was previously approved as a 2-story clear glass open space, is now being partially filled by an expansion of the second floor.

For your reference, the detailed March 16, 2022 Design Review memo is attached to the end of this report. For additional reference, the previously approved plans from March 16, 2022 and the approved plans from the Planning Board Review on July 27, 2022 are attached.

Planning & Zoning

There do not appear to be any planning and zoning issues in terms of bulk, placement, height, etc. that require review at the Historic District Commission. The Planning Division has reviewed the proposal in regards to such and has no issues at this time. In addition, there do not appear to be any variances required for the proposed Revised Design Review application to proceed. It is worth noting that the floor plans, including the lower level parking area, have changed as a

part of design-development, but that the proposed uses and number of parking spaces meet the requirements of the Zoning Ordinance, although it has changed from previous approvals.

Signage

There are no new signs proposed as a part of the Design Review application submitted.

Design Review Standards and Guidelines

Chapter 127, Section 127-11 of the Birmingham Code of Ordinances states that in reviewing plans, the commission shall follow the U.S. secretary of the interior's standards for rehabilitation and guidelines for rehabilitating historic buildings as set forth in 36 C.F.R. part 67. Design review standards and guidelines that address special design characteristics of historic districts administered by the commission may be followed if they are equivalent in guidance to the secretary of interior's standards and guidelines and are established or approved by the state historic preservation office of the Michigan Historical Center. The U.S. Secretary of the Interior Standards for Rehabilitation ("SOI Standards") are provided in full at the end of this report.

In reviewing plans, the commission shall also consider all of the following:

- 1. The historic or architectural value and significance of the resource and its relationship to the historic value of the surrounding area.
- 2. The relationship of any architectural features of the resource to the rest of the resource and to the surrounding area.
- 3. The general compatibility of the design, arrangement, texture, and materials proposed to be used.
- 4. Other factors, such as aesthetic value, that the commission finds relevant.
- 5. Whether the applicant has certified in the application that the property where work will be undertaken has, or will have before the proposed project completion date, a fire alarm system or a smoke alarm complying with the requirements of the Stille-DeRossett-Hale single state construction code act, 1972 PA 230, MCL 125.1501 to 125.1531.

Recommendation

In March 2022, the Historic District Commission reviewed a detailed analysis of the Secretary of the Interior Standards for Rehabilitation and other key information related to the historic preservation of the site and the original proposals effect on such. As a reminder, that report is attached to the end of this report. For this review, the Planning Division did not rehash the entire SOI Standard review. Rather, any new additions to the previous review are denoted in **bold blue text** for clarity.

As a reminder, the HDC moved to approve and issue a Certificate of Appropriateness for the initial project stating that the proposal met the Secretary of the Interior Standards for Rehabilitation numbers 1-5, 9 and 10. The following analysis breaks down the revised proposal through the lens of each standard above:

1. A property shall be used for its historic purpose or be placed in a new use that requires minimal change to the defining characteristics of the building and its site and environment.

Due to the unique circumstance, this standard does not necessarily apply. As stated, and as indicated on the plans, the existing historic building will remain as-is and unchanged in terms of its use as a commercial office space. Of course the historic use as a post office no longer remains, but the flow of employees and visitors of the commercial office, along with the preserved signage of the building retain the character of that historic use. The addition to the rear of the building does not appear to affect that.

2. The historic character of a property shall be retained and preserved. The removal of historic materials or alteration of features and spaces that characterize a property shall be avoided.

The placement of the new addition at the rear of the building, which has received treatments over the years itself, does not propose a removal of many historic materials, if any. Additionally, the character of the rear of the property is not as it was based on the original 1939 building. However, an important scale, massing, density conversation must be had here in relation to the buildings *character*. Based on general guidelines, additions should be subordinate to the historic resource. Understanding the unique conditions of the site, and considering the properties frontage on 3 streets, a strict interpretation of the quidelines in terms of a subordinate addition would appear to mean a small, one or two story addition. However, other guidelines suggest that there are ways to minimize the impact of larger additions onto historic resources by using a small hyphen to connect the two. However, this tact generally only works if the building in only slightly larger, say a 2 or 3 story building in this case. In the case of the Post Office building, a hyphen-like element already exists as a part of the original building, which may be used to soften the impact of the larger addition. In this case, the applicant appears to be taking away the advantage and impact of the natural hyphen by proposing a partial overhang over what would be considered the hyphen. Since the first submittal, the area around the hyphen has been lightened through the removal of building elements, and the use of 2-story clear glass where the new building meets the old.

However, the rear of the property has never been a character-defining area of the building. The prominent façade that is oriented towards Martin and the Shain Park Historic District is where the building makes its mark. This is corroborated by a review of the available historic photographs on file with the City and the Birmingham Museum, which are taken at the front of the building in almost every case. Furthermore, insofar as the interior is considered, the famous Lopez murals are also located at the front of the building. The proposed addition does not appear to jeopardize the Post Office's most prominent and character-defining façade and its position in the Shain Park Historic District.

The proposed revisions to the building at the Bates entrance and the second floor plan affect the connection or "hyphen" point of the building. In the opinion of the Planning Division, the changes to the entrance which include two relocated columns and exterior stairs is a nominal change to the feature, and has a neutral or slightly positive affect on the proposal. The column placement creates a more "monumental" feel, which relates well to the original Post Office structure, and was a common design element on federal buildings of that era.

As far as the second floor expansion into what was formerly a 2-story clear connection/lobby space, the expansion makes the connection not as light or delicate as was previously approved, even though the second floor is set back from the glass by several feet. As was discussed in the original approval process, the 2-story clear space was well received because of how it helped make the new addition feel more like a separate building

3. Each property shall be recognized as a physical record of its time, place, and use. Changes that create a false sense of historical development, such as adding conjectural features or architectural elements from other buildings, shall not be undertaken.

The building does appear to do well to pull some of the historic materials/color palates into the new addition, which is preferred in terms of a compatibility argument. Because this is an addition which does not change the Post Office building, there are no conjectural features to be worried about, nor does the proposed addition present as a false sense of historical development.

4. Most properties change over time; those changes that have acquired historic significance in their own right shall be retained and preserved.

The rear of the building has changed over time with what appears to be the addition of a small lobby and some carports. The new proposal appears to remove this addition, but retain the historic portion to which the older addition is attached. The Planning Division does not feel as though the small lobby addition has retained any historic character.

5. Distinctive features, finishes, and construction techniques or examples of craftsmanship that characterize a property shall be preserved.

More of the same comments as above regarding the nature of the addition and its minimal *physical* impact on the historic building can be restated. If there were any significant features on the rear (which it does not appear to have been so), they had been removed by a previous alteration.

9. New additions, exterior alterations, or related new construction shall not destroy historic materials that characterize the property. The new work shall be differentiated from the

old and shall be compatible with the massing, size, scale, and architectural features to protect the historic integrity of the property and its environment.

Similar to Standard #2, there appear to be minimal to no loss of historic materials on the rear of the Post Office. The new addition is certainly differentiated from the old, but may not be compatible with the historic environment.

Diving deeper, research suggests that compatibility can be broken down into the following general elements:

- Setbacks
- Scale
- Orientation
- Proportion
- Rhythm
- Massing

- Height
- Materials
- Colors
- Details and Ornamentation
- Reversibility

Reviewing this list, the Planning Division can agree that the design-based elements of scale, orientation, rhythm, massing, materials, colors details and reversibility appear to all be appropriate and mesh well with the historic building. The dimensional aspects, however, raise some questions in relation to compatibility. The importance of setback and height are based on the overarching theme that additions to historic structures should be subordinate to the original building, and should not overwhelm or detract from the historic experience. The uniqueness of the site, as mentioned above, does lend itself better to a larger addition based on the length of the parcel (~160 ft.), but its visibility from 3 streets offers a challenge to the developers that would not be present if the building were settled in between other buildings in a strip. As far as actual height, the historic building is roughly 29 ft. tall, and the new building will measure 80 ft. tall. This actual dimension has an overall nominal effect in terms of comparing stories versus height, but it is important to note that 29 ft. would be considered more of a 2-story building in terms of height than the 1-story that the Post Office would appear to be. It is worth noting that the site is currently split-zoned with the historic building existing in the C zoning district, and the back half in the D4 overlay district, which permits 5-story buildings.

The proposed expansions to the west on floors 3-5 and the slight expansion to the south at the 5th floor raise the same questions as discussed previously in Standard's 2 and 9 in regards to compatibility and the overall goal of subordinate additions. Although the dimensions of the expansion appear minor in the grand scheme of things (roughly 5 ft. in most cases, more on the western portion of the 5th floor), the difference is noticeable and will affect the massing when viewed from the front of the building. However, it could be considered a small enough change that the overall effect is nominal.

10. New additions and adjacent or related new construction shall be undertaken in such a manner that if removed in the future, the essential form and integrity of the historic property and its environment would be unimpaired.

This standard appears to be met. However, it is worth noting that the proximity of the addition could pose a threat to the historic structure if there are any issues during a hypothetical future removal. In addition, the proposed underground parking must be handled with extreme care as to not disturb the historic structure and the ground beneath it.

Based on the review above, the Planning Division recommends that the Historic District Commission consider **APPROVAL** of the Revised Historic Design Review application for 320 Martin St. – Birmingham Post Office. The Planning Division feels as though the proposed addition still meets the Secretary of the Interior Standards for Rehabilitation numbers 1-5 and 10.

Wording for Motions	Wo	rdin	a for	Motio	ns
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wording for Motions
I move that the Commission APPROVE the Revised Historic Design Review application and issued a Certificate of Appropriateness for 320 Martin St. – Birmingham Post Office. The proposed addition meets the Secretary of the Interior's Standards for Rehabilitation standard numbers (list conditions).
(list conditions).
OR
I move that the Commission POSTPONE the Revised Historic Design Review application and the issuance of a Certificate of Appropriateness for 320 Martin St. – Birmingham Post Office – for the following reason(s):
1.
2
3
OR

Notice to Proceed

I move the Commission issue a Notice to Proceed for number _____. The work is not appropriate, however the following condition prevails: _____and the proposed application will materially correct the condition.

I move that the Commission **DENY** the Revised Historic Design Review application for 320 Martin St. – Birmingham Post Office. Because of the work does not meet The Secretary of the

Interior's Standards for Rehabilitation standard number(s) .

Choose from one of these conditions:

a) The resource constitutes hazard to the safety of the public or the structure's occupants.

- b) The resource is a deterrent to a major improvement program that will be of substantial benefit to the community and the applicant proposing the work has obtained all necessary planning and zoning approvals, financing, and environmental clearances.
- c) Retaining the resource will cause undue financial hardship to the owner when a governmental action, an act of God, or other events beyond the owner's control created the hardship, and all feasible alternatives to eliminate the financial hardship, which may include offering the resource for sale at its fair market value or moving the resource to a vacant site within the historic district. have been attempted and exhausted by the owner.
- d) Retaining the resource is not in the best of the majority of the community.

THE SECRETARY OF THE INTERIOR'S STANDARDS FOR REHABILITATION AND GUIDELINES FOR REHABILITATING HISTORIC BUILDINGS

- A property shall be used for its historic purpose or be placed in a new use that requires minimal change to the defining characteristics of the building and its site and environment.
- 2. The historic character of a property shall be retained and preserved. The removal of historic materials or alteration of features and spaces that characterize a property shall be avoided.
- 3. Each property shall be recognized as a physical record of its time, place, and use. Changes that create a false sense of historical development, such as adding conjectural features or architectural elements from other buildings, shall not be undertaken.
- 4. Most properties change over time; those changes that have acquired historic significance in their own right shall be retained and preserved.
- 5. Distinctive features, finishes, and construction techniques or examples of craftsmanship that characterize a property shall be preserved.
- 6. Deteriorated historic features shall be repaired rather than replaced. Where the severity of deterioration requires replacement of a distinctive feature, the new feature shall match the old in design, color, texture, and other visual qualities and, where possible, materials. Replacement of missing features shall be substantiated by documentary, physical, or pictorial evidence.
- 7. Chemical or physical treatments, such as sandblasting, that cause damage to historic materials shall not be used. The surface cleaning of structures, if appropriate, shall be undertaken using the gentlest means possible.
- 8. Significant archaeological resources affected by a project shall be protected and preserved. If such resources must be disturbed, mitigation measures shall be undertaken.
- 9. New additions, exterior alterations, or related new construction shall not destroy historic materials that characterize the property. The new work shall be differentiated from the old and shall be compatible with the massing, size, scale, and architectural features to protect the historic integrity of the property and its environment.
- 10. New additions and adjacent or related new construction shall be undertaken in such a manner that if removed in the future, the essential form and integrity of the historic property and its environment would be unimpaired.



MEMORANDUM

Planning Division

DATE: March 16, 2022

TO: Historic District Commission

FROM: Nicholas Dupuis, City Planner

SUBJECT: 320 Martin St. – Birmingham Post Office – Historic Design Review

Zoning: C, (Community), B-4 (Business-Residential) & D-4 (Downtown Overlay)

Existing Use: Two-Story Commercial Building

History

The Birmingham Post Office was erected in 1939 as a part of the federal government's program of public works during the depression. The original reports in local papers stated that the building would be of "English Type" architecture in conformity with the municipal building and the library. Although residents were initially perturbed by the "Neo-Classical" style, the building gained acceptance over the years as a valued part of the Birmingham Civic Center. The Post Office gained its most prominent notoriety because of its interior treatments. The building interior was decorated in an Art Deco style. Interior murals, which were executed by renowned W.P.A. artist Carlos Lopez, were considered controversial because of the depiction of several Birmingham pioneers and contemporary political figures. Local figures accused Lopez of depicting characters of the mural with inappropriate features. Lopez responded with citations of the historical records and photographs he used as backgrounds for his work. Although many lobbied for the immediate destruction of the murals, they ultimately survived and have since undergone preservation treatments by a student of Lopez's.

Introduction

A Historic Design Review application has been submitted for a new 5-story addition to the historic Birmingham Post Office in the Shain Park Historic District of Birmingham. The Shain Park Historic District consists of the Birmingham City Hall, Baldwin Public Library, Community House and the subject property.

The applicant came before the Historic District Commission on December 15, 2021 requesting postponement to further work with City Staff on the proposed addition and its relationship to the historic resource and the Secretary of the Interior Standards for Rehabilitation. The Historic District Commission granted the postponement request and postponed the matter to February 2, 2022.

On February 2, 2022, the Historic District Commission moved to postpone consideration of the Design Review application and requested that the applicant consider their comments and work them into the design if possible. The applicant has not made any substantive changes to the design of the addition at this point, but has provided new perspective views that include the surrounding properties to demonstrate the new additions effect on the Shain Park Historic District as requested by the Historic District Commission.

Proposal

The applicant has submitted new plans proposing a 5-story addition to the rear of the property that currently houses a modern lobby, some carports, a parking facility, and a dumpster enclosure. The new building draws some design elements from the historic building, but also includes an array of modern materials. A full review of the historic preservation aspects of the design is provided in the relevant section below. The proposed materials for the new addition are as follows (a material board has been submitted as well):

Material	Location	Color
Brick	Horizontal sections at floor lines, all facades	Executive Ironspot
Brick	Horizontal and vertical massing all facades	Manganese Ironspot
Insulated Glass	Storefront and upper floor glazing	-
Flamed Granite	Architectural elements	Black
Smooth Limestone	Vertical Piers, 5 th floor, architectural elements	Natural
Metal Wrap	First floor canopy	Black
Metal Paneling	Rooftop screening	Quartz Zinc
Aluminum	Window frames/mullions	Natural

Planning & Zoning

The proposed project will be required to go before the Planning Board for a full Preliminary and Final Site Plan Review in which the planning and zoning issues will be discussed in detail. For this reason, the Planning Division will not be including a review of planning and zoning issues in this report, and will instead focus on a review of the Secretary of the Interior Standards for Rehabilitation and Chapter 10 of the Birmingham Code of Ordinances.

Signage

There are no new signs proposed as a part of the Design Review application submitted.

Design Review Standards and Guidelines

Chapter 127, Section 127-11 of the Birmingham Code of Ordinances states that in reviewing plans, the commission shall follow the U.S. secretary of the interior's standards for rehabilitation and guidelines for rehabilitating historic buildings as set forth in 36 C.F.R. part 67. Design review standards and guidelines that address special design characteristics of historic districts administered by the commission may be followed if they are equivalent in guidance to the secretary of interior's standards and guidelines and are established or approved by the state

historic preservation office of the Michigan Historical Center. The U.S. Secretary of the Interior Standards for *Rehabilitation* ("SOI Standards") are provided in full at the end of this report.

In reviewing plans, the commission shall also consider all of the following:

- 1. The historic or architectural value and significance of the resource and its relationship to the historic value of the surrounding area.
- 2. The relationship of any architectural features of the resource to the rest of the resource and to the surrounding area.
- 3. The general compatibility of the design, arrangement, texture, and materials proposed to be used.
- 4. Other factors, such as aesthetic value, that the commission finds relevant.
- 5. Whether the applicant has certified in the application that the property where work will be undertaken has, or will have before the proposed project completion date, a fire alarm system or a smoke alarm complying with the requirements of the Stille-DeRossett-Hale single state construction code act, 1972 PA 230, MCL 125.1501 to 125.1531.

Recommendation

The Michigan State Historic Preservation Office defines *rehabilitation* as the act or process of making possible a compatible use for a property through repair, alterations, and additions while preserving those portions or features which convey its historical, cultural, or architectural values.

Rehabilitation is the only treatment that allows expanding a historic building by enlarging it with an addition. However, the Rehabilitation guidelines emphasize that new additions should be considered only after it is determined that meeting specific new needs cannot be achieved by altering non-character-defining interior spaces. If the use cannot be accommodated in this way, then an attached exterior addition may be considered. New additions should be designed and constructed so that the character-defining features of the historic building, its site, and setting are not negatively impacted. Generally, a new addition should be subordinate to the historic building. A new addition should be compatible, but differentiated enough so that it is not confused as historic or original to the building. The same guidance applies to new construction so that it does not negatively impact the historic character of the building or its site.

In general, this is a unique circumstance in the City of Birmingham. Most of the commercial designated historic resources in the City do not have a large portion of their site undeveloped (the absence of a building, that is). Important to note, though, historic preservation does not only exist to protect a building, but also the site, general characteristics, context, density, and other important factors.

Considering the above, the proposed exterior restoration of the historic Birmingham Post Office building, as proposed by the applicant, generally meets the Secretary of the Interior Standards for *Rehabilitation* numbers 1, 3, 4, 5, and 10. However, Standard numbers 2 and 9 require further

discussion, and may not be so easily satisfied by the proposal. The following analysis breaks down the proposal through the lens of each standard above:

1. A property shall be used for its historic purpose or be placed in a new use that requires minimal change to the defining characteristics of the building and its site and environment.

Due to the unique circumstance, this standard does not necessarily apply. As stated, and as indicated on the plans, the existing historic building will remain as-is and unchanged in terms of its use as a commercial office space. Of course the historic use as a post office no longer remains, but the flow of employees and visitors of the commercial office, along with the preserved signage of the building retain the character of that historic use. The addition to the rear of the building does not appear to affect that.

 The historic character of a property shall be retained and preserved. The removal of historic materials or alteration of features and spaces that characterize a property shall be avoided.

The placement of the new addition at the rear of the building, which has received treatments over the years itself, does not propose a removal of many historic materials, if any. Additionally, the character of the rear of the property is not as it was based on the original 1939 building. However, an important scale, massing, density conversation must be had here in relation to the buildings *character*. Based on general guidelines, additions should be subordinate to the historic resource. Understanding the unique conditions of the site, and considering the properties frontage on 3 streets, a strict interpretation of the quidelines in terms of a subordinate addition would appear to mean a small, one or two story addition. However, other guidelines suggest that there are ways to minimize the impact of larger additions onto historic resources by using a small hyphen to connect the two. However, this tact generally only works if the building in only slightly larger, say a 2 or 3 story building in this case. In the case of the Post Office building, a hyphen-like element already exists as a part of the original building, which may be used to soften the impact of the larger addition. In this case, the applicant appears to be taking away the advantage and impact of the natural hyphen by proposing a partial overhang over what would be considered the hyphen. Since the first submittal, the area around the hyphen has been lightened through the removal of building elements, and the use of 2-story clear glass where the new building meets the old.

However, the rear of the property has never been a character-defining area of the building. The prominent façade that is oriented towards Martin and the Shain Park Historic District is where the building makes its mark. This is corroborated by a review of the available historic photographs on file with the City and the Birmingham Museum, which are taken at the front of the building in almost every case. Furthermore, insofar as the interior is considered, the famous Lopez murals are also located at the front of the building. The proposed addition does not appear to jeopardize the Post Office's most prominent and character-defining façade and its position in the Shain Park Historic District.

 Each property shall be recognized as a physical record of its time, place, and use. Changes that create a false sense of historical development, such as adding conjectural features or architectural elements from other buildings, shall not be undertaken.

The building does appear to do well to pull some of the historic materials/color palates into the new addition, which is preferred in terms of a compatibility argument. Because this is an addition which does not change the Post Office building, there are no conjectural features to be worried about, nor does the proposed addition present as a false sense of historical development.

4. Most properties change over time; those changes that have acquired historic significance in their own right shall be retained and preserved.

The rear of the building has changed over time with what appears to be the addition of a small lobby and some carports. The new proposal appears to remove this addition, but retain the historic portion to which the older addition is attached. The Planning Division does not feel as though the small lobby addition has retained any historic character.

5. Distinctive features, finishes, and construction techniques or examples of craftsmanship that characterize a property shall be preserved.

More of the same comments as above regarding the nature of the addition and its minimal *physical* impact on the historic building can be restated. If there were any significant features on the rear (which it does not appear to have been so), they had been removed by a previous alteration.

9. New additions, exterior alterations, or related new construction shall not destroy historic materials that characterize the property. The new work shall be differentiated from the old and shall be compatible with the massing, size, scale, and architectural features to protect the historic integrity of the property and its environment.

Similar to Standard #2, there appear to be minimal to no loss of historic materials on the rear of the Post Office. The new addition is certainly differentiated from the old, but may not be compatible with the historic environment.

Diving deeper, research suggests that compatibility can be broken down into the following general elements:

- Setbacks
- Scale
- Orientation
- Proportion
- Rhythm
- Massing

- Height
- Materials
- Colors
- Details and Ornamentation
- Reversibility

Reviewing this list, the Planning Division can agree that the design-based elements of scale, orientation, rhythm, massing, materials, colors details and reversibility appear to all be appropriate and mesh well with the historic building. The dimensional aspects, however, raise some questions in relation to compatibility. The importance of setback and height are based on the overarching theme that additions to historic structures should be subordinate to the original building, and should not overwhelm or detract from the historic experience. The uniqueness of the site, as mentioned above, does lend itself better to a larger addition based on the length of the parcel (~160 ft.), but its visibility from 3 streets offers a challenge to the developers that would not be present if the building were settled in between other buildings in a strip. As far as actual height, the historic building is roughly 29 ft. tall, and the new building will measure 80 ft. tall. This actual dimension has an overall nominal effect in terms of comparing stories versus height, but it is important to note that 29 ft. would be considered more of a 2-story building in terms of height than the 1-story that the Post Office would appear to be. It is worth noting that the site is currently split-zoned with the historic building existing in the C zoning district, and the back half in the D4 overlay district, which permits 5-story buildings.

10. New additions and adjacent or related new construction shall be undertaken in such a manner that if removed in the future, the essential form and integrity of the historic property and its environment would be unimpaired.

This standard appears to be met. However, it is worth noting that the proximity of the addition could pose a threat to the historic structure if there are any issues during a hypothetical future removal. In addition, the proposed underground parking must be handled with extreme care as to not disturb the historic structure and the ground beneath it.

Based on the review above, the Planning Division recommends that the Historic District Commission consider **APPROVAL** of the Design Review application for 320 Martin St. – Birmingham Post Office. The Planning Division feels as though the proposed addition meets the Secretary of the Interior Standards for Rehabilitation numbers 1-5 and 10.

Wording for Motions

I move that the Commission **APPROVE** the Historic Design Review application and issue a Certificate of Appropriateness for 320 Martin St. – Birmingham Post Office. The proposed addition meets the Secretary of the Interior's Standards for Rehabilitation standard numbers ______ (*list conditions*).

OR

I move that the Commission **POSTPONE** the Historic Design Review application and the issuance of a Certificate of Appropriateness for 320 Martin St. – Birmingham Post Office – for the following reason(s):


1
2.
3
OR
I move that the Commission DENY the Historic Design Review application for 320 Martin St. – Birmingham Post Office. Because of the work does not meet The Secretary of the Interior's Standards for Rehabilitation standard number(s)
Notice to Proceed
I move the Commission issue a Notice to Proceed for number The work is not appropriate, however the following condition prevails: and the proposed application will materially correct the condition.
Choose from one of these conditions: a) The resource constitutes hazard to the safety of the public or the structure's occupants.


- b) The resource is a deterrent to a major improvement program that will be of substantial benefit to the community and the applicant proposing the work has obtained all necessary planning and zoning approvals, financing, and environmental clearances.
- c) Retaining the resource will cause undue financial hardship to the owner when a governmental action, an act of God, or other events beyond the owner's control created the hardship, and all feasible alternatives to eliminate the financial hardship, which may include offering the resource for sale at its fair market value or moving the resource to a vacant site within the historic district. have been attempted and exhausted by the owner.
- d) Retaining the resource is not in the best of the majority of the community.

THE SECRETARY OF THE INTERIOR'S STANDARDS FOR REHABILITATION AND GUIDELINES FOR REHABILITATING HISTORIC BUILDINGS

- A property shall be used for its historic purpose or be placed in a new use that requires minimal change to the defining characteristics of the building and its site and environment.
- 2. The historic character of a property shall be retained and preserved. The removal of historic materials or alteration of features and spaces that characterize a property shall be avoided.
- 3. Each property shall be recognized as a physical record of its time, place, and use. Changes that create a false sense of historical development, such as adding conjectural features or architectural elements from other buildings, shall not be undertaken.
- 4. Most properties change over time; those changes that have acquired historic significance in their own right shall be retained and preserved.
- 5. Distinctive features, finishes, and construction techniques or examples of craftsmanship that characterize a property shall be preserved.
- 6. Deteriorated historic features shall be repaired rather than replaced. Where the severity of deterioration requires replacement of a distinctive feature, the new feature shall match the old in design, color, texture, and other visual qualities and, where possible, materials. Replacement of missing features shall be substantiated by documentary, physical, or pictorial evidence.
- 7. Chemical or physical treatments, such as sandblasting, that cause damage to historic materials shall not be used. The surface cleaning of structures, if appropriate, shall be undertaken using the gentlest means possible.
- 8. Significant archaeological resources affected by a project shall be protected and preserved. If such resources must be disturbed, mitigation measures shall be undertaken.
- 9. New additions, exterior alterations, or related new construction shall not destroy historic materials that characterize the property. The new work shall be differentiated from the old and shall be compatible with the massing, size, scale, and architectural features to protect the historic integrity of the property and its environment.
- 10. New additions and adjacent or related new construction shall be undertaken in such a manner that if removed in the future, the essential form and integrity of the historic property and its environment would be unimpaired.

REVISED DESIGN REVIEW PLANS (CURRENT REVIEW)

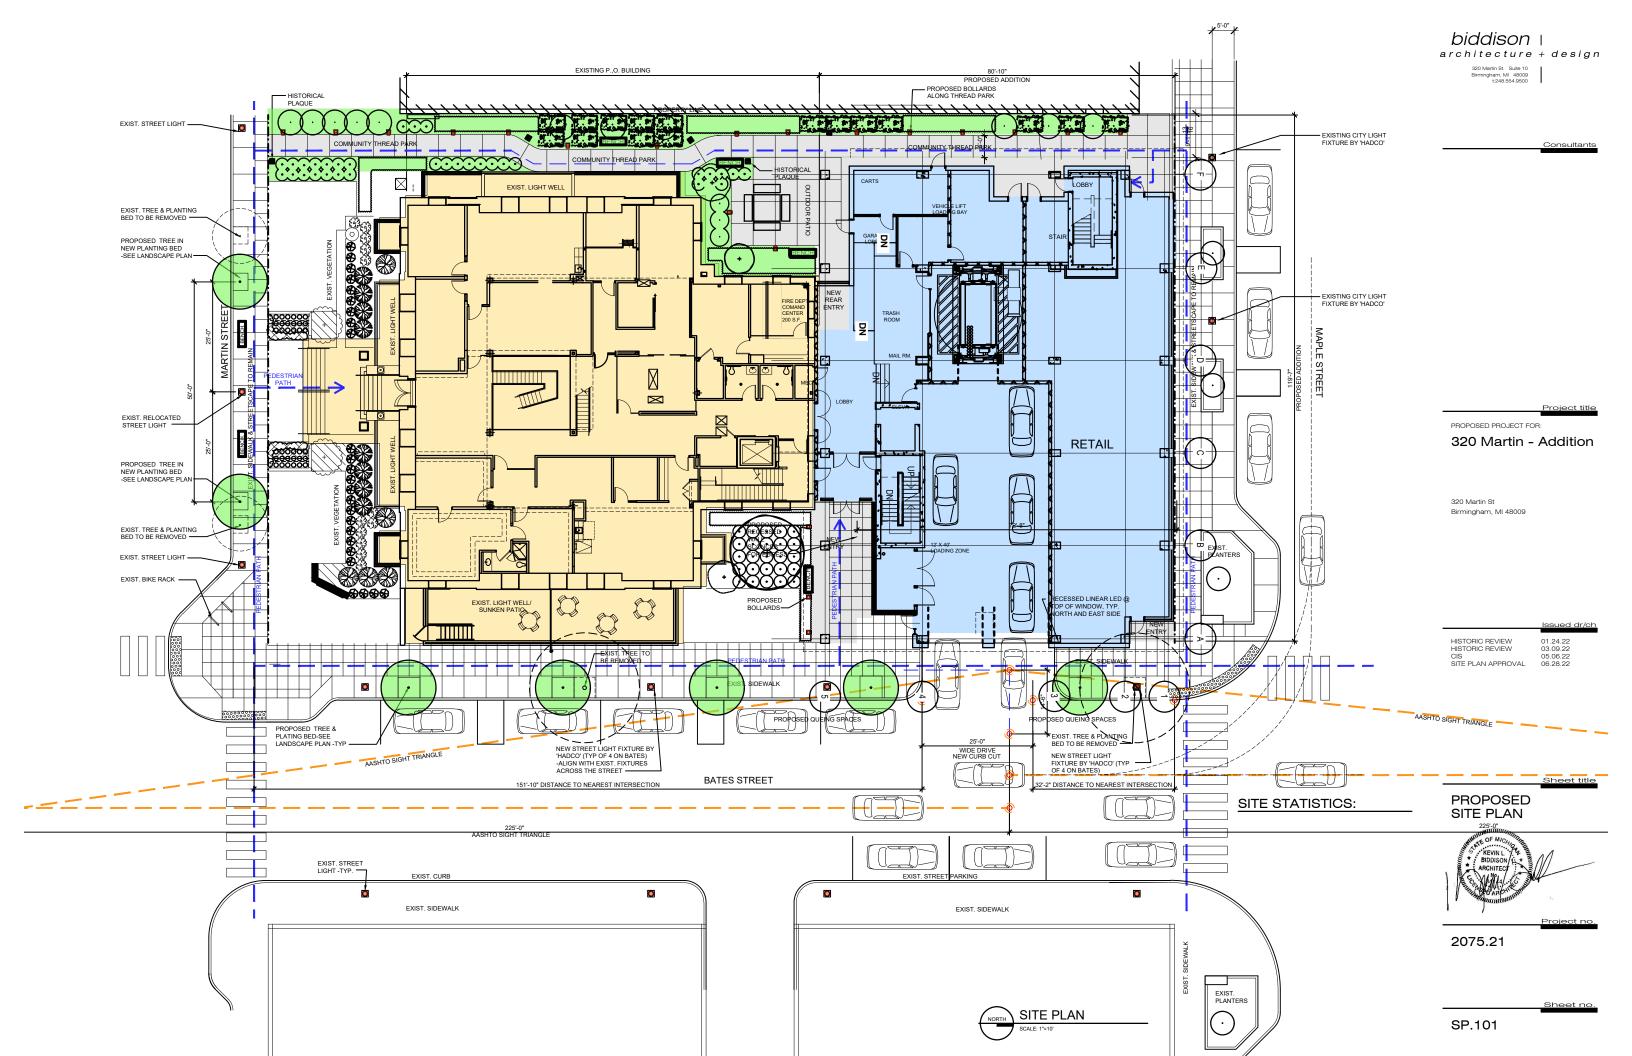

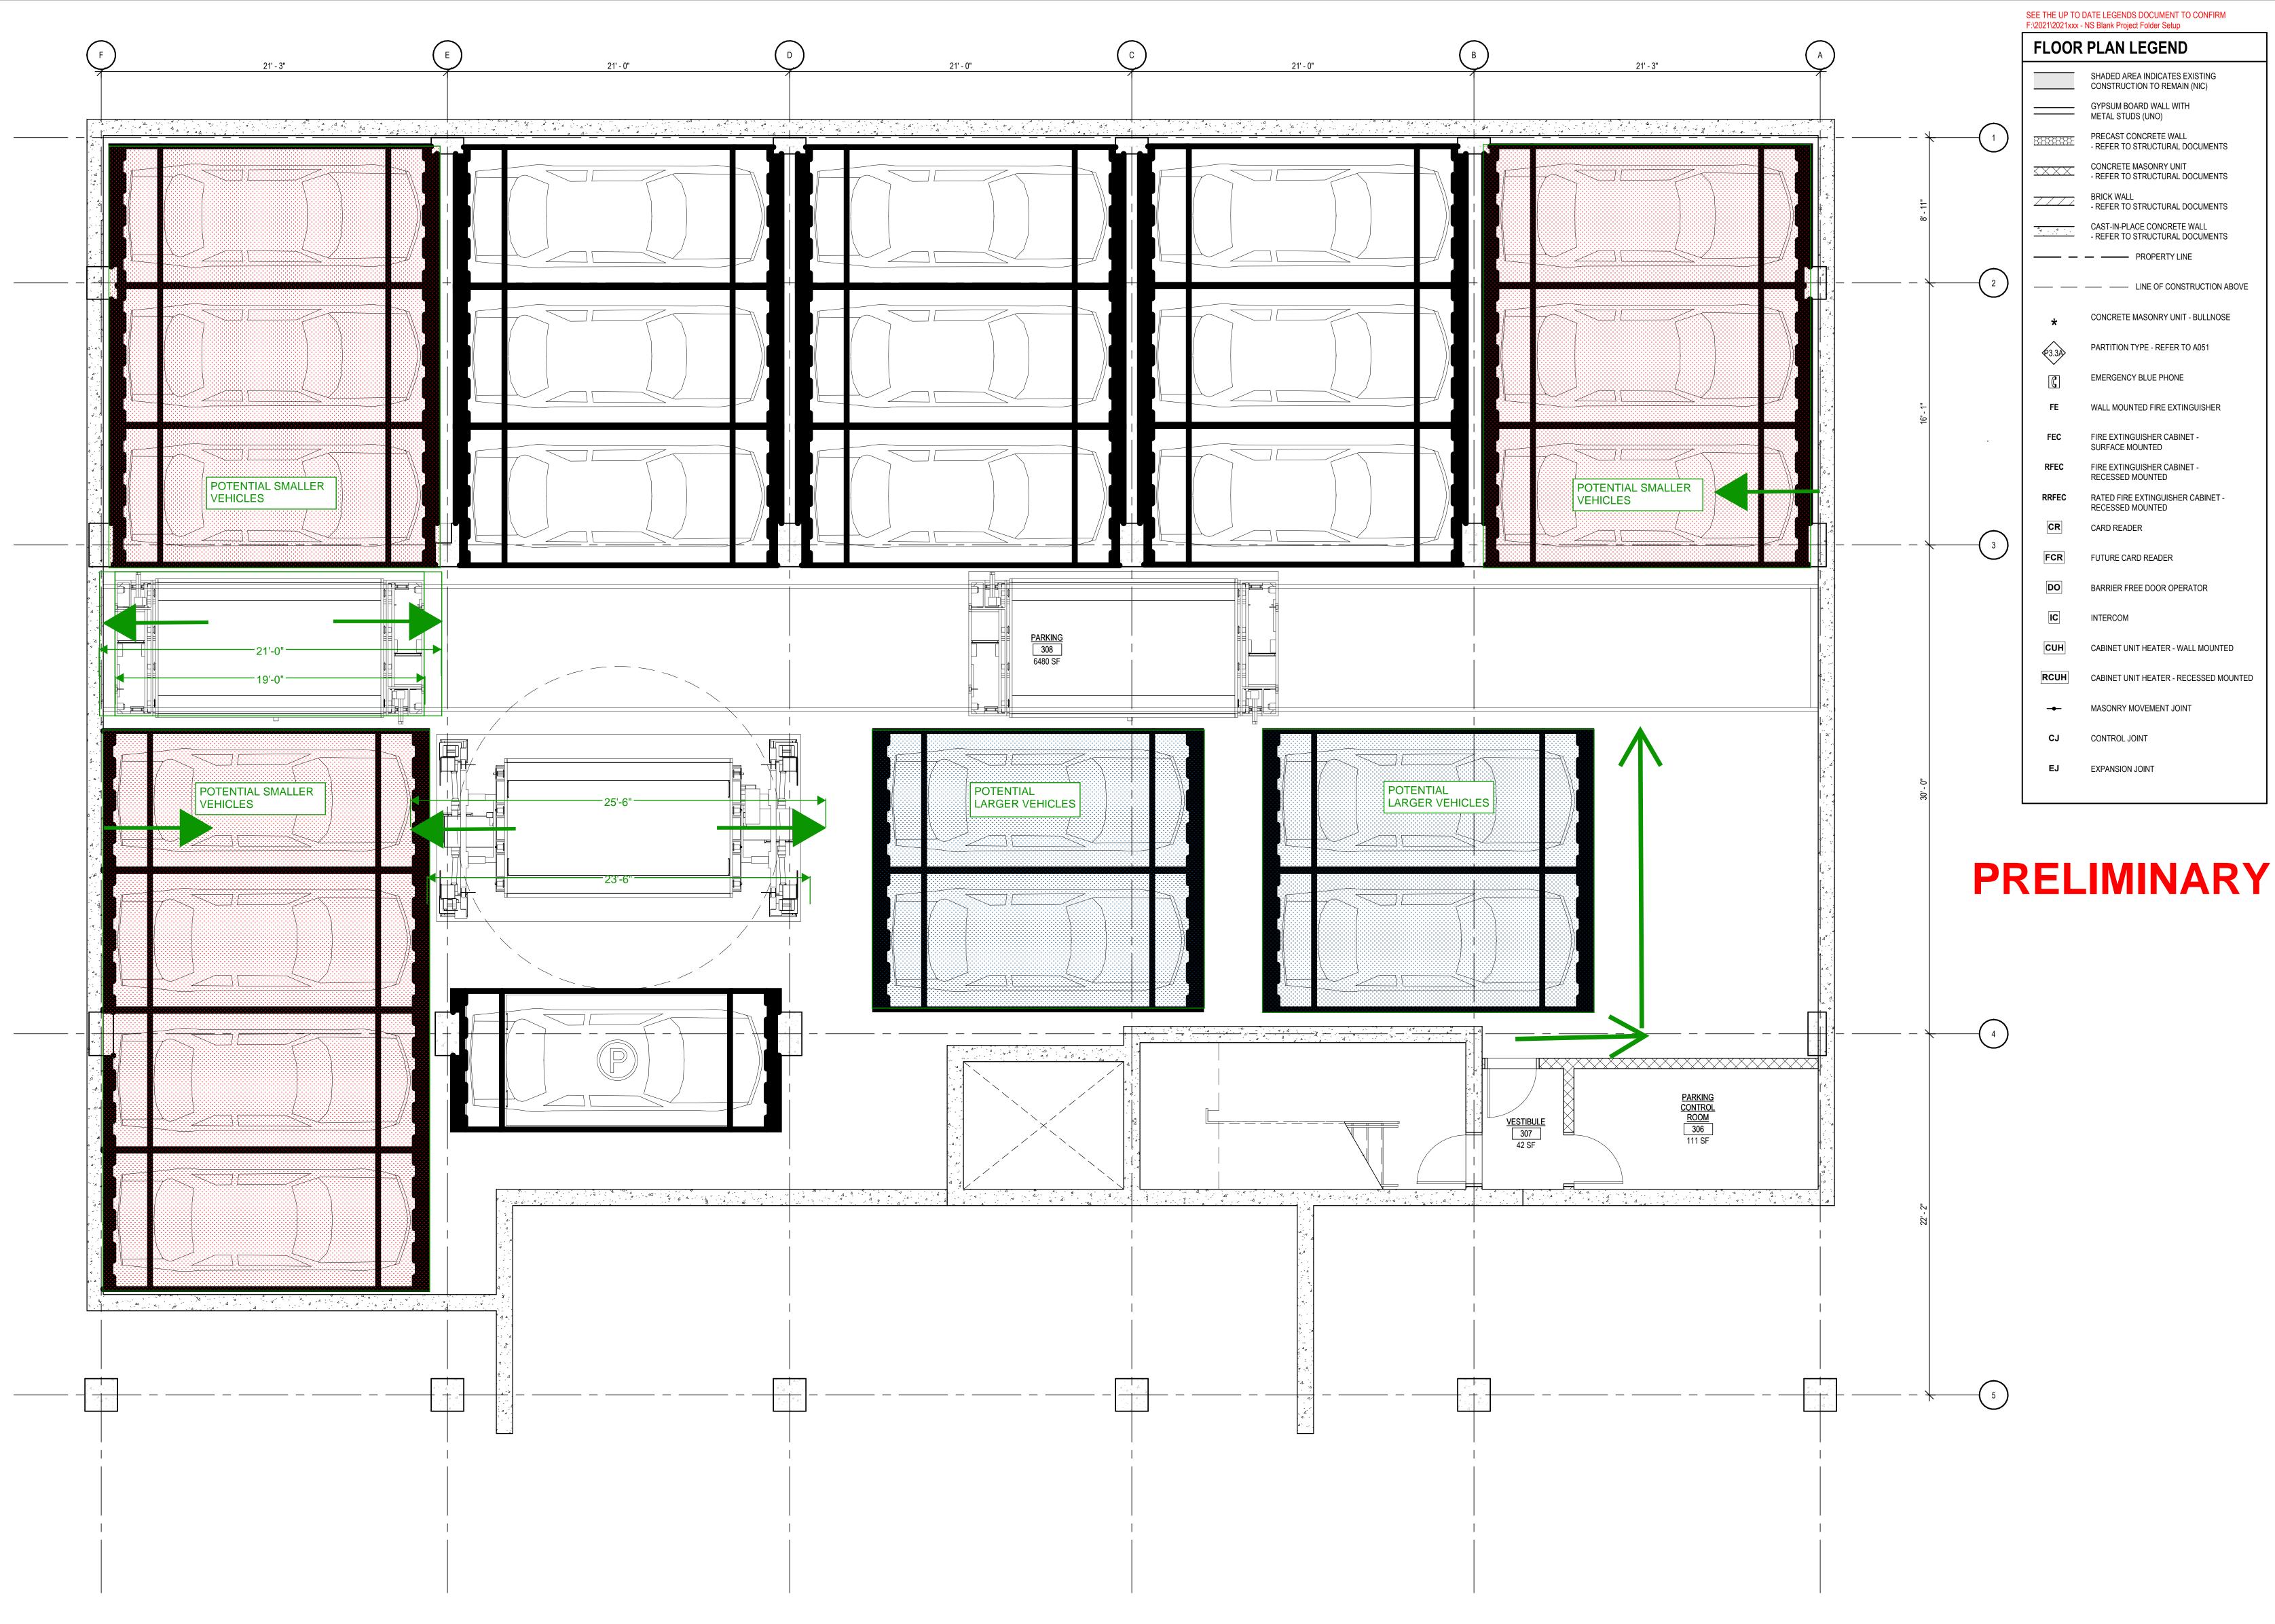

NOR	RTH	
		PARKING LEVEL COMPOSITE PLAN
		A100A SCALE: 1/4" = 1'-0"



SOUTHFIELD • DETROIT

400 Galleria Officentre Suite 555 Southfield, Michigan 48034 phone 248.352.8310 fax 248.352.1821 www.neumannsmith.com



320 Martin Development

320 Martin Birmingham, Michigan

A B C
D E F

Revisions

Drawn	Preliminary
SSB	Construction
Checked	
SSB	Record
Approved	Do not scale
SEC	Use figured dimensions only
Bidpak Number	<u> </u>

Job Number **2022041**

PARKING LEVEL COMPOSITE PLAN

Sheet A100A








320 Martin Development

320 Martin Birmingham, Michigan

SSB Checked SSB	Preliminary Construction Record
Approved JS Belpuk Number	Do net scale Use figured dimensions only
Job Number	
2022041	
Title	LOOP PECICAL
Title	LOOR DESIGN
FIRST F	LOOR DESIGN

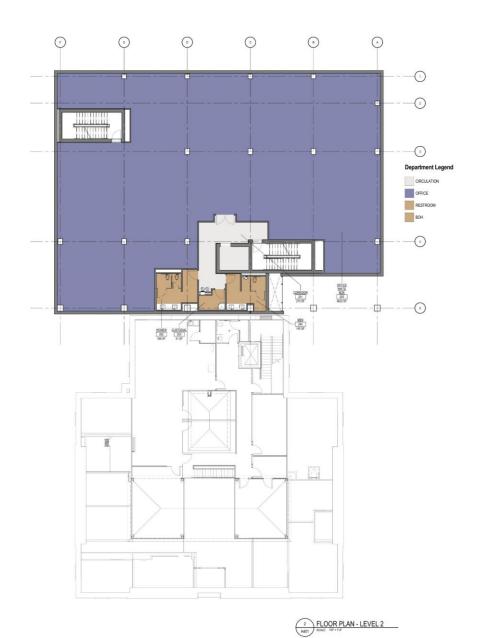






320 Martin Development

320 Martin Birmingham, Michigan

DMIT	Preliminary
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ecked	Record
SB	T second
proved	Do not scale
S	Use figured dimensions only
Ipiak Number	uninterest unit
5 Number	

5 2022041 SECOND FLOOR BESIGN PLANS

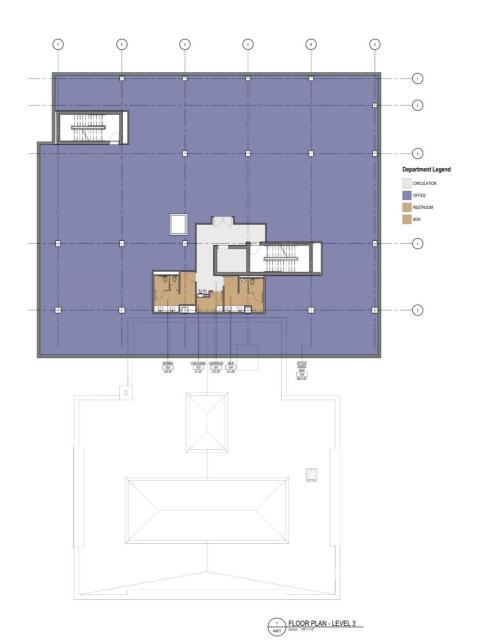





320 Martin Development

320 Martin Birmingham, Michigan

FÜMFI	Preliminary
SSB	Construction
hecked	
SSB	Record
pproved	Do not scale
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kfpsk Number	


So Number 2022041 THIRD FLOOR DESIGN PLAN





320 Martin Development

320 Martin Birmingham, Michigan

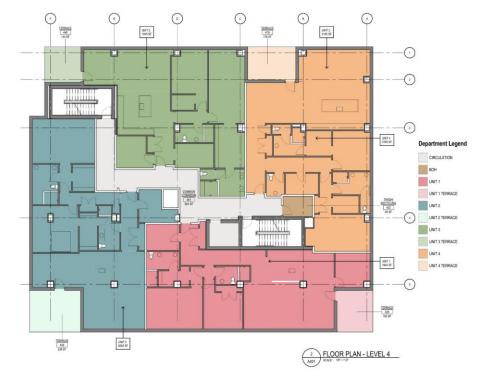

Drawn	Preliminary
SSB	Construction
Checked	
SSB	Record
Approved	Do not scale
JS	Use figured
Richnel Number	

No Number
2022041
Title
FOURTH FLOOR
DESIGN PLAN

Sheet




SOUTHFIELD - DETROIT

400 Galleria Officentre Suite 555 Southfield, Michigan 48034 phone 248.352,8310 fax 248.352,1821 www.neumannsmith.com



320 Martin Development

320 Martin Birmingham, Michigan

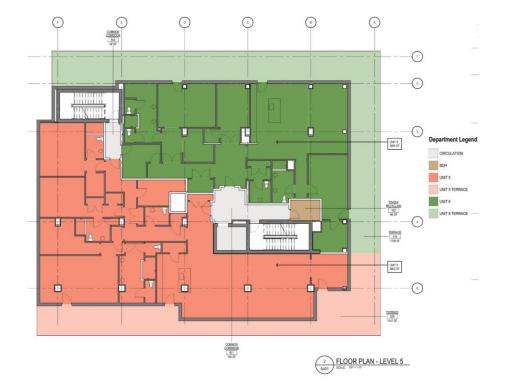

Drawn	Preliminary
SSB	Construction
SSB	Record
JS	Do not scale Use figured dimensions only
Sidpuk Mumber	
202204	1
FIFTH F	LOOR DESIGN
PI AN	LOUIS DEGIGIA

Sheet D.5



	MATERIAL A	REA (SQ. FT.)
ELEVATION	SOLID	GLASS
WEST (2ND FLOOR TO ROOF)	3,566	1,190
% OF TOTAL	65.2%	34.8%
REQUIRED %	65% MIN	35% MAX

	MATERIAL AREA (SQ. FT.)	
ELEVATION	SOLID	GLASS
WEST (1'-0" TO 8'-0")	324 S.F.	341 S.F.
% OF TOTAL	47.7%	52.3%
REQUIRED %	30% MAX	70% MIN





LIMESTONE PIERS, TYP

	MATERIAL AREA (SQ. FT.)	
ELEVATION	SOLID	GLASS
EAST (2ND FLOOR TO ROOF)	3,600	1,920
% OF TOTAL	65.2%	34.8%
REQUIRED %	65% MIN	35% MAX

	MATERIAL AREA (SQ. FT.)	
ELEVATION	SOLID	GLASS
EAST (1'-0" TO 8'-0")	128	440
% OF TOTAL	22.5%	77.5%
REQUIRED %	30% MAX	70% MIN



biddison _I

architecture + design

320 Martin St. Suite 10 Birmingham, MI 48009 t:248.554.9500

Consultant

Project title

PROPOSED BUILDING ADDITION FOR:

320 Martin -Addition

320 Martin St Birmingham, MI 48009

HISTORIC REVIEW 01 24 22
HISTORIC REVIEW 03 09 22
CIS 05 06 22
DIM. REVISIONS 05 25 22
SITE PLAN APPROVAL 06 28 22
GLAZING CORRECTIONS 07 25 22
HISTORIC REVIEW 12 02 22

Sheet t

PROPOSED ELEVATIONS



2075.21

Sheet no

A.202

Consultants

T.O. ELEVATOR/S	
T.O. ELEVATOR/S: @ 79'-9"	
T.O. ROOF/PATIO @ 65'-3"	
F.F. 5TH LEVEL @ 53'-3"	
F.F. 4TH LEVEL @ 41'-3"	
F.F. 3RD LEVEL @ 28'-11"	
F.F. 2ND LEVEL @ 16'-7"	
@ 16'-7"	4-0. As a second of the second
FINISH FLOOR @ 0'-7"	

201.02 NORTH ELEVATION A.202 SCALE: 3/32"=1'-0"

Project title


PROPOSED BUILDING ADDITION FOR:

320 Martin - Addition

320 Martin St Birmingham, MI 48009

	Issued dr/
HISTORIC REVIEW HISTORIC REVIEW CIS DIM. REVISIONS SITE PLAN APPROVAL GLAZING CORRECTIONS HISTORIC REVIEW	01.24.22 03.09.22 05.06.22 05.25.22 06.28.22 07.25.22

Sheet title PROPOSED ELEVATIONS

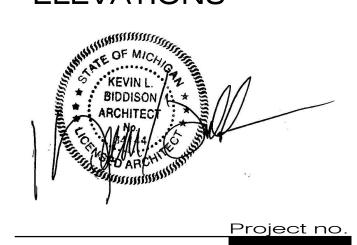

Sheet no.

2075.21

	MATERIAL AREA (SQ. FT.)	
ELEVATION	SOLID	GLASS
SOUTH (2ND FLOOR TO ROOF)	4,852	1,938
% OF TOTAL	71.5%	28.5%
REQUIRED %	65% MIN	35% MAX

MATERIAL AREA (SQ. FT.)

65% MIN 35% MAX

4,372

65.3%

MATERIAL AREA (SQ. FT.)

GLASS

GLASS

70% MIN

2,323

34.7%

SOLID

SOLID

À 220

39%

30% MAX

ELEVATION

% OF TOTAL

REQUIRED %

ELEVATION


NORTH (1'-0" TO 8'-0")

% OF TOTAL

REQUIRED %

NORTH (2ND FLOOR TO ROOF)

	MATERIAL AREA (SQ. FT.)	
ELEVATION	SOLID	GLASS
SOUTH (1'-0" TO 8'-0")	656	25
% OF TOTAL	72.5%	27.5
REQUIRED %	30% MAX	70% MI

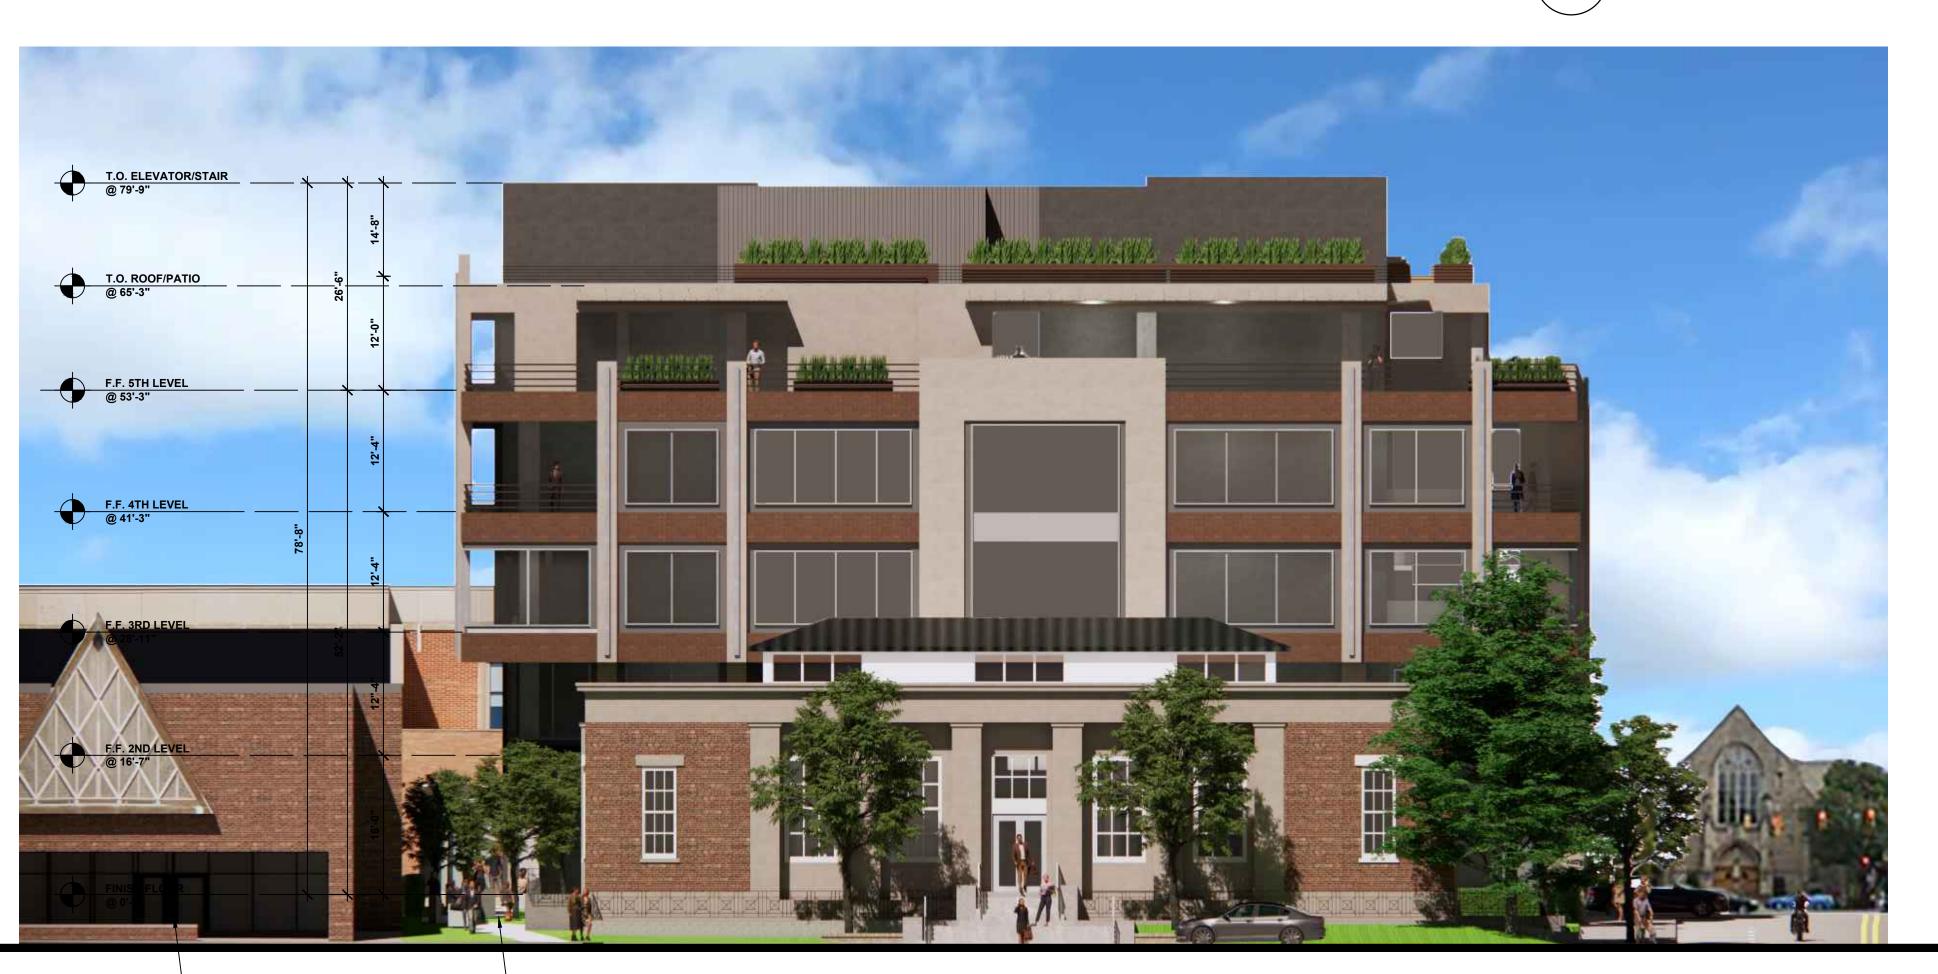

— EXIST. ST. JAMES EPISCOPAL CHURCH -BEYOND

COMMUNITY
THREAD PARK

























APPROVED FINAL SITE PLAN & DESIGN REVIEW PLANS (7/27/22)

PROPOSED ADDITION FOR:

320 Martin Street - ADDITION

CONDITIONS OF WORK

CONSTRUCTION COORDINATION:

1. ALL CONTRACTORS SHALL REVIEW ALL DRAWINGS & ARE RESPONSIBLE FOR A COMPLETE REVIEW & SITE VISIT. ITEMS AFFECTING ALL TRADES ARE PLACED THROUGHOUT SET & NO "EXTRAS" FOR MISSED ITEMS IN OTHER SECTIONS WILL BE PERMITTED. THE CONTRACTOR SHALL IMMEDIATELY NOTIFY ARCHITECT OF ANY AMBIGUITY, INCONSISTENCY OR ERRORS WHICH THEY DISCOVER UPON EXAMINATION OF DOCUMENTS, THE SITE OR LOCAL

2. ANY CONTRACTOR OR SUBCONTRACTOR BY SUBMITTING A BID WARRANT'S THAT HE HAS VISITED THE SITE AND IS AWARE OF ANY AND ALL SITE CONDITIONS AFFECTING HIS BID.

3. THE CONTRACTOR BY COMMENCING WORK ACCEPTS THE CONDITIONS OF THE SITE & THE COMPLETENESS OF CONTRACT DOCUMENTS.

4. FIELD VERIFY ALL DIMENSIONS AND REPORT ANY DISCREPANCIES IMMEDIATELY TO THE ARCHITECT. DO NOT SCALE DRAWINGS USE FIGURED DIMENSIONS ONLY.

5. ANY MATERIAL OR LABOR NEITHER SHOWN ON THE DRAWINGS NOR SPECIFIED, BUT WHICH IS OBVIOUSLY NECESSARY TO COMPLETE THE WORK IN A WORKMANLIKE MANNER SHALL BE FURNISHED WITHOUT COST TO THE OWNER.

6. ALL MATERIALS FURNISHED AND INSTALLED BY THE GENERAL CONTRACTOR SHALL BE FREE FROM DEFECTS. ALL WORK SHALL BE GUARANTEED FOR A PERIOD OF (1) YEAR FROM DATE OF ACCEPTANCE OF WORK. DURING THIS PERIOD THE GENERAL CONTRACTOR SHALL CORRECT ANY PROBLEMS DUE TO DEFECTIVE MATERIALS OR FAULTY WORKMANSHIP AT NO COST TO THE OWNER. ANY PROBLEM THAT OCCURS DURING CONSTRUCTION SHALL IMMEDIATELY BE CORRECTED TO THE SATISFACTION OF THE OWNER.

7. NO SUBSTITUTIONS OF SPECIFIED MATERIAL OR EQUIPMENT WILL BE ACCEPTED UNLESS WRITTEN REQUEST FOR APPROVAL HAS BEEN RECEIVED BY THE ARCHITECT AND CONTRACTOR HAS RECEIVED WRITTEN APPROVAL FROM ARCHITECT.

8. DURING AND AT THE COMPLETION OF THE CONTRACTOR'S DAILY WORK, CONTRACTOR IS RESPONSIBLE FOR THE CLEANING UP AND REMOVAL OF ALL RUBBISH AND DEBRIS BEFORE LEAVING THE PROJECT JOB SITE.

PERMITS & SAFETY:

1. GENERAL CONTRACTOR SHALL APPLY & SUBMIT FOR BUILDING PERMIT

2. GENERAL CONTRACTOR SHALL OBTAIN "ALL RISK" INSURANCE AND ALL CUSTOMARY STATUTORY INSURANCE FOR COMPREHENSIVE GENERAL LIABILITY, ETC. AS REQUIRED BY

3. GENERAL CONTRACTOR SHALL PROVIDE ADEQUATE PROTECTION OF WORK, MATERIALS, FIXTURES, ETC. IN LEASED SPACE FROM LOSS OR DAMAGE FROM FIRE, THEFT OR

4. ALL WORK SHALL BE DONE IN COMPLIANCE WITH THE OCCUPATIONAL SAFETY AND HEALTH ACT (OSHA). THE FOLLOWING ARE STRICTLY PROHIBITED WORK PRACTICES.

A. ANY COMBUSTIBLE MATERIALS ABOVE FINISHED CEILING OR IN ANY NON-SPRINKLED LOCATIONS.

B. IMPOSING ANY STRUCTURAL LOAD, TEMPORARY OR PERMANENT ON ANY PART OF THE

C. CUTTING ANY HOLES IN LANDLORD'S EXISTING FLOOR SLABS, WALLS OR ROOF WITHOUT PROPER APPROVAL'S PROPER APPROVALS FROM LANDLORD. BEFORE STARTING ANY UNDERSLAB WORK CONTRACTORS MUST CHECK WITH THE LANDLORD OR

SUPERINTENDENT OF THE LANDLORD'S GENERAL CONTRACTOR TO DETERMINE IF ANY

LANDLORD'S WORK OR STRUCTURE WITHOUT PRIOR WRITTEN APPROVAL.

COMMON UTILITY OR OTHER TENANT UTILITY LINES EXIST WITHIN THE SPACE.

CODE COMPLIANCE:

1. WORK INDICATED IS TO BE EXECUTED IN ACCORDANCE WITH THE LATEST EDITIONS OF ALL APPLICABLE CODES.

2. FIRE EXTINGUISHERS SHALL BE PROVIDED BY G.C. AND INSTALLED PER THE FIRE MARSHALL'S INSTRUCTIONS.

3. ALL WALL FINISHES TO MEET CLASS III FLAME SPREAD RATINGS IN ACCORDANCE WITH MBC-2015 CHAPTER 8.

4. INTERIOR FINISHES IN EXIT ACCESS CORRIDORS, OTHER EXIT WAYS, ROOMS, AND ENCLOSED SPACES IN USE GROUPS "B" AND "S" IN SPRINKLED BUILDINGS ARE REQUIRED TO HAVE AT LEAST A CLASS C: FLAME SPREAD 76-200; SMOKE DEVELOPED 0-450; RATING AS LISTED IN THE 2015 MICHIGAN BUILDING CODE.

5. SAFETY GLAZING MUST HAVE PERMANENT IDENTIFICATION IN ACCORDANCE WITH THE 2015 MICHIGAN BUILDING CODE.

6. ALL REQUIREMENTS OF THE MICHIGAN BARRIER FREE ACT & THE AMERICAN'S WITH DISABILITIES ACT SHALL BE MAINTAINED TO COMPLY WITH ICC/A117.1-2009.

7. ALL OFFICE FURNITURE & EQUIPMENT TO BE PROVIDED BY TENANT- SHOWN FOR LAYOUT PURPOSES ONLY. TO COMPLY WITH ADA-ICC/A117.1-2009 (TYP.) REQUIREMENTS, A MINIMUM OF 5%, BUT NOT LESS THAN (1) OF THE LUNCHROOM TABLES AND EMPLOYEE WORKSTATIONS (CUBICLES) SHALL BE ACCESSIBLE. ACCESSIBLE TABLE AND WORKSTATION TOPS SHALL BE 28" MIN. TO 34" MAX. A.F.F. KNEE AND TOE CLEARANCES AS FOLLOWS SHALL ALSO APPLY- TOE: 4" MIN. HIGH, 17" MIN. TO 25" MAX. DEPTH, AND 30" MIN. WIDE. KNEE: 27" MIN. HIGH, 11" DEEP @ 9" HIGH TO 8" DEEP @ 27" HIGH, AND 30" MIN. WIDE.


8. ALL ENTRANCE AND EXIT DOORS SHALL HAVE BARRIER FREE ACCESSIBILITY TO COMPLY WITH ICC/A117.1-2009.

9. TO COMPLY WITH ADA - ICC/A117.1-2009 (TYP.) REQUIREMENTS, CHANGES IN LEVEL GREATER THAN 1/2" SHALL BE RAMPED AND CHANGES IN LEVEL BETWEEN 1/4" AND 1/2" SHALL BE BEVELED A MAXIMUM OF 1:2.

10. ALL LUNCHROOM APPLIANCES TO BE PROVIDED BY TENANT. TO COMPLY WITH ADA-ICC/A117.1-2009 (TYP.) REQUIREMENTS, DISHWASHERS MUST FIT UNDER A 34" HIGH (32 1/4" CLEAR UNDER) COUNTERTOP, THE REFRIGERATOR MUST BE A SIDE-BY-SIDE OR BOTTOM FREEZER UNIT, AND ALL MICROWAVE CONTROLS TO BE NO HIGHER THAN 46" A.F.F. TO MEET OBSTRUCTED HIGH SIDE REACH

11. SIGNAGE INDICATING ACCESSIBILITY PROVISIONS SHALL BE PROVIDED AT EACH DOOR TO AN EXIT DISCHARGE. A TACTILE SIGN STATING EXIT AND COMPLYING WITH ICC/ANSI A117.1-2009 SHALL BE PLACED ADJACENT TO THE DOOR. PLEASE REFER TO SHEET A. 601 FOR ADDITIONAL INFORMATION AND LOCATION.

THE BUILDING IS PROVIDED WITH A FULL AUTOMATIC FIRE PROTECTION SPRINKLER SYSTEM (FIRE SUPPRESSION SYSTEM) WHICH WILL BE DESIGNED TO MEET M.B.C. REQUIREMENTS AND CITY OF BIRMINGHAM INSPECTION AND PERMIT APPROVAL. SPRINKLER CONTRACTOR SHALL BE FULLY LICENSED AND BE RESPONSIBLE FOR PREPARATION OF ENGINEERING DRAWING, SUBMISSION OF DRAWINGS TO ALL LOCAL AND STATE AGENCIES FOR APPROVAL, AND FOR COORDINATION OF REQUIREMENTS WITH OWNERS AND TENANTS INSURANCE CARRIER.

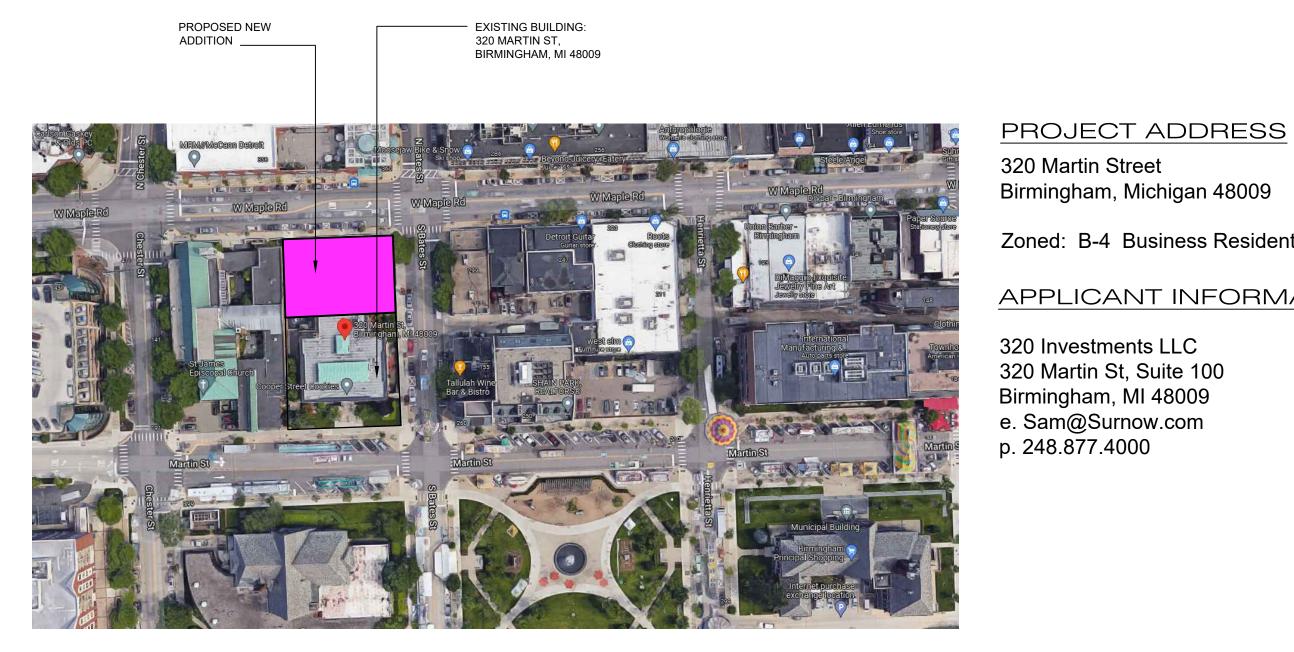





320 Martin Street Birmingham, Michigan 48009

Zoned: B-4 Business Residential

APPLICANT INFORMATION

320 Investments LLC 320 Martin St, Suite 100 Birmingham, MI 48009 e. Sam@Surnow.com p. 248.877.4000

SHEET INDEX

T.101	TITLE SHEET
SP1	BOUNDARY TOPO
SP2	ENGINEERING SITE PLAN
SP.100 SP.101 SP.102 SP.401	SITE SURROUNDINGS SITE PLAN PROPOSED PHOTOMETRIC STUDY
LS.101	LANDSCAPE PLAN
LS.601	LANDSCAPE SCHEDULE
A.101	1st and Lower Level FLOOR PLANS
A.102	2nd and 3rd FLOOR PLANS
A.103	4th and 5th FLOOR PLANS
A.104	ROOF PLAN
A.201	ELEVATIONS
A.202	ELEVATIONS
A.301 A.302 A.303 A.304 A.305 A.306 A.307 A.308 A.309 A.310 A.311 A.312 A.313 A.314 A.315 A.316	3D PERSPECTIVE IMAGE

biddison architecture + design

320 Martin Street Suite 10 Birmingham, MI 48009 t:248.554.9500

Contact Person: Kevin Biddison e.mail: kb@biddison-ad.com

Consultants

Project data

GOVERNING CODES:

2015 MICHIGAN BUILDING CODE 2018 MICHIGAN PLUMBING CODE 2015 MICHIGAN MECHANICAL CODE 2015 MICHIGAN REHABILITATION CODE 2015 INTERNATIONAL FUEL GAS CODE MICHIGAN ELECTRICAL CODE, 2017 N.E.C. W/ PART 8 STATE AMENDMENTS ICC/ANSI A117.1-2015 AND MICHIGAN BARRIER FREE DESIGN LAW OF PUBLIC ACT 1 OF 1966 AS AMENDED. MICHIGAN UNIFORM ENERGY CODE RULES PART 10 WITH ANSI/ASHRAE/IESNA STANDARD 90.1-2015 2015 INTERNATIONAL FIRE CODE NFPA 13 - 2010

BUILDING USE GROUP(S):

GENERAL BUSINESS & RESIDENTIAL

TYPE OF CONSTRUCTION: 2015 MBC: 2B (UN-PROTECTED)

NFPA 220: TYPE II-000

NFPA 72 - 2010

NFPA 13: 2010 NFPA 72: 2010

6,200 SQFT

52,906 SQFT

UNDERGROUND GARAGE AREA:

8,058 SQFT FIRST FLOOR AREA: 9,248 SQFT 9,000 SQFT SECOND FLOOR AREA: THIRD FLOOR AREA: 10,200 SQFT 10,200 SQFT FOURTH FLOOR AREA:


TOTAL ADDITION AREA:

FIFTH FLOOR AREA:

Issued for

HISTORIC DESIGN BOARD REVIEW HISTORIC DESIGN BOARD REVIEW CIS - COMMUNITY IMPACT STUDY FINAL SITE PLAN APPROVAL

01.24.2022 03.09.2022 05.06.2022 06.28.2022

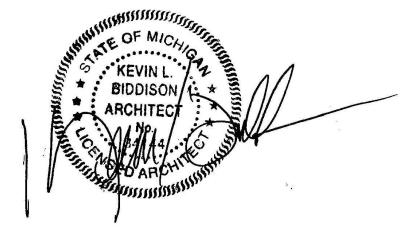



Project no.

320 Martin - ADDITION


2075-21

T.101

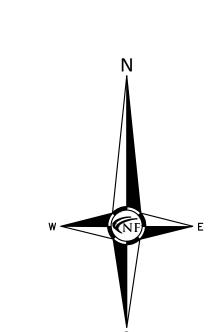

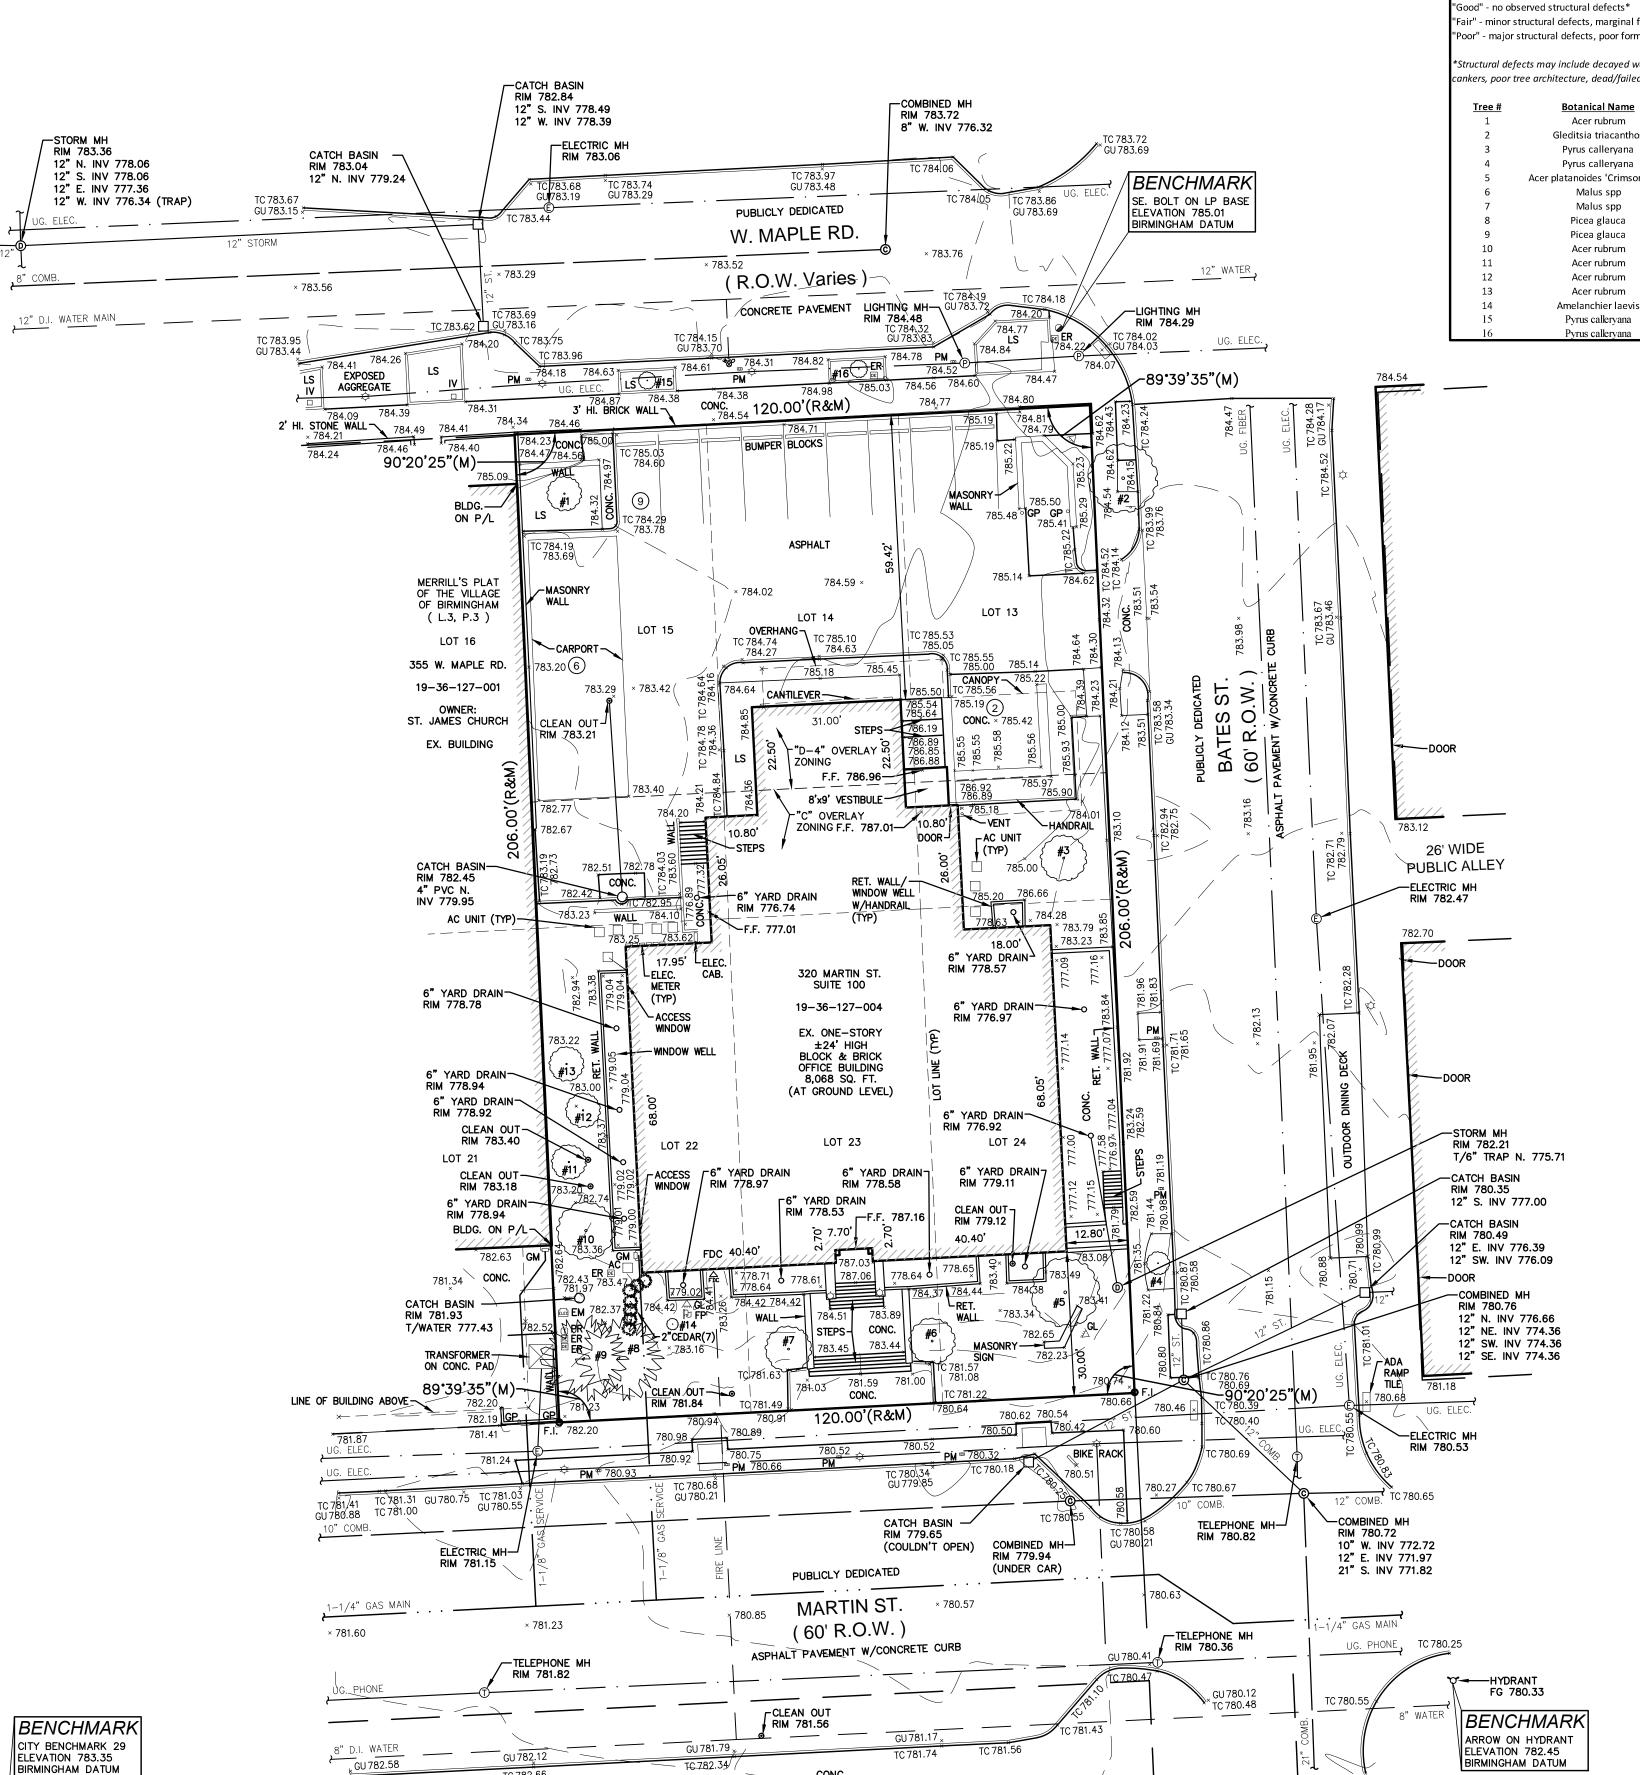

TC 783.08

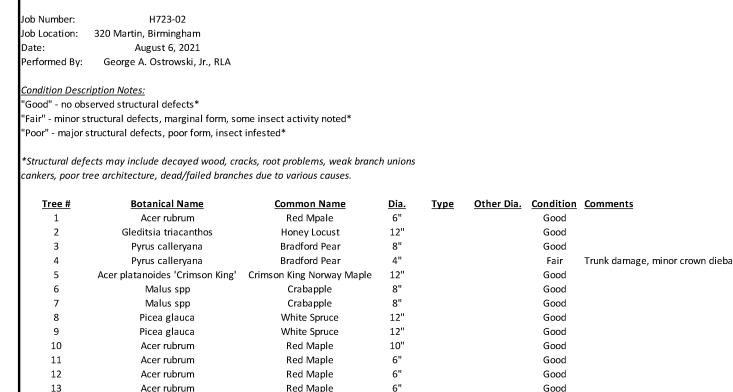

Allegheny Servuiceberry

Bradford Pear

Bradford Pear

LEGAL DESCRIPTION -PER TITLE COMMITMENT

LAND SITUATED IN THE COUNTY OF OAKLAND, CITY OF BIRMINGHAM, STATE OF MICHIGAN, IS DESCRIBED AS FOLLOWS:

LOTS 13, 14, 15, 22, 23, AND 24 OF MERRILL'S PLAT OF THE VILLAGE (NOW CITY) OF BIRMINGHAM, BEING A PART OF THE NORTHEAST 1/4 OF THE NORTHWEST 1/4 OF SECTION 36, T2N, R10E, ACCORDING TO THE PLAT THEREOF, AS RECORDED IN LIBER 3 OF PLATS, PAGE 3, OAKLAND COUNTY RECORDS.

320 MARTIN STREET TAX ID: 19-36-127-004

TITLE REPORT NOTES

SUBJECT TO:

RIGHTS OR CLAIMS OF PARTIES IN POSSESSION NOT SHOWN BY THE

EASEMENTS, OR CLAIMS OF EASEMENTS, NOT SHOWN BY THE PUBLIC

1. TERMS AND CONDITIONS CONTAINED IN AGREEMENT FOR LOAN OF ARTWORK FROM THE POSTAL FINE ARTS COLLECTION BY THE UNITED STATES POSTAL SERVICE TO 320 INVESTMENTS, LLC AND CITY OF BIRMINGHAM HISTORIC COMMITTEE AS DISCLOSED BY INSTRUMENT RECORDED IN LIBER 42129, PAGE 691. [SAID DOCUMENT DOES NOT

2. TERMS AND CONDITIONS CONTAINED IN SPECIAL WARRANTY DEED AS DISCLOSED BY INSTRUMENT RECORDED IN LIBER 42139, PAGE 295. [SAID DOCUMENT DOES NOT DESCRIBE ANY PLOTTABLE EASEMENTS OR RESTRICTIONS 1.

DESCRIBE ANY PLOTTABLE EASEMENTS OR RESTRICTIONS].

ALL EXCEPTIONS SHOWN OR NOTED ON THIS SURVEY WERE OBTAINED FROM TITLE COMMITMENT NO. 643934, WITH AN EFFECTIVE DATE OF 09-06-2013, PRINTED ON 10-01-2013, ISSUED BY FIRST AMERICAN TITLE INSURANCE COMPANY.

DATUM NOTE

ALL ELEVATIONS SHOWN HEREON ARE ON THE CITY OF BIRMINGHAM'S VERTICAL DATUM, REFERENCED HEREON, IS ONE (1.00) FOOT HIGHER THAN THE NORTH AMERICAN VERTICAL DATUM OF 1988 (N.A.V.D. 88).

ALTA SURVEY NOTES

THERE IS NO VISIBLE EVIDENCE OF CURRENT EARTH MOVING WORK, BUILDING CONSTRUCTION OR BUILDING ADDITIONS. THERE IS NO PROPOSED CHANGES IN STREET RIGHT OF WAY LINES AND THERE IS NO EVIDENCE OF RECENT STREET OR

SIDEWALK CONSTRUCTION OR REPAIR. THERE IS NO VISIBLE EVIDENCE OF SITE USE AS A SOLID WASTE DUMP, SUMP OR SANITARY LANDFILL.

THERE IS NO VISIBLE EVIDENCE OF ANY WETLAND AREAS. THERE WAS NO OBSERVABLE EVIDENCE OF CEMETERIES OR BURIAL

LOCATION OF UTILITIES EXISTING ON OR SERVING THE PROPERTY AS DETERMINED BY: OBSERVED EVIDENCE OR EVIDENCE FROM PLANS REQUESTED BY THE SURVEYOR AND OBTAINED FROM

THE SUBJECT PROPERTY HAS ACCESS TO MARTIN STREET, BATES STREET AND W. MAPLE ROAD, ALL BEING PUBLICLY DEDICATED

FLOOD HAZARD NOTE

THE PROPERTY DESCRIBED ON THIS SURVEY DOES NOT LIE WITHIN A SPECIAL FLOOD HAZARD AREA AS DEFINED BY THE FEDERAL EMERGENCY MANAGEMENT AGENCY; THE PROPERTY LIES WITHIN ZONE X OF THE FLOOD INSURANCE RATE MAP IDENTIFIED AS MAP NO. 26125C0537F BEARING AN EFFECTIVE DATE OF 09-29-2006.

MISS DIG / UTILITY DISCLAIMER NOTE

A MISS DIG TICKET NUMBER A011960126, PURSUANT TO MICHIGAN PUBLIC ACT 174 WAS ENTERED FOR THE SURVEYED PROPERTY. DUE TO THE EXTENDED REPORTING PERIOD FOR UNDERGROUND FACILITY OWNERS TO PROVIDE THEIR RECORDS, THE SURVEY MAY NOT REFLECT ALL THE UTILITIES AT THE TIME THE SURVEY WAS ISSUED ON AUGUST 6, 2021. THE SURVEY ONLY REFLECTS THOSE UTILITIES WHICH COULD BE OBSERVED BY THE SURVEYOR IN THE FIELD OR AS DEPICTED BY THE UTILITY COMPANY RECORDS FURNISH PRIOR TO THE DATE THIS SURVEY WAS ISSUED. THE CLIENT AND/OR THEIR AUTHORIZED AGENT SHALL VERIFY WITH THE FACILITY OWNERS AND/OR THEIR AUTHORIZED AGENTS, THE COMPLETENESS AND EXACTNESS OF THE UTILITIES LOCATION.


TOPOGRAPHIC SURVEY NOTES ALL ELEVATIONS ARE EXISTING ELEVATIONS, UNLESS OTHERWISE

UTILITY LOCATIONS WERE OBTAINED FROM MUNICIPAL OFFICIALS AND

RECORDS OF UTILITY COMPANIES, AND NO GUARANTEE CAN BE MADE TO THE COMPLETENESS, OR EXACTNESS OF LOCATION. THIS SURVEY MAY NOT SHOW ALL EASEMENTS OF RECORD UNLESS AN UPDATED TITLE POLICY IS FURNISHED TO THE SURVEYOR BY

DTE DISCLAIMER NOTE

PLEASE NOTE THAT DTE HAS NEW REGULATIONS THAT MAY IMPACT DEVELOPMENT OUTSIDE THEIR EASEMENT OR THE PUBLIC RIGHT OF WAY. CLIENT SHALL CONTACT DTE TO DETERMINE THE "NEW STRUCTURES AND POWER LINE" REQUIREMENTS AS THEY MAY APPLY TO ANY FUTURE BUILDING OR RENOVATION OF A STRUCTURE. DTE ENERGY CAN BE CONTACTED AT 800-477-4747

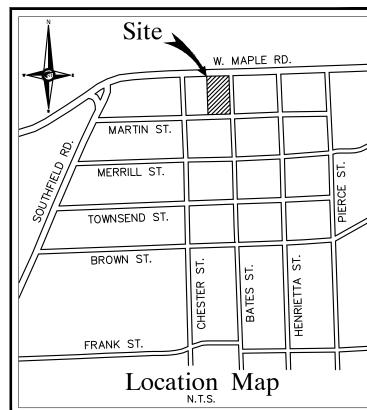

CERTIFICATE OF SURVEY

-320 INVESTMENTS, LLC, A MICHIGAN LIMITED LIABILITY COMPANY -UNITED FARM FAMILY LIFE INSURANCE COMPANY -UNITED FARM FAMILY MUTUAL INSURANCE COMPANY -AMROCK INC. -FIDELITY NATIONAL TITLE INSURANCE COMPANY -BINGHAM GREENEBAUM DOLL LLP

THIS IS TO CERTIFY THAT THIS MAP OR PLAT AND THE SURVEY ON WHICH IT IS BASED WERE MADE IN ACCORDANCE WITH THE 2021 MINIMUM STANDARD DETAIL REQUIREMENTS FOR ALTA/NSPS LAND TITLE SURVEYS, JOINTLY ESTABLISHED AND ADOPTED BY ALTA AND NSPS, AND INCLUDE ITEMS 1, 2, 3, 4, 6(a), 6(b), 7(a), 7(b)(1), 7(c), 8, 9, 11(a), 13, 14, 16, 17, 18 AND 19 OF TABLE A THEREOF.

THE FIELD WORK WAS COMPLETED ON JULY 22, 2021.					
	8-6-2021				
KEVIN NAVAROLI, P.S. NO. 4001053503	DATE				

SURVEY DATA

GROSS LAND AREA: 24,720 SQUARE FEET OR 0.567 ACRES. ZONED: B-4 (BUSINESS-RESIDENTIAL DISTRICT) WITH OVERLAY ZONING DISTRICTS C (TERMINATING VISTAS) & D-4 (DOWNTOWN FOUR-STORY)

BUILDING SETBACKS:

LEGEND

MANHOLE(MH)

MANHOLE(MH) CATCH BASIN(CB)

∰ LP

ASPH.

CONC.

FD. / FND.

RET. WALL

R.O.W.

(TYP)

C/L

P/L

UTILITY POLE GUY POLE

____/√-

SIDES= 0': COMMERCIAL, OFFICE OR PARKING STORIES RESIDENTIAL STORIES WITH WALLS FACING SIDE LOT LINES WHICH DO NOT CONTAIN WINDOWS OR FRONT ON A 10' WHEN ANY WALL IN RESIDENTIAL STORIES WHICH CONTAIN WINDOWS AND WHEN SIDE LOT LINES ABUT A STREET REAR= 10' WHEN THE REAR OPEN SPACE ABUTS A P, B1, B2, B2C, B3, B4, O1 OR O2 ZONING DISTRICT 20' WHEN ADJACENT TO A RESIDENTIAL ZONING

FRONT: BUILDING FACADES AT THE FIRST STORY SHALL BE LOCATED AT THE FRONTAGE LINE, EXCEPT THE PLANNING BOARD MAY ADJUST THE REQUIRED FRONT YARD TO THE AVERAGE FRONT SETRACK OF ANY BUILDING SIDE: SHALL NOT BE REQUIRED REAR: A MINIMUM OF 10' SHALL BE PROVIDED FROM THE MIDPOINT OF THE ALLEY, EXCEPT THAT THE PLANNING BOARD MAY ALLOW THIS SETBACK TO BE REDUCED OR ELIMINATED. IN THE ABSENCE OF AN ALLEY, THE REAR SETBACK SHALL BE

EQUAL TO THAT OF AN ADJACENT, PREEXISTING BUILDING MAX. BUILDING HEIGHT PERMITTED: B-4: 4 STORIES /48' D-4: 5 STORIES/80' BUILDING HEIGHT SHALL COMPLY WITH THE UNDERLYING

HEIGHT RESTRICTIONS LISTED IN EACH TWO-PAGE LAYOUT IN ART. 2 OF THE ZONING ORDINANCE, BUT MAY BE NEGOTIATED BY THE

TOTAL STRIPED PARKING: 17 SPACES INCLUDING 0 BARRIER FREE

THE ABOVE SETBACK & HEIGHT REQUIREMENTS WERE OBTAINED FROM THE CITY OF BIRMINGHAM ZONING ORDINANCE. NOTE: THE BUILDING SETBACK LINES ARE NOT PLOTTED HEREON. THE SURVEYOR CANNOT MAKE A CERTIFICATION BASED ON AN INTERPRETATION OF THE BIRMINGHAM ZONING ORDINANCE. A ZONING ENDORSEMENT LETTER SHOULD BE OBTAINED FROM THE CITY OF BIRMINGHAM TO INSURE CONFORMITY.

HYDRANT(HYD)

GATE VALVE(GVW)

EXISTING WATER MAIN

GUY WIRE

—— EXISTING SAN. CLEAN OUT

EXISTING STORM SEWER

EX. BEEHIVE CATCH BASIN

OVERHEAD (OH.) LINES

EXISTING GAS MAIN

EX. UNDERGROUND (UG.) CABL

LIGHT POLE

ASPHALT

CONCRETE

RETAINING WALL

RIGHT-OF-WAY

SET PK NAIL

TYPICAL

RECORD

MEASURED

CENTERLINE

GAS METER ELECTRIC METER LANDSCAPE

DOWNSPOUT ELECTRIC RISER

FLAG POLE

GROUND LIGHT

PARKING METER


IRRIGATION VALVE


PHONE RISER

PROPERTY LINE

FOUND

SIGN

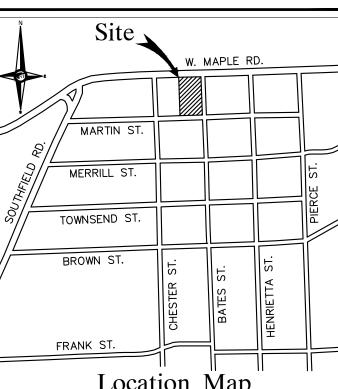

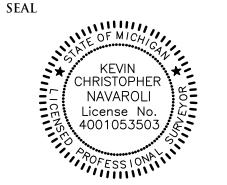

ENGINEERS

CIVIL ENGINEERS

LAND SURVEYORS

LAND PLANNERS

NOWAK & FRAUS ENGINEERS

46777 WOODWARD AVE.

PONTIAC, MI 48342-5032

TEL. (248) 332-7931

FAX. (248) 332-8257

WWW.NOWAKFRAUS.COM

PROJECT

320 Martin Street Birmingham, MI 48009

CLIENT

320 Investments, LLC c/o The Surnow Company 320 Martin Street, Suite 100 Birmingham, MI 48009

Contact: Sam Surnow Phone: 248.877.4000 Email: sam@surnow.com

PROJECT LOCATION

Part of the NW 1/4 of Section 36 T.2N., R.10E., City of Birmingham, Oakland County, Michigan


SHEET

ALTA/NSPS Land Title Topographic / Tree Survey



DATE	ISSUED/REVISED
08-06-21 SU	RVEY ISSUED
05-04-22 REV	VISED PER ARCHITECT
DRAWN	
M. Car	rnaghi
	ED DV
DESIGNI	ED BY:
DESIGNI	ED BY:
APPROVI	ED BY:
	ED BY:
APPROVI	ED BY:
APPROVI K. Nav	ED BY:
APPROVE K. Nav DATE: August	ed BY: varoli t 6, 2021
APPROVI K. Nav	ED BY: raroli
APPROVE K. Nav DATE: August SCALE:	ed by: raroli t 6, 2021 1" = 20'

SP1

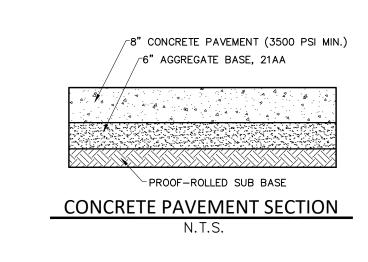

TC 783.97 GU 783.48

PUBLICLY DEDICATED

W. MAPLE RD.

(R.O.W. Varies)

RIM 783.72

8" W. INV 776.32

CATCH BASIN RIM 782.84

CATCH BASIN

12" N. INV 779.24

RIM 783.04

× 783.56

12" STORM

-STORM MH

RIM 783.36

, 12" D.I. WATER MAIN____

12" N. INV 778.06

12" S. INV 778.06

12" W. INV 776.34 (TRAP)


12" E. INV 777.36

12" S. INV 778.49

12" W. INV 778.39

-ELECTRIC MH

RIM 783.06

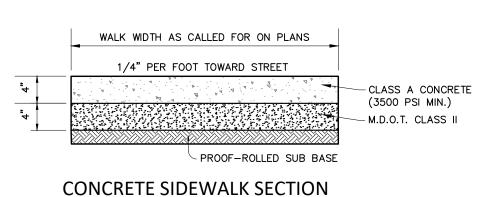


|BENCHMARK


SE. BOLT ON LP BASE

BIRMINGHAM DATUM

ELEVATION 785.01

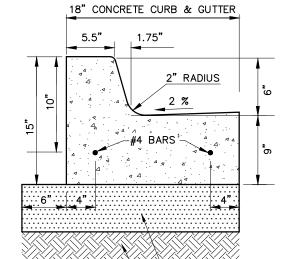


6" AGGREGATE BASE, 21AA -APPROVED SUBGRADE CONCRETE CURB DETAIL 'A'

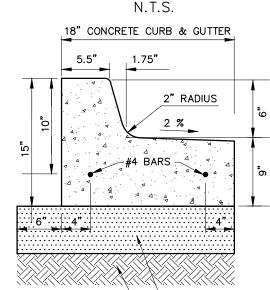

ELEVATION 782.45


BIRMINGHAM DATUM

6" AGGREGATE BASE, 21AA -APPROVED SUBGRADE CONCRETE CURB DETAIL 'B'

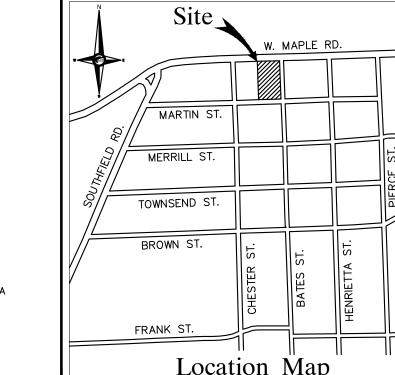

LEGAL DESCRIPTION -PER TITLE COMMITMENT

LOTS 13, 14, 15, 22, 23, AND 24 OF MERRILL'S PLAT OF THE VILLAGE (NOW CITY) OF BIRMINGHAM, BEING A PART OF THE NORTHEAST 1/4 OF THE NORTHWEST 1/4 OF SECTION 36, T2N OF PLATS, PAGE 3, OAKLAND COUNTY RECORDS.

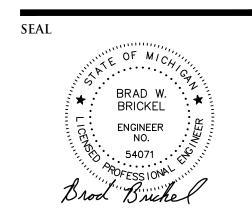

ENGINEERS

CIVIL ENGINEERS

LAND SURVEYORS LAND PLANNERS

NOWAK & FRAUS ENGINEERS

46777 WOODWARD AVE.

PONTIAC, MI 48342-5032

TEL. (248) 332-7931

FAX. (248) 332-8257

WWW.NOWAKFRAUS.COM

PROJECT 320 Martin Street Birmingham, MI 48009

CLIENT 320 Investments, LLC c/o The Surnow Company 320 Martin Street, Suite 100

Contact: Sam Surnow Phone: 248.877.4000


PROJECT LOCATION Part of the NW 1/4 of Section 36 T.2N., R.10E., City of Birmingham,

SHEET

ZONING
EXISTING: B-4, BUSINESS RESIDENTIAL DISTRICT
OVERLAY DISTRICT: C, D-4
HISTORIC DISTRICT: SHANE PARK 100.0% 61.9% 18.4% 19.7% 4,870.05 SFT.




TRASH TO BE COLLECTED INTERNALLY, NO EXTERIOR DUMPSTER ENCLOSURE REQUIRED FOR THIS PROJECT. DATE 08-06-21 SURVEY ISSUED

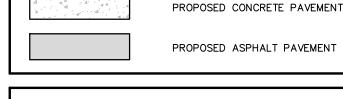


EXISTING SITE AREA GROSS/NET: 24,719.564 SQUARE FEET OR 0.567 ACRES

REFER TO ARCHITECTURAL PLANS FOR PARKING CALCULATIONS AND

DETAILED DESIGN AND CALCULATIONS SHALL BE PROVIDED FOR DURING THE ENGINEERING REVIEW OF THIS PROJECT.

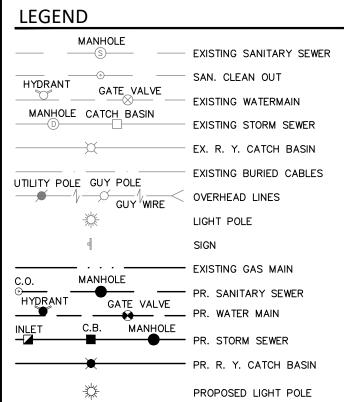

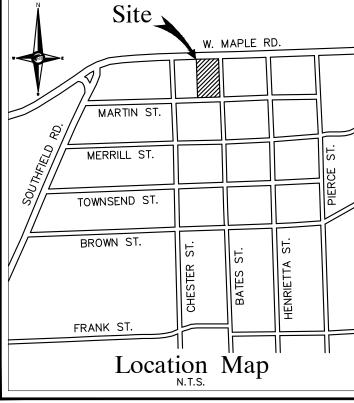

LAND SITUATED IN THE COUNTY OF OAKLAND, CITY OF BIRMINGHAM, STATE OF MICHIGAN, IS DESCRIBED AS FOLLOWS:

R10E, ACCORDING TO THE PLAT THEREOF, AS RECORDED IN LIBER 3

SITE DATA

BUILDING FOOTPRINT PARKING & DRIVES OPEN SPACE

FRONT:

PARKING DATA:


DETAILS (TYP)

SETBACK REQUIREMENTS FRONT:

DETENTION NOTE

PAVING LEGEND

TRASH COLLECTION NOTE

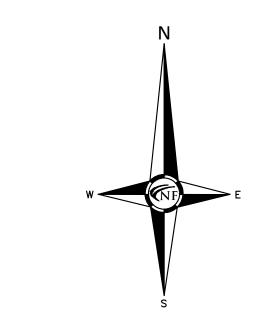

Birmingham, MI 48009

Email: sam@surnow.com

Oakland County, Michigan

Engineering Site Plan



ISSUED/REVISED 05-04-22 REVISED PER ARCHITECT DRAWN BY: R. Johnson

DESIGNED BY: B. Brickel APPROVED BY: B. Brickel DATE: August 6, 2021 SCALE: 1'' = 20'


SHEET NO.

SP2

NFE JOB NO.

H723-02

RIM 784.29 RIGHT-OF-WAY+ LINE (TYP) ~89°39'35"(M) FIRE/DOMESTIC PR. 6" SANITARY -RIGHT-OF-WAY WATER SERVICE SEWER LEAD LINE (TYP) MAN DOOR ₩AN DOOR -EX. PAVEMENT TO (TYP) PR. 5 STORY2,450 SQ.FT BE STRIPED FOR VEHICLE QUEUING MIXED-USE BUILDING RETAIL/RESIDENTIAL PR. CONCRETE DRÍVE APPROACH PER CITY 7,940 SFT. (Footprint) OF BIRMINGHAM STANDARDS (TYP) OF BIRMINGHA ∠PR. 4" CONCRETE ∠PR. 6" CONCRETE (L.3, P.3) SIDEWALK (TYP) SIDEWALK (TYP) PR. INTERNAL VEHICLE LIFT PR. BUILDING TO LOWER OVERHANG (1 LEVEL PARKING 355 W. MAPLE RD. PR. ELEVATOR-19-36-127-001 ST. JAMES CHURCH 巴公 EX. BUILDING MAN DOOR ⊢PR. 4" CONCRETE 26' WIDE SIDEWALK (TYP) PUBLIC ALLEY OUTDOOR PATIÓ RIM 782.45 WINDOW WELL RIM 782.47 INV 779.95 AC UNIT (TY PR. LANDSCAPED AREA 7(TYPI) PROPERTY LINE -6" YARD DRAIN⁴ (TYP) RIM 778.57 SUITE 100 `–COMMÚNITY 6" YARD DRAIN THREAD PARK RIM 778.78 19-36-127-004 RIM 776.97 WINDOW EX. ONE-STORY BLOCK & BRICK 6" YARD DRAIN-8,068 SQ. FT. RIM 778.94 (AT GROUND LEVEL) 6" YARD DRAIN RIM 778.92 6" YARD DRAIN-RIM 776.92 CLEAN OUT RIM 783.40 RIM 782.21 T/6" TRAP N. 775.71 LOT 21 CLEAN OUT ¥ window | RIM 7,8.97 RIM 778.58 RIM 783.18 12" S. INV 777.00 6" YARD DRAIN RIM 778.94 PR. 4" CONCRETE RIM 779.12 -CATCH BASIN BLDG. ON P/ SIDEWALK (TYP) RIM 780.49 12" E. INV 776.39 12" SW. INV 776.09 781.34 \ CONC. CATCH BASIN -RIM 781.93 12" N. INV 776.66 T/WATER 777.43 12" NE. INV 774.36 12" SW. INV 774.36 TRANSFORMER -12" SE. INV 774.36 89'39'35"(M) LINE OF BUILDING ABOV RIM 780.53 12" COMB. TC 780.65 CATCH BASIN -RIM 780.72 10" W. INV 772.72 (COULDN'T OPEN) 12" E. INV 771.97 (UNDER CAR) 21" S. INV 771.82 MARTIN ST. (60' R.O.W. × 781.60 ASPHALT PAVEMENT W/CONCRETE CURB UG. PHONE, TC 780.25 RIM 780.36 FG 780.33 ** TC 780.48 BENCHMARK ARROW ON HYDRANT

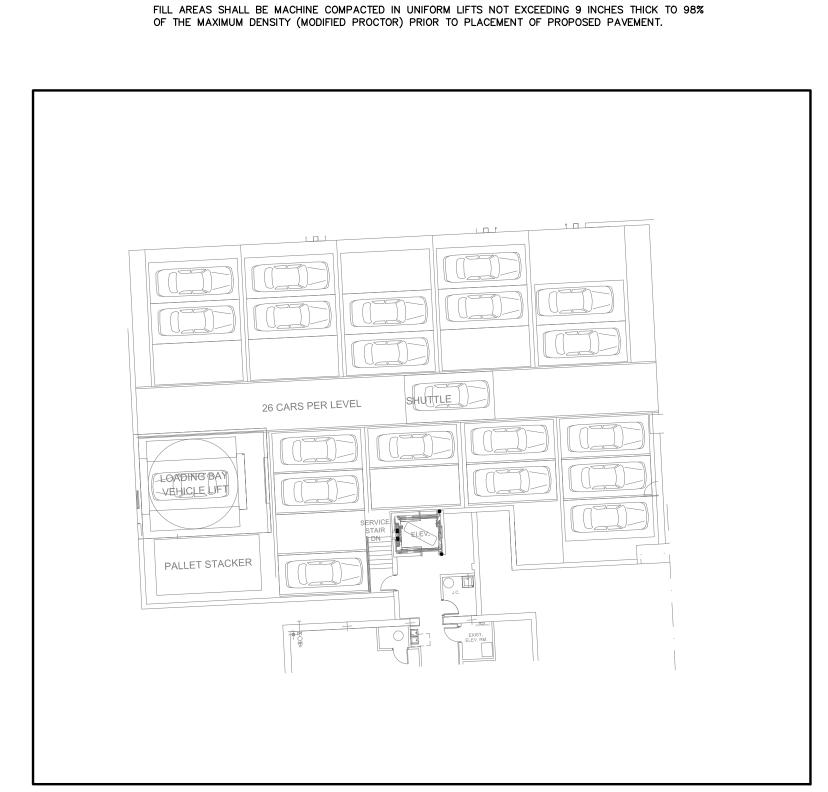

GENERAL PAVING NOTES

SLUMP OF 1 1/2 TO 3 INCHES.

PRESENCE OF THE ENGINEER TO DETERMINE STABILITY.

FROM THE AGENCY HAVING JURISDICTION OVER SAID ROADWAY.

ALL NECESSARY PERMITS AND LIKEWISE ARRANGE FOR ALL INSPECTION.

PROPOSED PAVEMENT AREA PRIOR TO PLACEMENT OF BASE MATERIALS.

EXPANSION JOINTS SHOULD BE INSTALLED AT THE END OF ALL INTERSECTION RADII.

CURB UNLESS OTHERWISE NOTED.

AS FOLLOWS:

PAVEMENT SHALL BE OF THE TYPE, THICKNESS AND CROSS SECTION AS INDICATED ON THE PLANS AND

CONCRETE: PORTLAND CEMENT TYPE IA (AIR-ENTRAINED) WITH A MINIMUM CEMENT CONTENT OF SIX SACKS PER CUBIC YARD, MINIMUM 28 DAY COMPRESSIVE STRENGTH OF 3,500 PSI AND A

PAVEMENT BASE SHALL BE COMPACTED TO 95% OF THE MAXIMUM DENSITY (MODIFIED PROCTOR) PRIOR TO PLACEMENT OF PROPOSED PAVEMENT. EXISTING SUB-BASE SHALL BE PROOF-ROLLED IN THE

ALL CONCRETE PAVEMENT, DRIVEWAYS, CURB & GUTTER, ETC., SHALL BE SPRAY CURED WITH WHITE

ALL CONCRETE PAVEMENT JOINTS SHALL BE FILLED WITH HOT POURED RUBBERIZED ASPHALT JOINT

ALL TOP OF CURB ELEVATIONS, AS SHOWN ON THE PLANS, ARE CALCULATED FOR A 6" CONCRETE

ALL SIDEWALK RAMPS, CONFORMING TO PUBLIC ACT NO. 8, 1993, SHALL BE INSTALLED AS INDICATED

CONSTRUCTION OF A NEW OR RECONSTRUCTED DRIVE APPROACH CONNECTING TO AN EXISTING STATE OR COUNTY ROADWAY SHALL BE ALLOWED ONLY AFTER AN APPROVED PERMIT HAS BEEN SECURED

FOR ANY WORK WITHIN THE PUBLIC RIGHT-OF-WAY, THE CONTRACTOR SHALL PAY FOR AND SECURE

EXISTING TOPSOIL, VEGETATION AND ORGANIC MATERIALS SHALL BE STRIPPED AND REMOVED FROM

SIDEWALK RAMPS, CONFORMING TO PUBLIC ACT NO. 8, 1973, SHALL BE INSTALLED AS SHOWN AT ALL

STREET INTERSECTIONS AND AT ALL BARRIER FREE PARKING AREAS AS INDICATED ON THE PLANS.

ALL PAVEMENT AREAS SHALL BE PROOF—ROLLED UNDER THE SUPERVISION OF A GEOTECHNICAL ENGINEER PRIOR TO THE PLACEMENT OF BASE MATERIALS AND PAVING MATERIALS.

ALL WORKMANSHIP AND MATERIALS SHALL BE IN ACCORDANCE WITH THE CURRENT STANDARDS AND SPECIFICATIONS OF THE MUNICIPALITY AND THE MICHIGAN DEPARTMENT OF TRANSPORTATION STANDARD SPECIFICATIONS FOR CONSTRUCTION, CURRENT EDITION.

SEALING COMPOUND IMMEDIATELY AFTER SAWCUT OPERATION. FEDERAL SPECIFICATION SS-S164.

MEMBRANE CURING COMPOUND IMMEDIATELY FOLLOWING FINISHING OPERATION.


BASE COURSE — MDOT BITUMINOUS MIXTURE NO. 1100L, 20AA; SURFACE COURSE — MDOT BITUMINOUS MIXTURE NO. 1100T, 20AA; ASPHALT CEMENT PENETRATION GRADE 85—100, BOND COAT — MDOT SS—1H EMULSION AT 0.10 GALLON PER SQUARE YARD;

BELOW GROUND PARKING DETAIL (REFER TO ARCHITECTURAL DRAWINGS) SCALE 1" = 20'







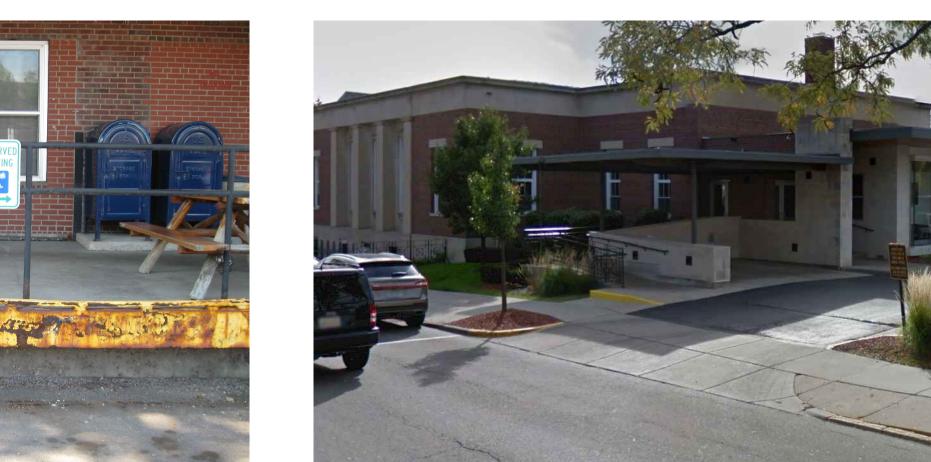

PROPOSED PROJECT FOR: 320 Martin - Addition

EXIST. SITE CONDITIONS - IMAGES

320 Martin St Birmingham, MI 48009

biddison |

320 Martin St. Suite 10 Birmingham, MI 48009 t:248.554.9500

arrolimeioterotureeign design

Consultants






ORIGINAL SITE CONDITIONS - IMAGES NO SCALE







NO SCALE

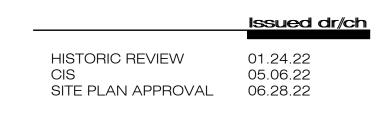








EXIST. SITE SURROUNDINGS - IMAGES NO SCALE

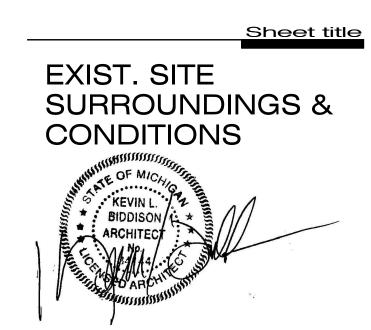

2075.21

LL3SW-1.5-30-ENC-STD- LL3SW-1.5-30-ENC-STD-TL-ST

Q-Tran

1.68

12'-0"

Sheet no.

SP.102

MOUNTING HEIGHT IS MEASURED FROM GRADE TO FACE OF FIXTURE. POLE HEIGHT SHOULD BE CALCULATED AS THE MOUNTING HEIGHT LESS BASE HEIGHT.

EXIST. STREET LIGHT

MARTIN

S

刀

П

 \Box

EXIST. RELOCATED STREET LIGHT -

EXIST. STREET LIGHT

BIKE

RACK

General Note

COMPLIANCE.

EXIST.

EQUIP.

+ ENTRANCE + OIL

NEW STREET LIGHT FIXTURE BY

'HADCO' (TYP OF 4 ON BATES)

-ALIGN WITH EXIST. FIXTURES ACROSS THE STREET ----

1. SEE DRAWING FOR LUMINAIRE MOUNTING HEIGHT.

2. CALCULATIONS ARE SHOWN IN FOOTCANDLES AT: 6' - 0"

MOUNTING HEIGHTS INDICATED ARE FROM GRADE AND/OR FLOOR UP.

HISTORICAL

PLAQUE -



TYP. BENCH (PER CITY)




TYP. TRASH (PER CITY)

SCALE: N.T.S.




TYP. BOLLARD LIGHT FIXTURE SCALE: N.T.S.

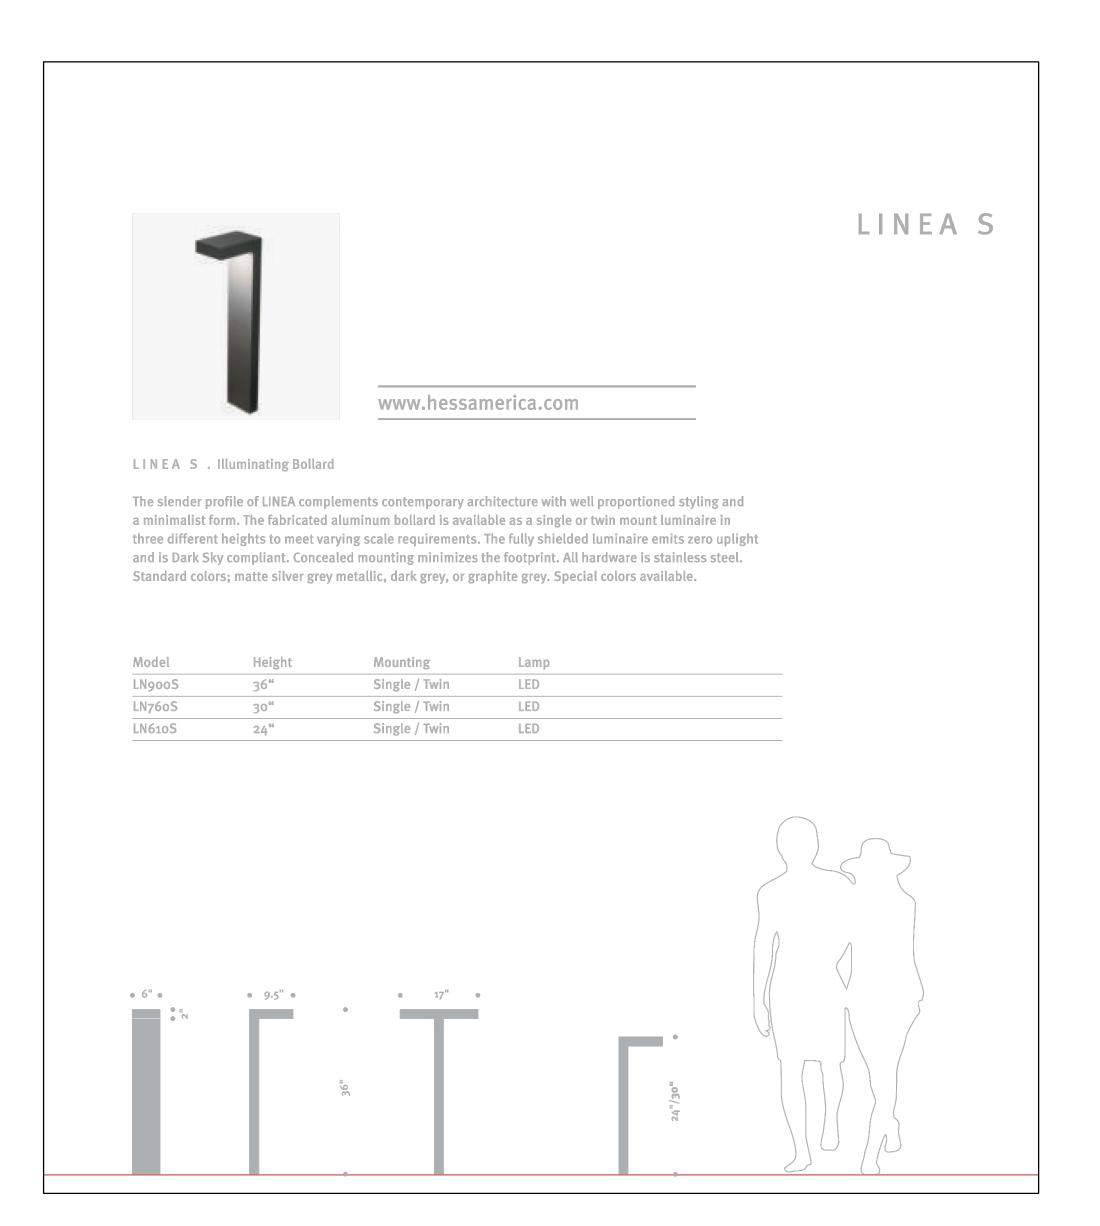

TYP. BOLLARD LIGHT FIXTURE-CUTSHEET SCALE: N.T.S.

Figure DD-4 - 90, 105, 115, 130 Ton Heating/Cooling and Cooling Only Rooftops⁶ EXHAUST AIR OUTDOOR AIR 1 3/8" DRAIN HOLE LIFTING POINTS 20 2 1/2" 1 1/4" CONDENSATE DRAIN (BOTH SIDES) (6 REQ'D) 1/3/8" DIA. DRAIN HOLES (BOTH SIDES)

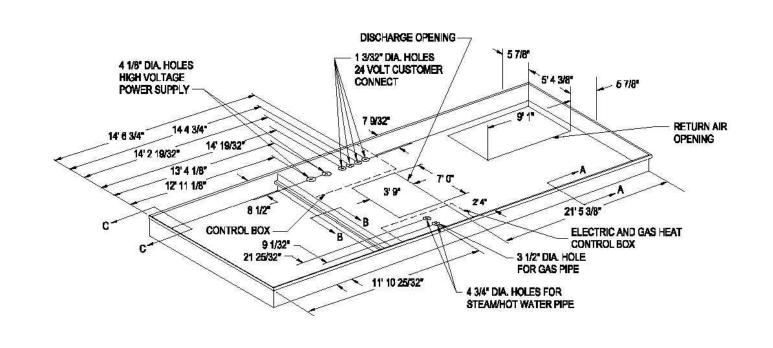

Luminaire

Scale 1:12

BIRMINGHAM GREEN

OPAL ACRYLIC

Lumilock LED Specifications:

rated optical system.

suppression.

Standards.

FINISH: MARINE GRADE

INTERNAL CONTROL OPTIONS:

64, 4000K (warm) LEDs, typical 75
 Color Rendering Index (CRI),
 >100,000 hours of operational life

(at 25°C ambient temperature & 70%|

lumen maintenance), injection molded Type V Short optical plates, IP66

Detail

RTU CUTSHEET

Birmingham Green

POLE ASSEMBLY:

4"-3" ROUND TAPERED

0.125" WALL THICKNESS,

TRANSFORMER BASE: _CAST_ALUMINUM_W/_ADAPTOR

TO MEET DETROIT EDISON

CODE 98 MTG. STANDARD

SCALE: N.T.S.

C DREAM HAND TO BE THEFTER

12.50

CAST ALUMINUM BASE

SMOOTH ALUMINUM,

W/ ACCESS COVER

Finish: Marine Grade

Ordering Guide

S7002F: LUMINAIRE

SP7002A: POLE ASSEMBLY

Modifications: GX4 lumilock module,

Birmingham green color, marine grade finish.



BIKE RACK DETAIL SCALE: N.T.S.



PROPOSED PROJECT FOR: 320 Martin - Addition

320 Martin St

Birmingham, MI 48009

CIS SITE PLAN APPROVAL

05.06.22

06.28.22

biddison I


320 Martin St. Suite 10 Birmingham, MI 48009

t:248.554.9500

architecture + design

Consultants



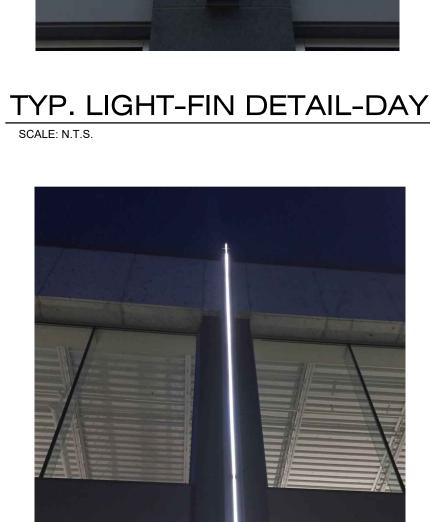

TYP. LIGHT-FIN DETAIL-NIGHT

SCALE: N.T.S.

Sheet title PROPOSED SITE DETAILS Project no. 2075.21

Sheet no.

SP.401

100 Craftway Drive Littlestown, Pa 17340 Phone 800-937-5483 Fax 717-359-0618 www.signify.com

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NOTICE:
This drawing is for reference only.
Check for latest revision prior to

HADCO

SDK

HADCO

CUSTOMER

benefit of Hadco.


- Integral Advance Xitanium LED driver, class 1, IP66 rated, 350mA, 0-10V dimming, IntelliVolt 120-277 vac, 50—60Hz, RoHS compliant, field | City of Birmingham replaceable 10kV/10kA surge | — Hamilton Row Manufactured to ISO 9001:2008 H. Kuhn S7002F fixture as shown is not third party (ETL/UL) listed.

] 1:16 | 01/22/16 DRAWING NUMBER: S7002-DWG06

Midwest Lighting

REV: C PCN: 18/009

BY: SMK DATE: 09/02/18 TYP. LIGHT POLE DETAIL

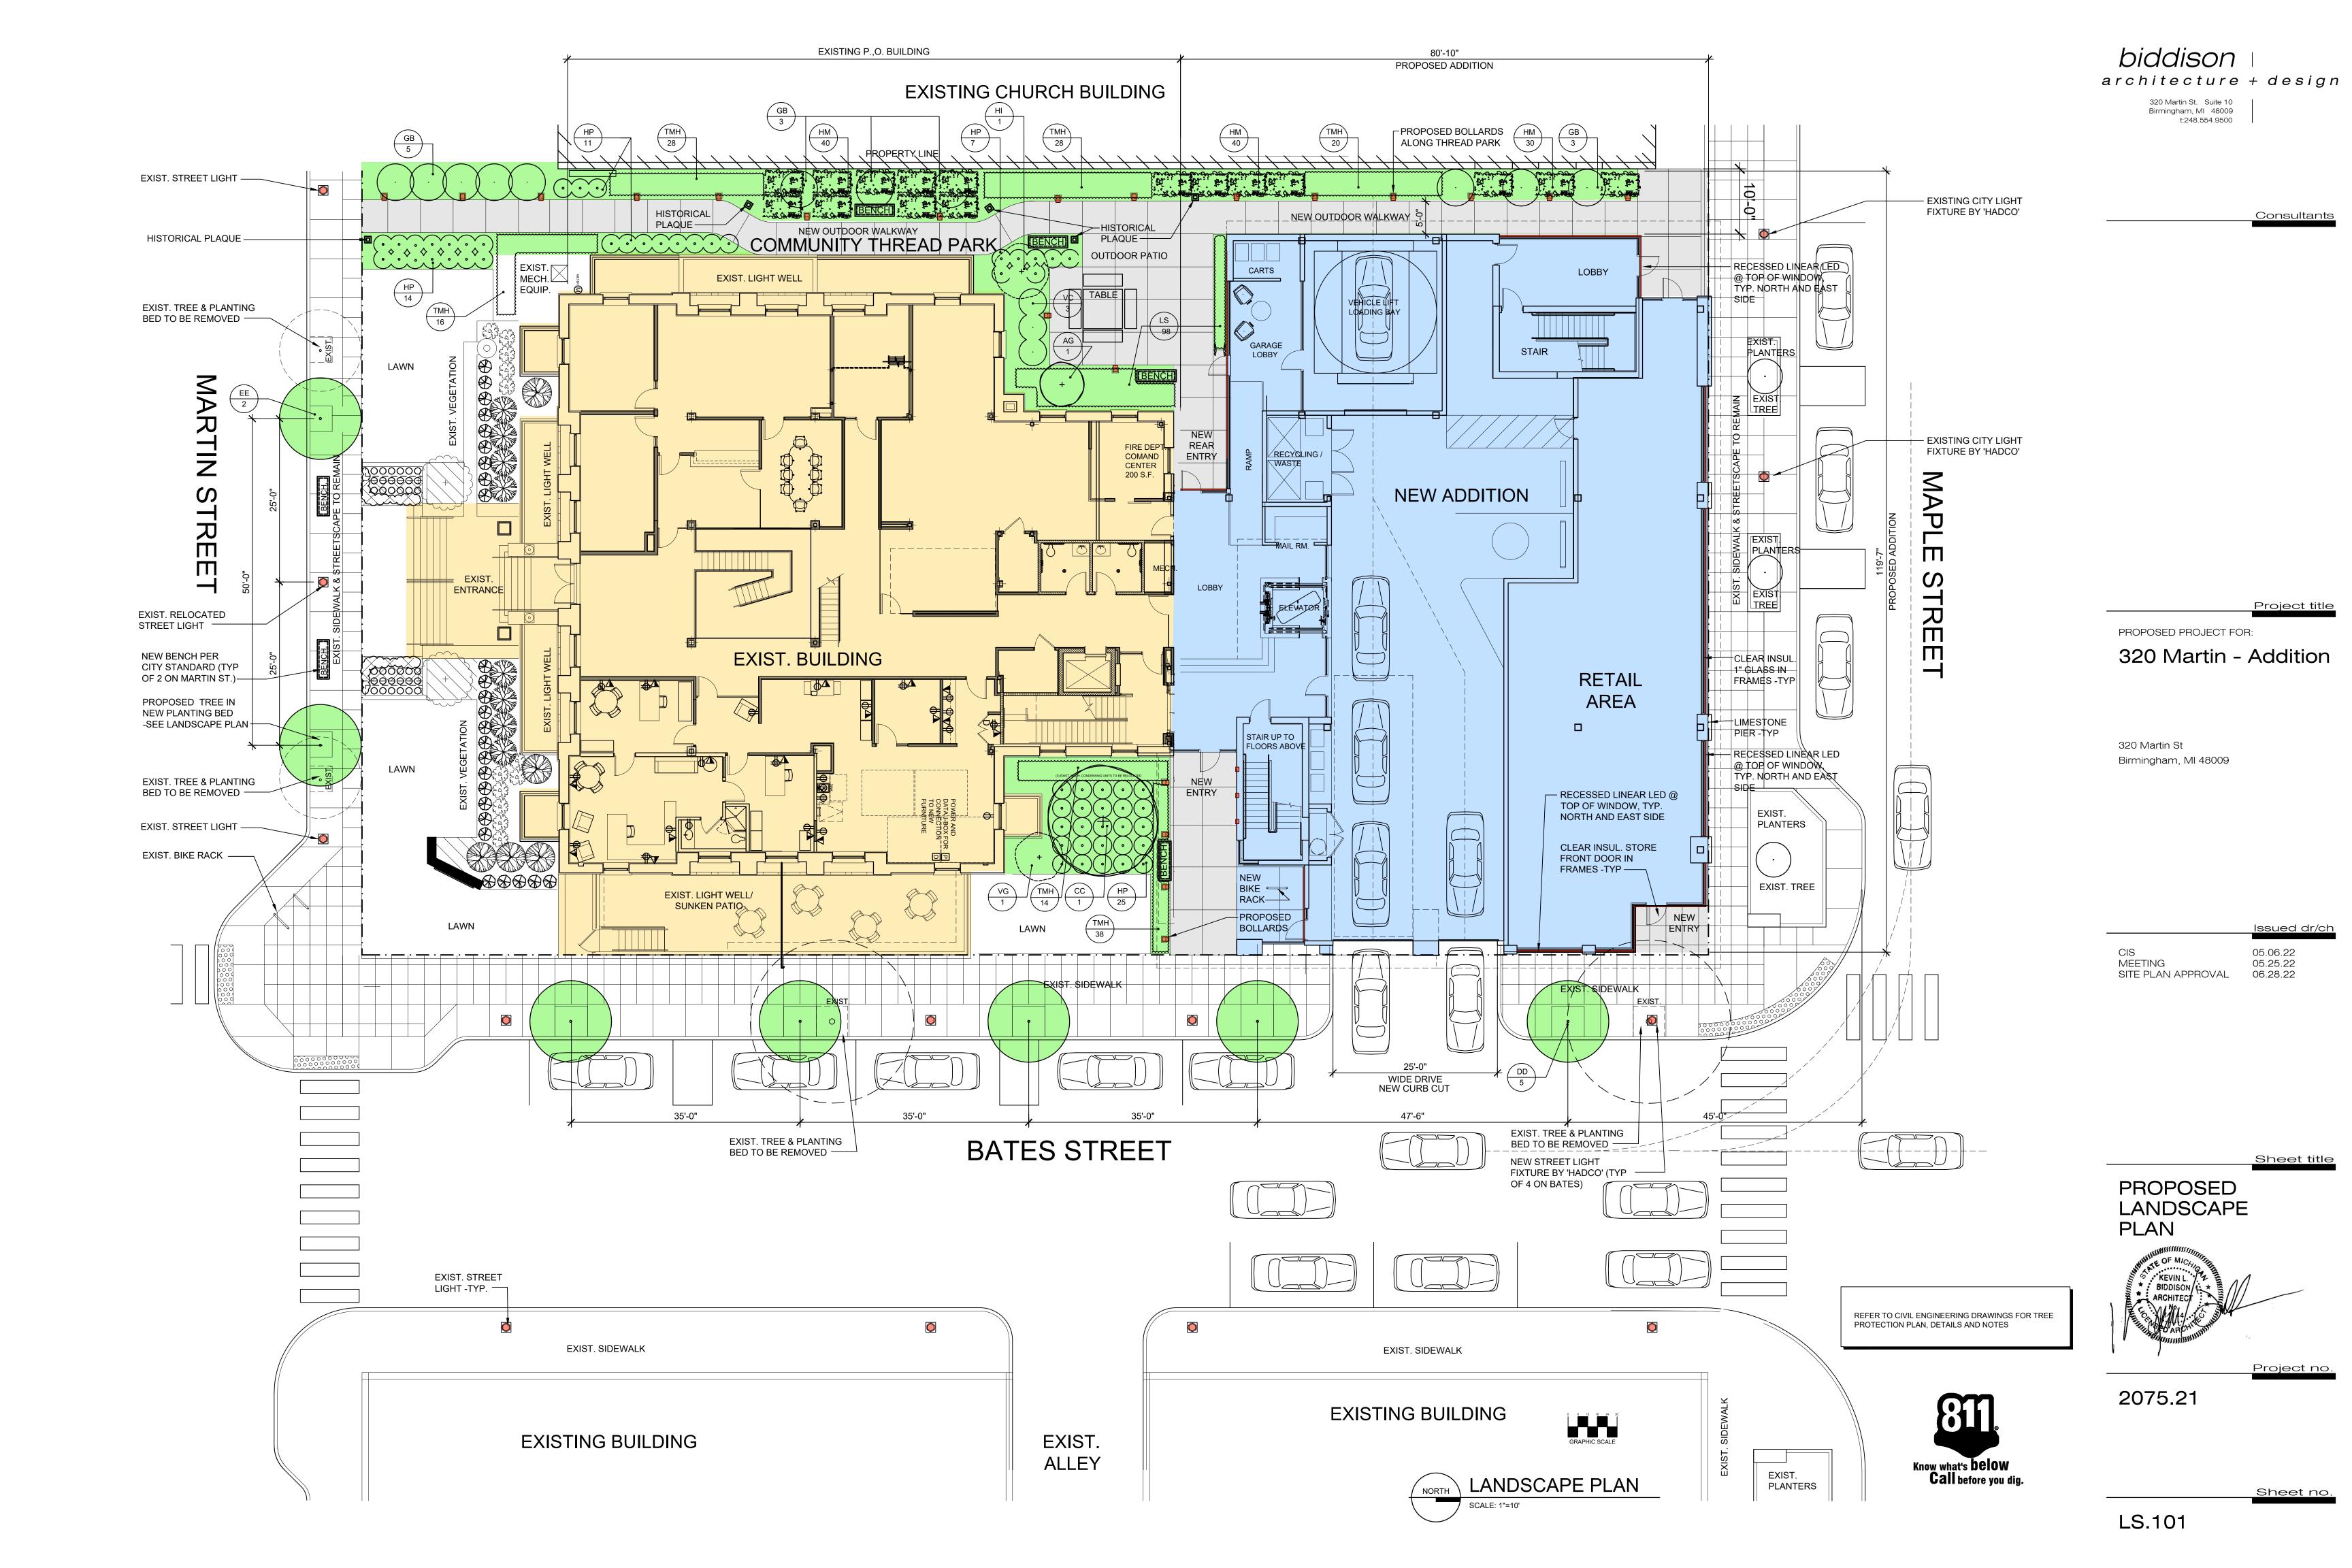


KEY	QUANT.	BOTANICAL NAME	COMMON NAME	ROOT	SIZE	REMARKS
HP	57	Hydrangea Paniculata	FIRELIGHT TIDBID HYDRANGEA	2 GAL.	36" O.C.	
ТМН	60	Taxus x Media 'Hicksii'	HICKSII YEW HEDGE	B&B	18" O.C. HEDGE	
VC	4	Viburnum Carlesii	KOREAN SPICE VIBURNUM	B&B	24" HT.	
НМ	X	Hakonechloa Macra	JAPANESE FOREST GRASS	1 GAL.	30" O.C.	
LS	136	Liriope Muscari "Big Blue"	CREEPING LILLYTURF GROUND COVER	1 GAL.	15" O.C.	


LANDSCAPE TREE SCHEDULE						
KEY	QUANT.	BOTANICAL NAME	COMMON NAME	ROOT	SIZE	REMARKS
					0.4/01/0.41	
GB	11	Gingko Biloba	GOLDSPIRE GINGKO	B&B	2-1/2" CAL.	
AG	1	Amelanchier x Grandiflora	AUTUMN BRILLIANCE SERVICEBERRY	B&B	6-8' HT.	MULTI-STEM
HI	1	Hamamelis x Intermedia	ARNOLD PROMISE WITCH HAZEL	B&B	3-4' HT.	MULTI-STEM
CC	1	Cergis Canadensis	EASTERN REDBUD	B&B	6-8' HT.	
DD	5	Ginkgo Biloba ' Goldspire'	Goldspire Maidenhair Ginko	B&B	3-3.5" CAL.	
EE	2	Celtis Occidentalis	DBH Hackberry	B&B	4-4.5" CAL.	

GENERAL LANDSCAPE NOTES:

- 1. ALL PLANT MATERIALS SHALL CONFORM TO "AMERICAN STANDARDS FOR NURSERY STOCK," LATEST EDITION.
- 2. ALL TREES SHALL BE GUYED AND STAKED.
- 3. ALL PLANT MATERIALS SHALL BE GUARANTEED FOR A PERIOD OF TWO (1) YEAR FROM DATE OF INSTALLATION.
- 4. ALL PLANTING AREAS SHALL HAVE A DEPTH OF 12" TO 18" OF BLENDED EXISTING SOIL MATERIALS AND SHALL BE CROWNED TO A HEIGHT OF 6" ABOVE ADJACENT CURBS, WALKS, AND GRADES WITH 4" TO 6" OF TOP SOIL.
- 5. AREAS OF EXISTING PAVEMENT OR GRAVEL TO BE CONVERTED TO LANDSCAPE AREAS SHALL BE EXCAVATED TO REMOVE ALL PAVEMENT, GRAVEL, AND COMPACTED EARTH. REPLACE EXCAVATED MATERIAL WITH CLEAN FILL TO CROWN 2" MIN. ABOVE ADJOINING GRADE. ADD 4" TO 6" OF TOP SOIL.
- 6. ALL PLANTING BEDS SHALL RECEIVE A MIN. OF 3"-4" SHREDDED BARK MULCH. (KEEP MULCH AWAY FROM VERTICAL STEMS OF TREES AND SHRUBS)
- 7. ALL PLANTING BEDS NOT BORDERED BY WALKS, WALLS, OR PAVING SHALL BE SPADE CUT
- 8. TOP SOIL SHALL BE STRIPPED AND STOCK PILED ON SITE FOR USE IN LANDSCAPE AREAS WITH EXCESS TOP SOIL TO BE REMOVED FROM THE SITE.
- 9. THE WORK SHALL CONSIST OF PROVIDING ALL NECESSARY MATERIALS, LABOR, EQUIPMENT, TOOLS, AND SUPERVISION REQUIRED FOR THE COMPLETION AS SHOWN
- 10. THE PLANT MATERIALS SHALL BE NURSERY GROWN AND INSPECTED BY THE OWNERS REPRESENTATIVE BEFORE PLANTING. THE OWNERS REP. RESERVES THE RIGHT TO REJECT ANY PLANT MATERIAL AT ANY TIME.
- 11. PLANTS DESIGNATED "B&B" SHALL BE BALLED AND BURLAPPED, WITH FIRM BALLS
- 12. THE CONTRACTOR IS RESPONSIBLE FOR PLANTING THE MATERIALS AT THE CORRECT GRADES AND SPACING. THE PLANTS SHALL BE ORIENTED TO GIVE THE BEST APPEARANCE.
- 13. WHEN THE PLANT HAS BEEN PROPERLY SET, THE PIT SHALL BE BACK FILLED WITH A BLENDED MIXTURE OF EXISTING SITE MATERIAL TOPSOIL MIXTURE, GRADUALLY FILLING, PATTING AND SETTLING WITH WATER.
- 14. TOPSOIL SHALL BE FRIABLE, FERTILE TOPSOIL OF CLAY LOAM CHARACTER CONTAIN. AT LEAST 5% BUT NOT MORE THAN 20% BY WEIGHT OF ORGANIC MATTER. SOIL SHALL BE FREE FROM CLAY LUMPS, COARSE SAND, PLANT ROOTS, STICKS, AND OTHER FOREIGN MATERIALS.

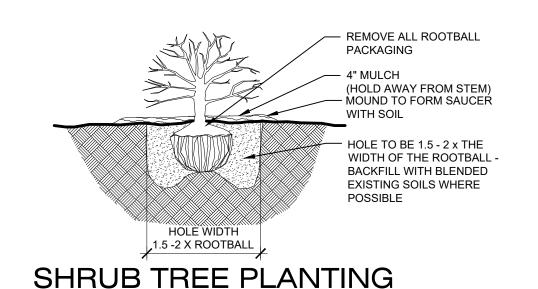

SHRUB SHALL BEAR SAME RELATIONSHIP TO FINISH GRADE AS BEFORE TRANSPLANTING (@ STEM ROOT FLARE SHOULD BE AT GRADE OR SLIGHTLY HIGHTER)

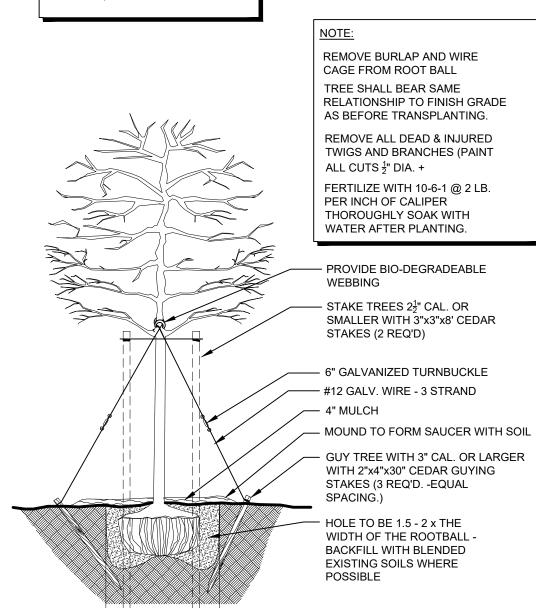

DECIDUOUS TREE PLANTING

1.5 -2 X ROOTBALL

biddison

architecture + design

t:248.554.9500

320 Martin St. Suite 10 Birmingham, MI 48009

Consultants

PROPOSED PROJECT FOR:

320 Martin - Addition

320 Martin Street Birmingham, Mi

Issued dr/ch

CIS SITE PLAN APPROVAL

05.06.22 06.28.22

Sheet title

LANDSCAPE SCHEDULE





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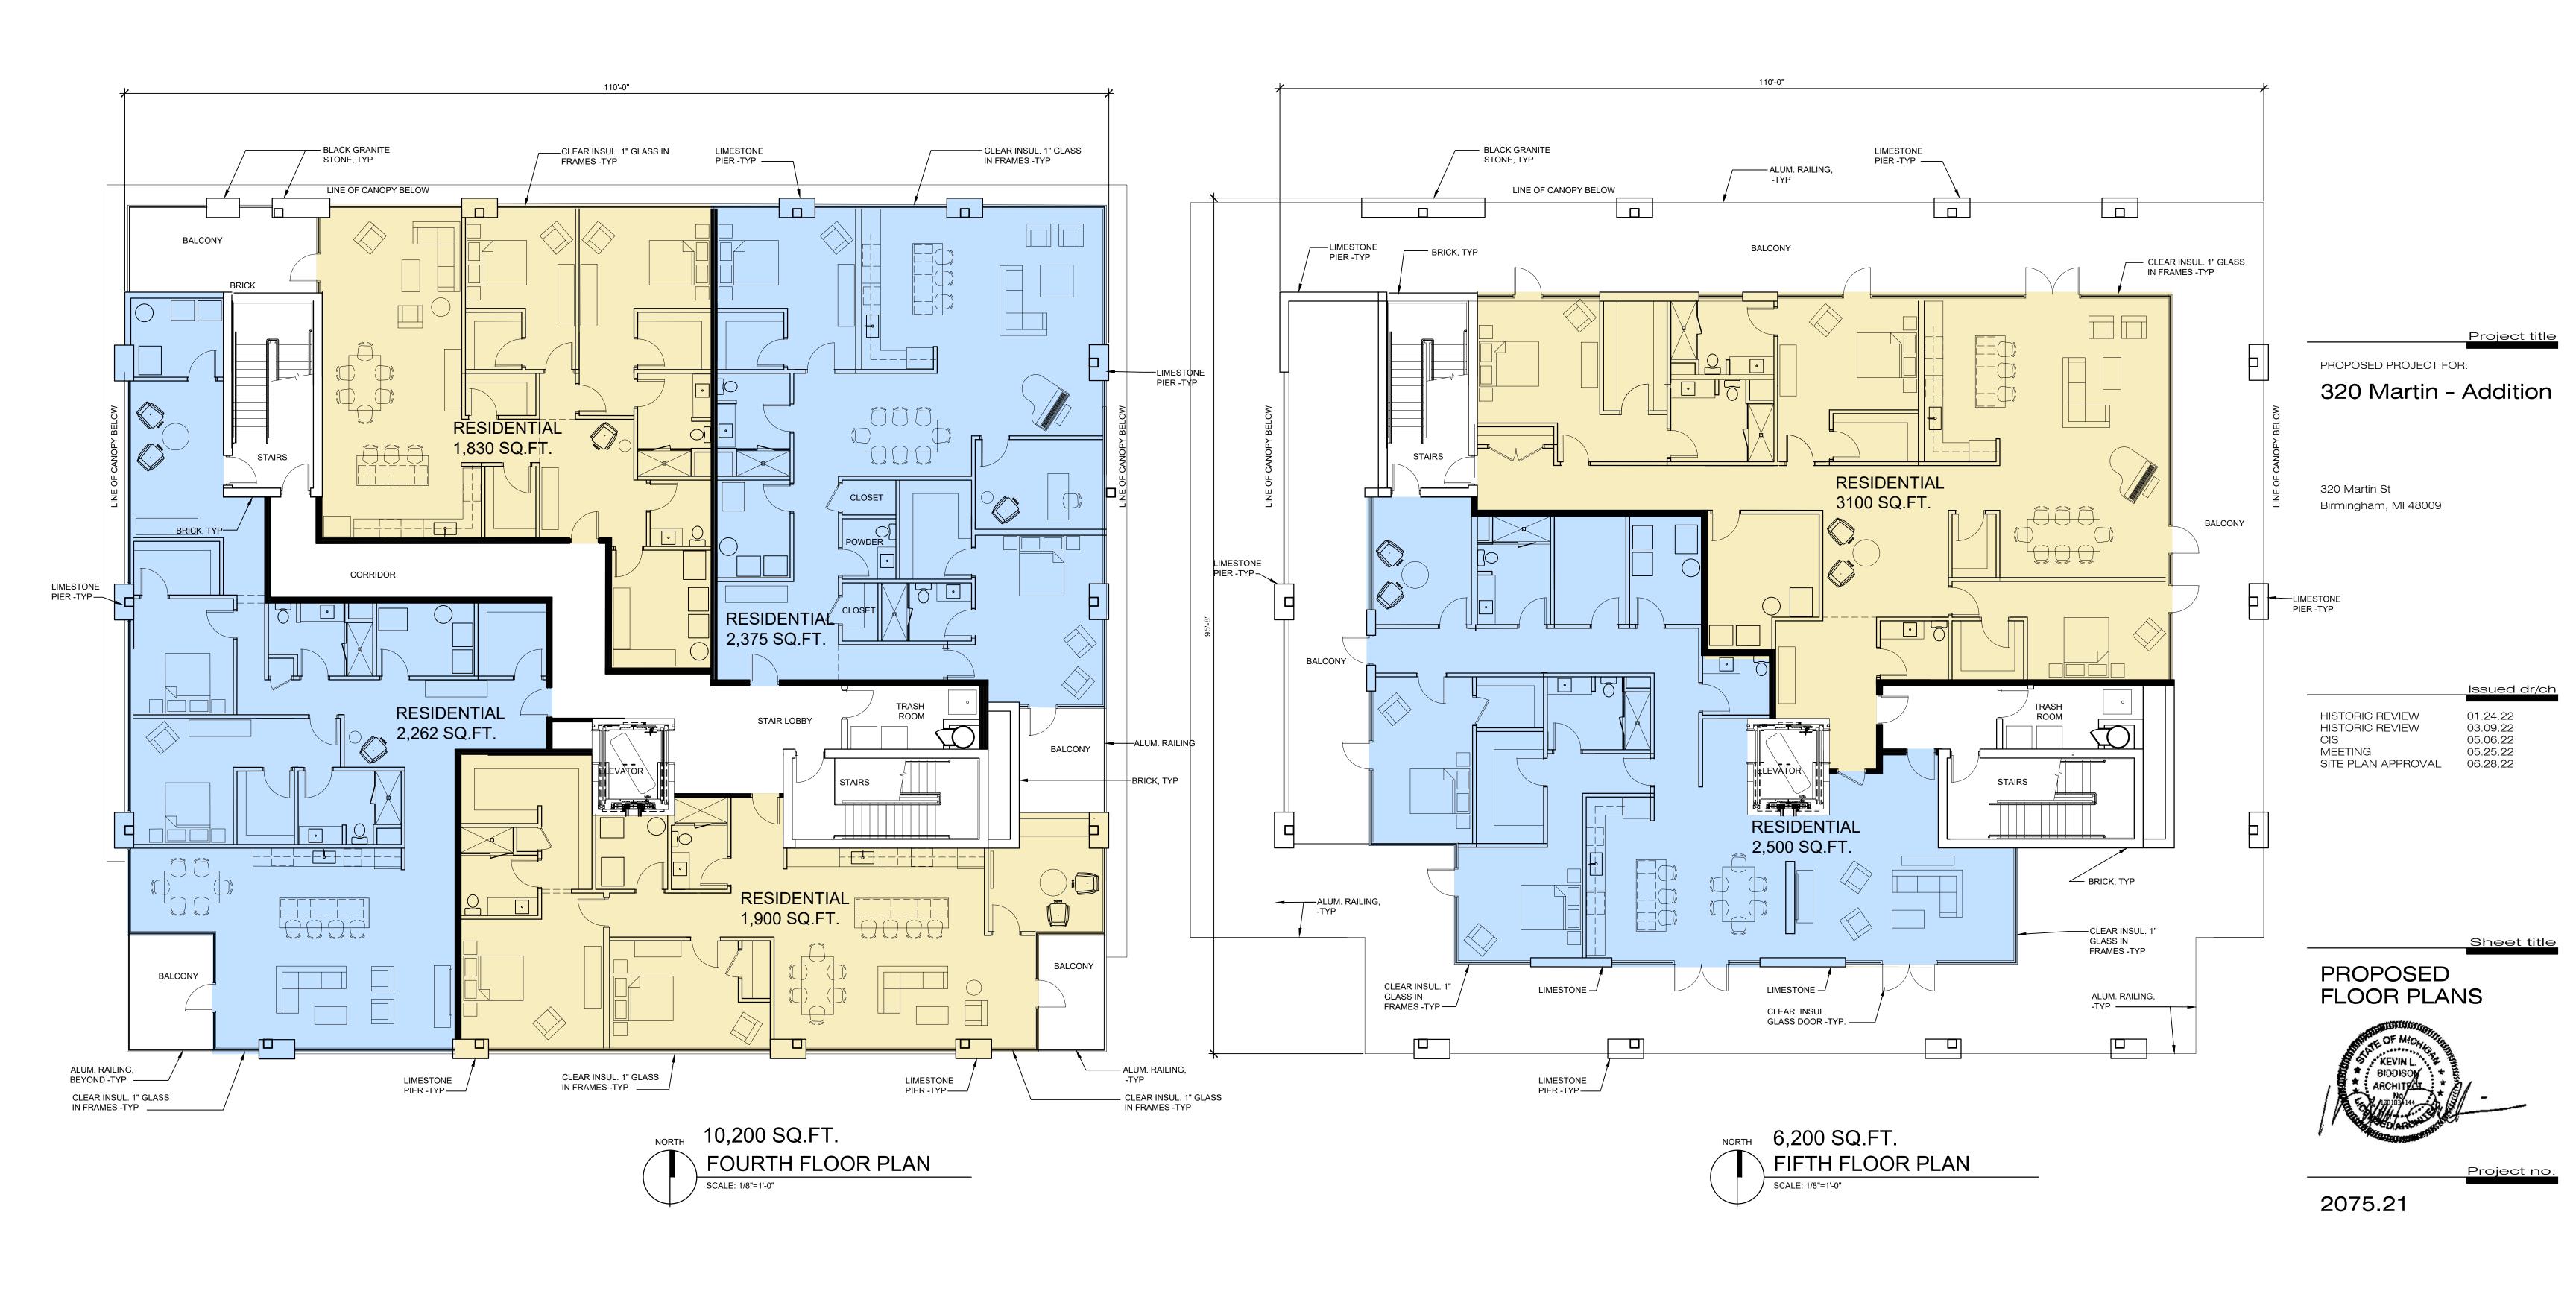
2083-21

Sheet no.

LS.601



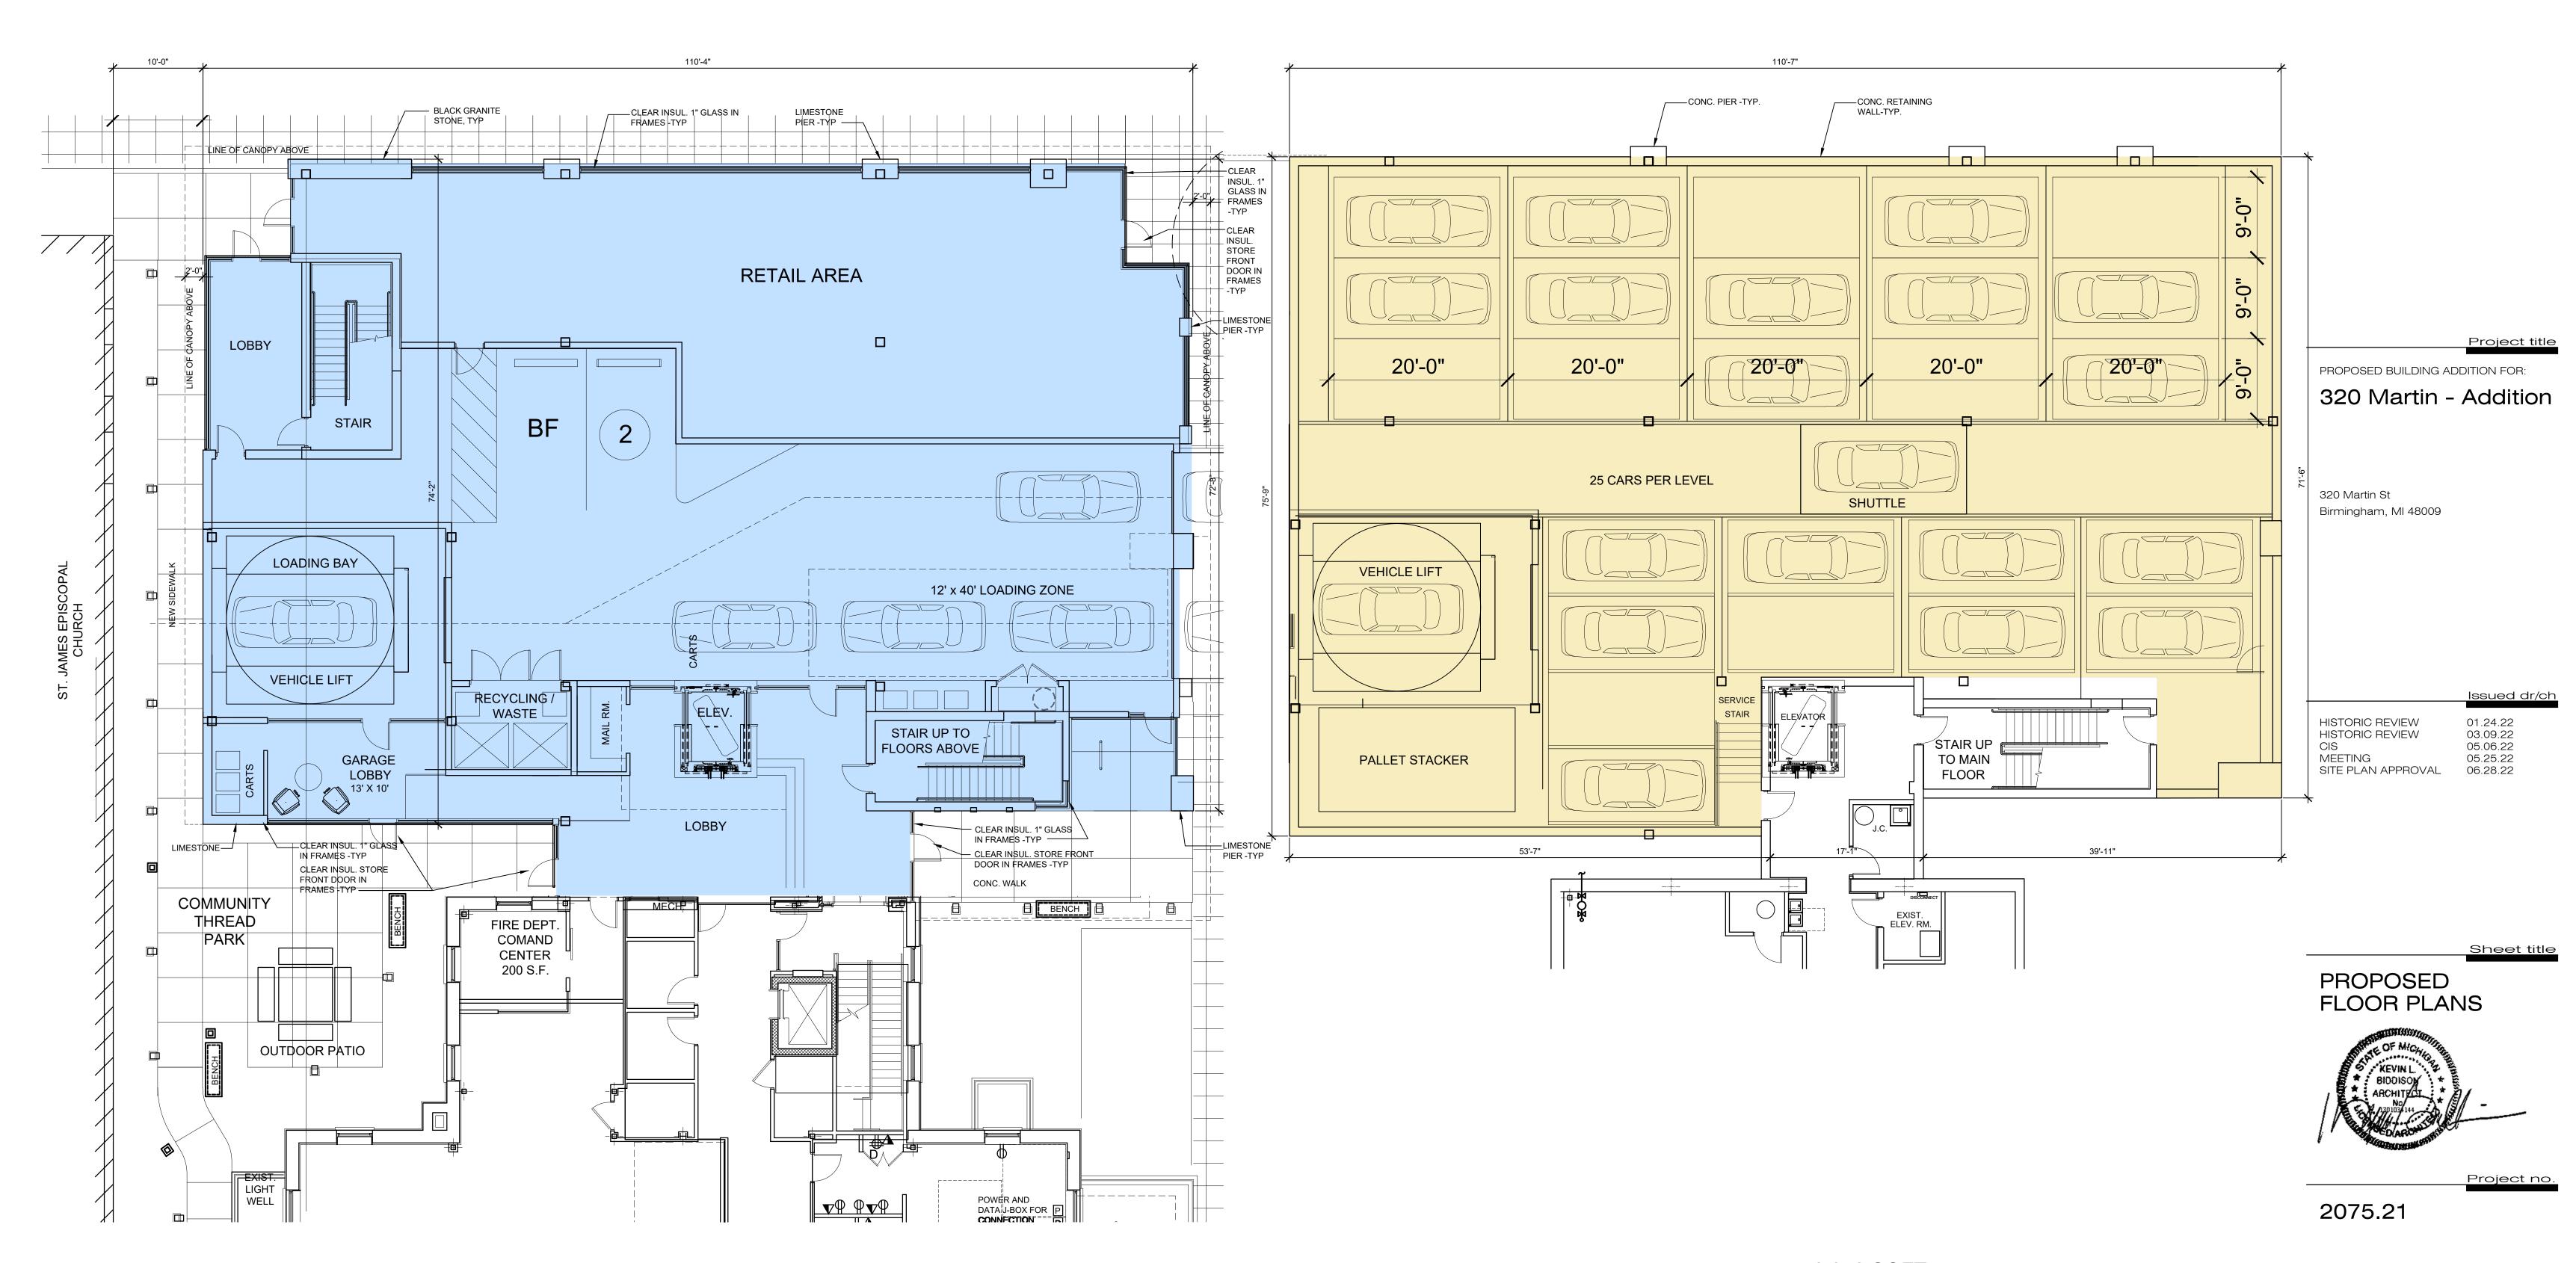

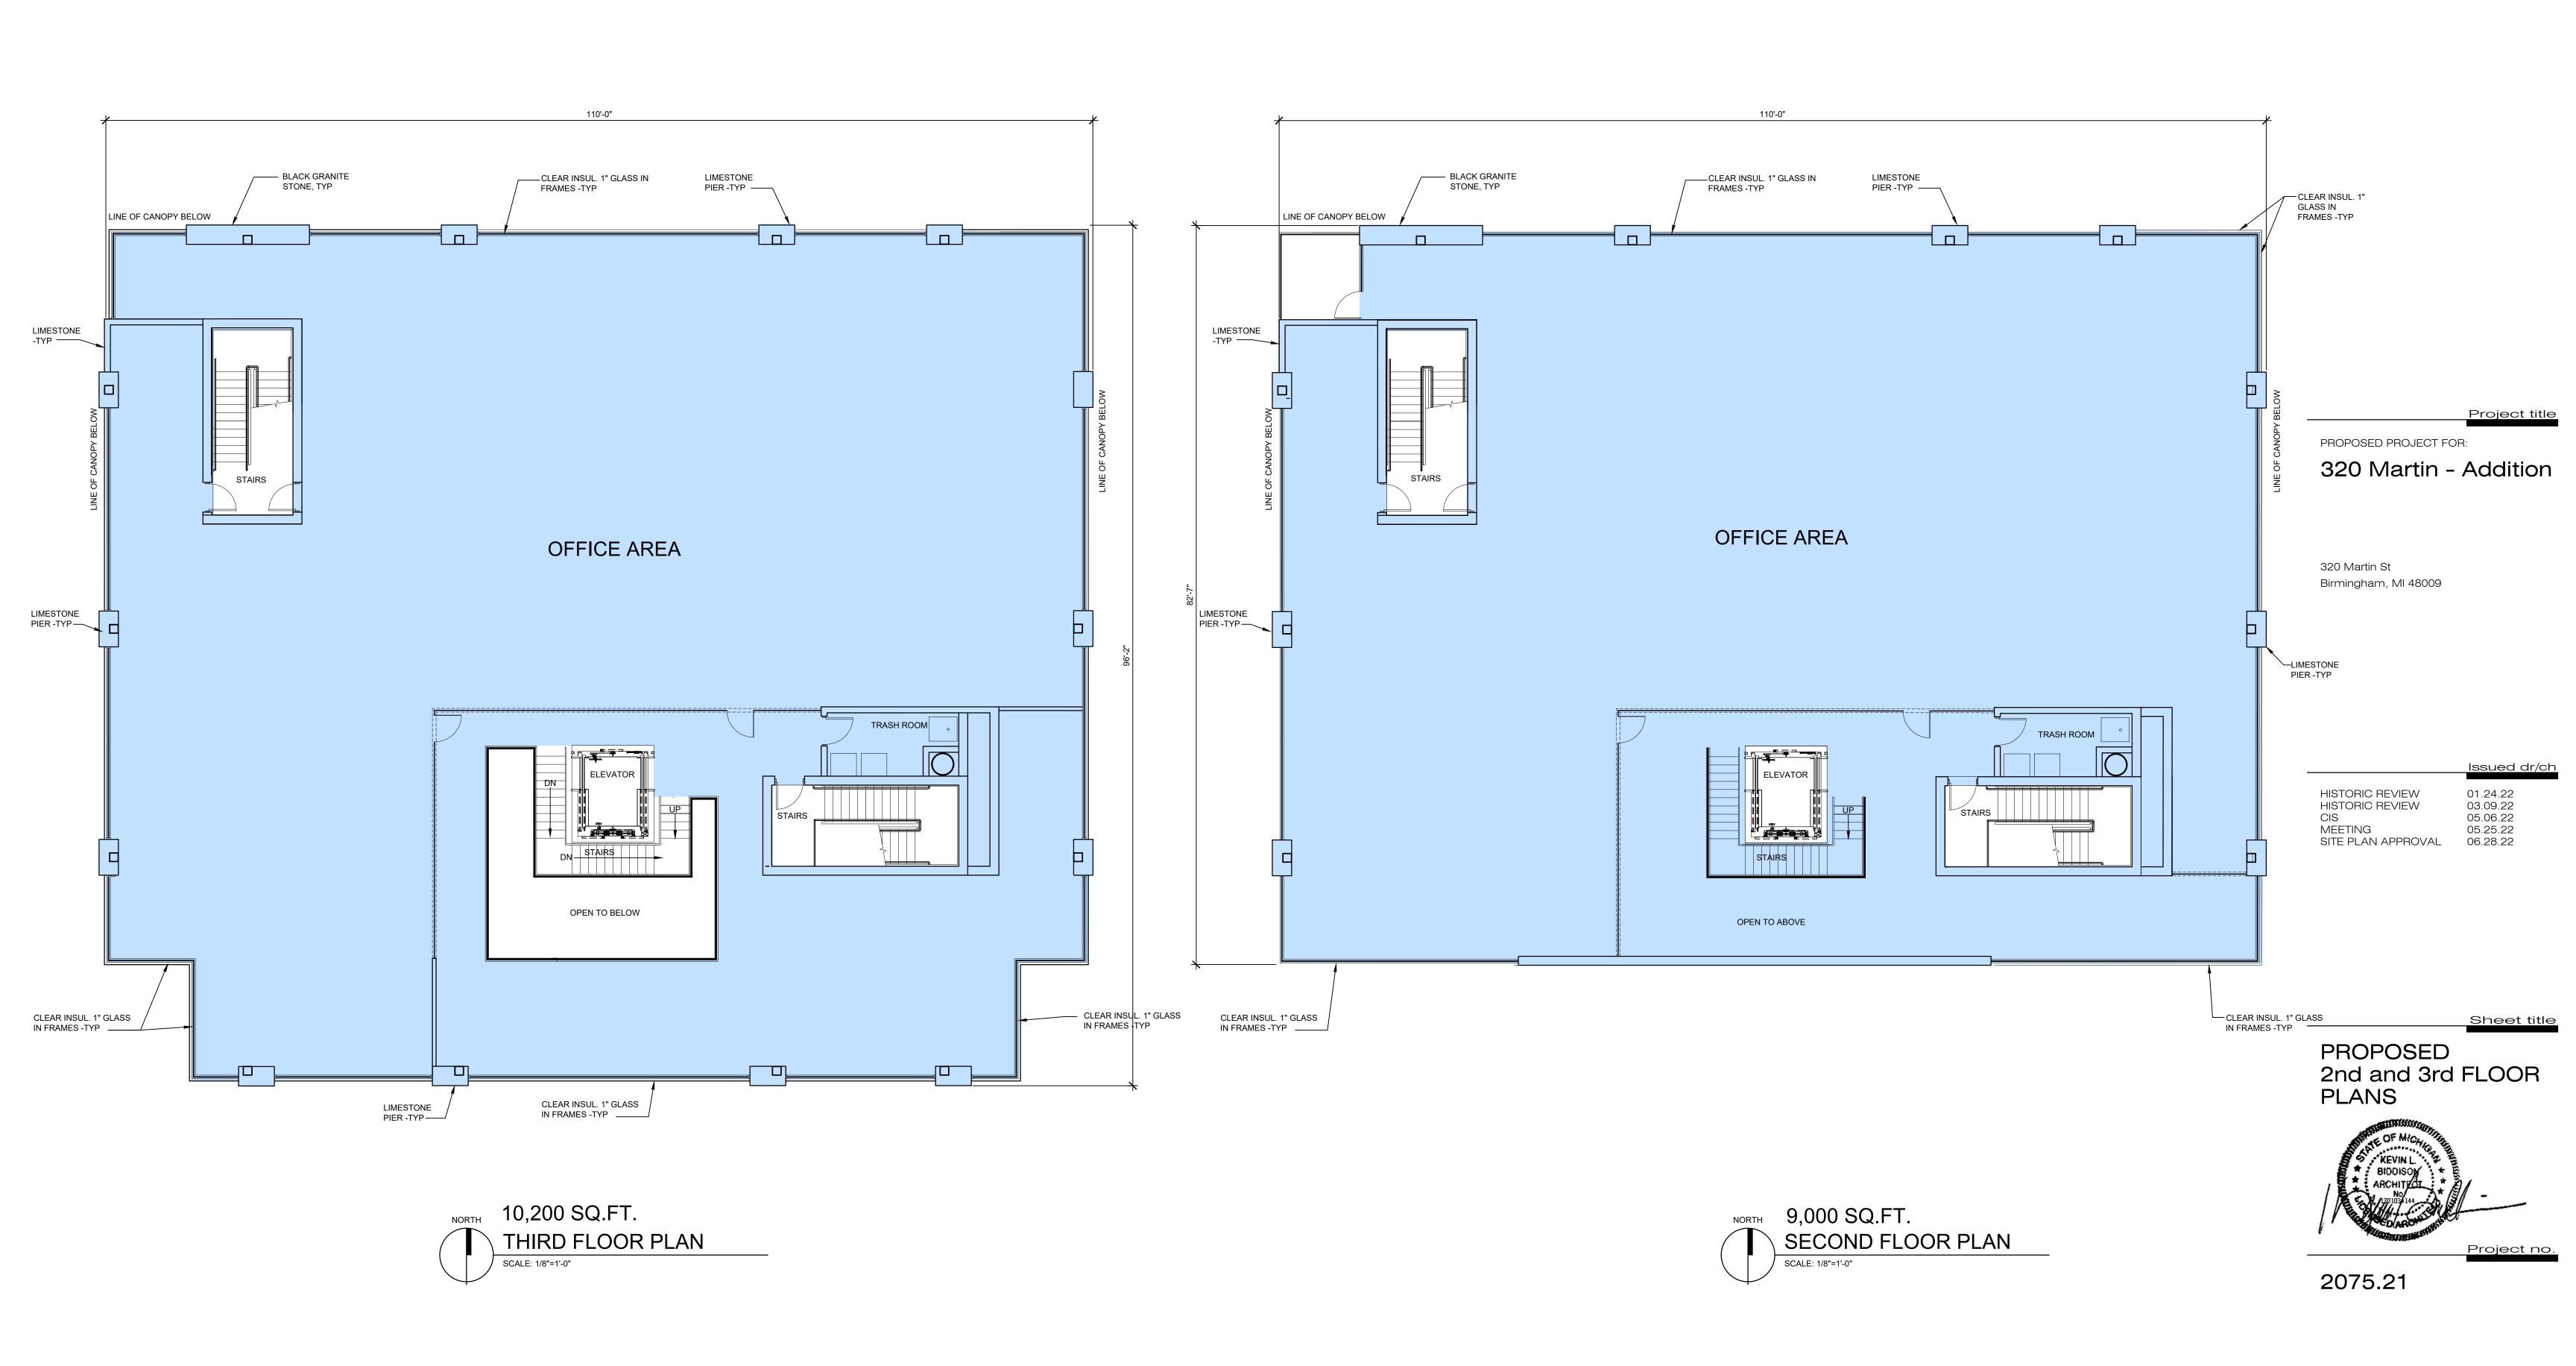





Project title

PROPOSED PROJECT FOR:

320 Martin - Addition

320 Martin St Birmingham, MI 48009


Issued dr

 CIS
 05.06.22

 SITE PLAN APPROVAL
 06.28.22


Sheet title

PROPOSED ROOF PLAN

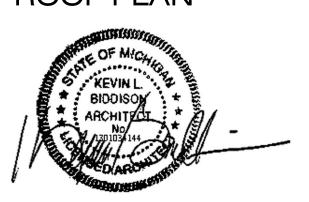

Project no

2075.21

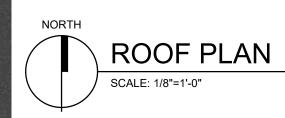





architecture + design 320 Martin St. Suite 10 Birmingham, MI 48009


t:248.554.9500

Consultants

Project title

PROPOSED BUILDING ADDITION FOR: 320 Martin - Addition

320 Martin St Birmingham, MI 48009

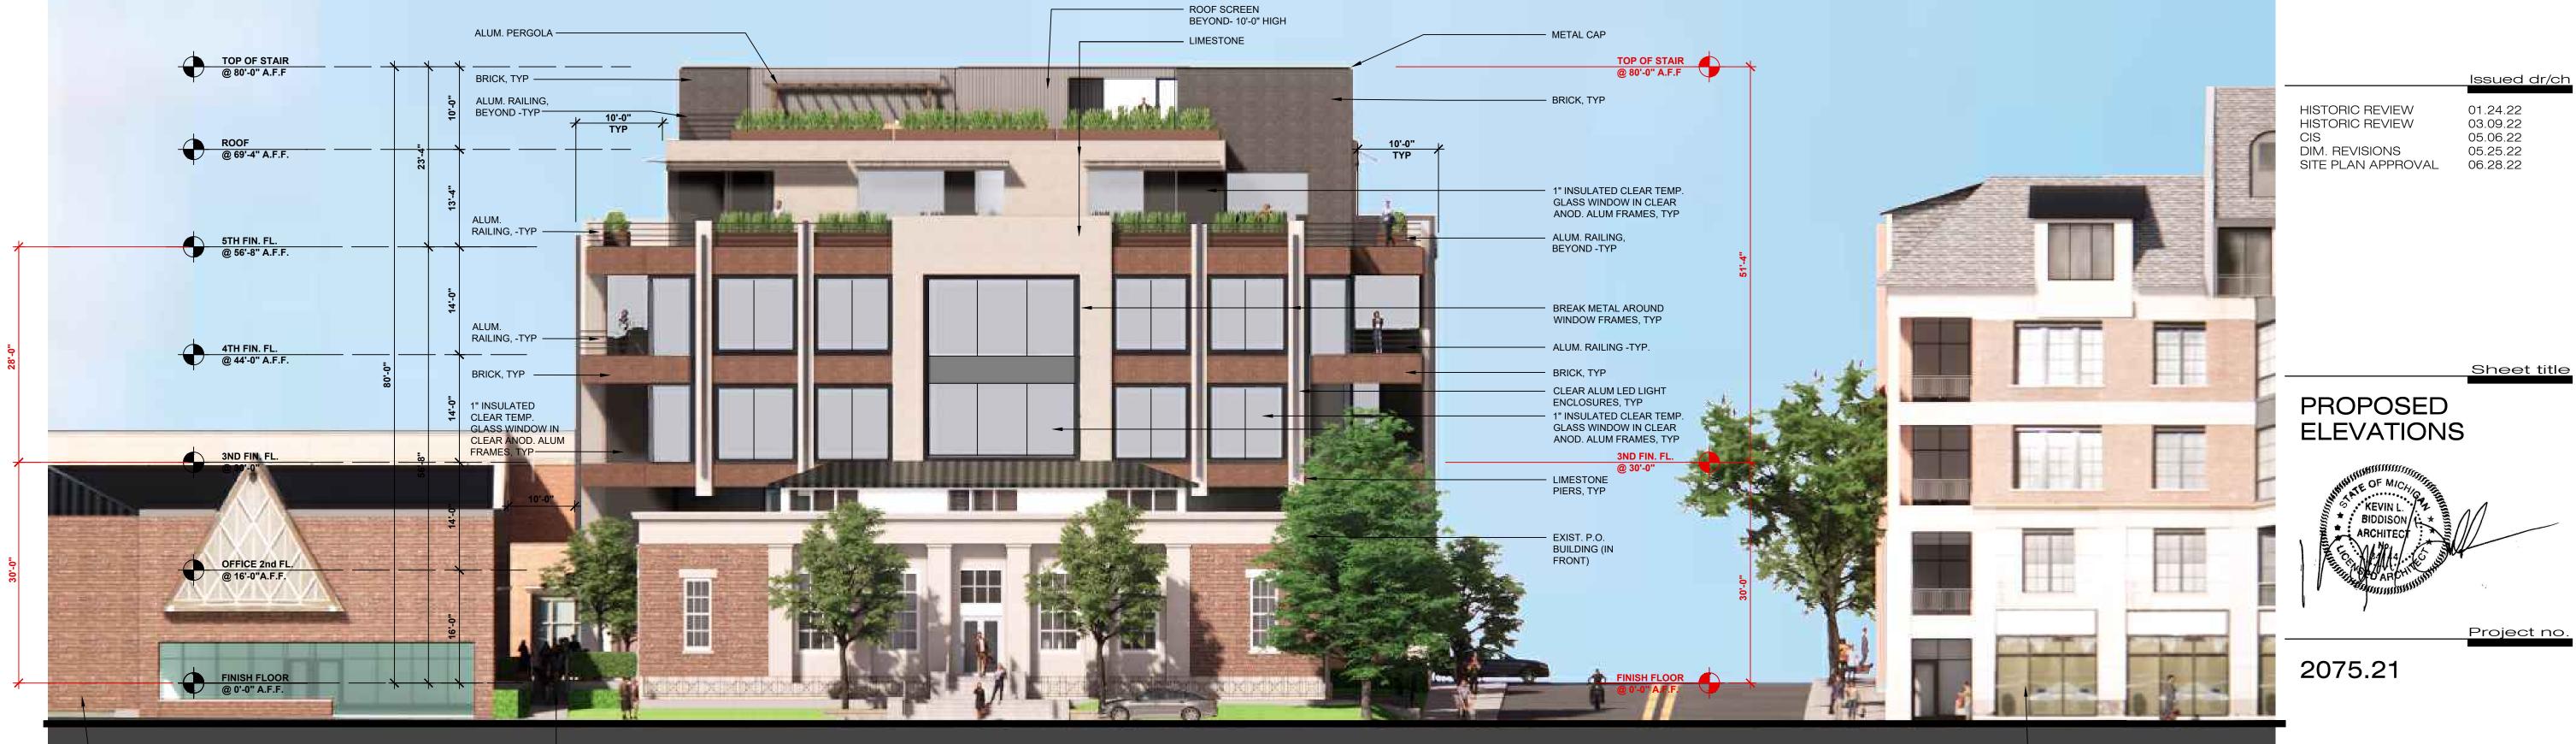

CLEAR TEMP. GLASS DOOR IN CLEAR ANOD. ALUM FRAMES, TYP ----

201.01 SOUTH ELEVATION

SCALE: 3/32"=1'-0"

A.201

MATERIAL AREA (SQ. FT.) ELEVATION SOLID GLASS SOUTH (2ND FLOOR TO ROOF) 4,852 1,938 % OF TOTAL 71.5% 28.5% REQUIRED % 65% MIN 35% MAX MATERIAL AREA (SQ. FT.) ELEVATION SOLID **GLASS** SOUTH (1'-0" TO 8'-0")

72.5%

30% MAX

27.5%

EXIST. ST. JAMES

EPISCOPAL CHURCH -BEYOND

COMMUNITY

THREAD PARK —

70% MIN

% OF TOTAL

REQUIRED %

ELEVATION

% OF TOTAL

REQUIRED %

ELEVATION

(1'-0" TO 8'-0"

% OF TOTAL

REQUIRED %

NORTH

FLOOR TO ROOF)

SOLID

SOLID

39.9%

30% MAX

65.3%

Sheet no.

— 242 MARTIN STREET BUILDING -BEYOND



METAL CAP ———

SOLID

SOLID

324 S.F.

47.7%

MATERIAL AREA (SQ. FT.)

65% MIN 35% MAX

SOLID

SOLID

3,600

65.2%

MATERIAL AREA (SQ. FT.)

217

33%

30% MAX

GLASS

GLASS

70% MIN

1,920

34.8%

ELEVATION

% OF TOTAL

REQUIRED %

ELEVATION

(1'-0" TO 8'-0")

% OF TOTAL

REQUIRED %

EAST (2ND FLOOR TO ROOF)

30% MAX

ELEVATION WEST (2ND

FLOOR TO ROOF % OF TOTAL

REQUIRED %

ELEVATION

(1'-0" TO 8'-0")

% OF TOTAL


REQUIRED %



CLEAR TEMP. GLASS DOOR IN CLEAR ANOD. ALUM FRAMES, TYP

EXIST. ADJACENT OFFICE
BUILDING (OLD POST OFFICE) —

LIMESTONE PIERS, TYP

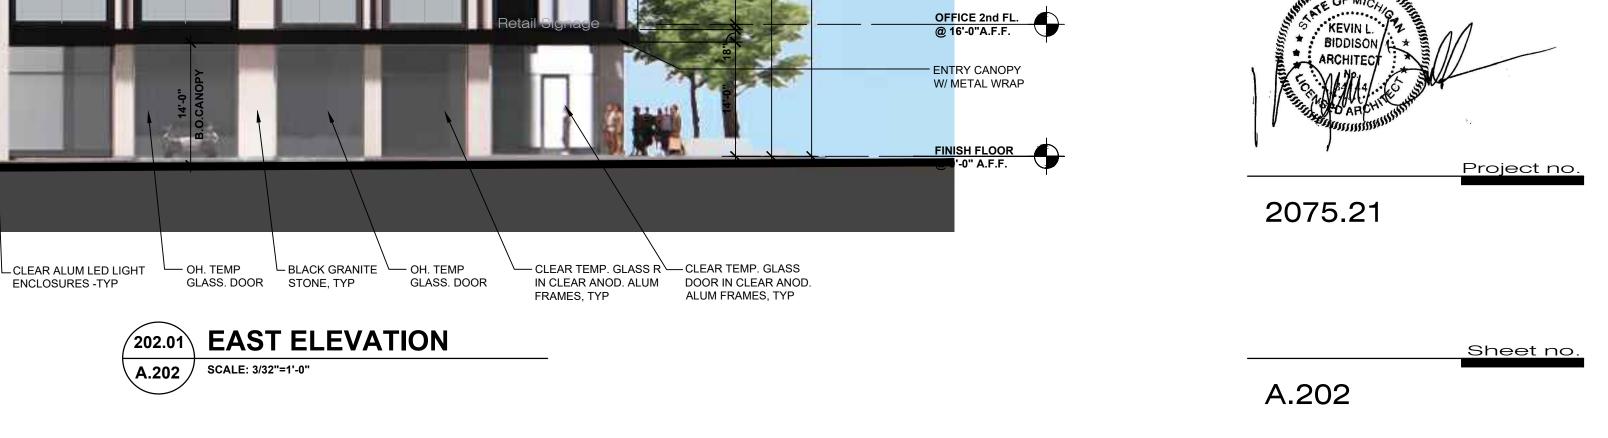

Consultants

Project title

Issued dr/ch

Sheet title

01.24.22 03.09.22

05.06.22

05.25.22

06.28.22

HISTORIC REVIEW HISTORIC REVIEW

DIM. REVISIONS SITE PLAN APPROVAL

PROPOSED ELEVATIONS





Project title


PROPOSED PROJECT FOR:

320 Martin - Addition

320 Martin St Birmingham, MI 48009

HISTORIC REVIEW 01.24.22
HISTORIC REVIEW 03.09.22
CIS 05.06.22
SITE PLAN APPROVAL 06.28.22

PROPOSED 3D IMAGES

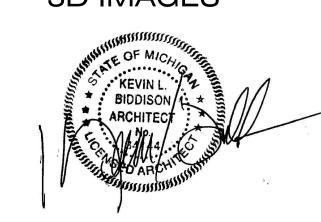





320 Martin St Birmingham, MI 48009

HISTORIC REVIEW 01.24.22
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PROPOSED 3D IMAGES

Sheet no.







PROPOSED PROJECT FOR:

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320 Martin St Birmingham, MI 48009

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Sheet title PROPOSED 3D IMAGES

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2075.21

SE CORNER BATES & MARTIN

NO SCALE



Project tit


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320 Martin - Addition

320 Martin St Birmingham, MI 48009

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PROPOSED 3D IMAGES



2075.21

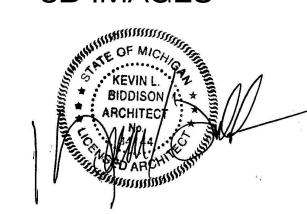




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PROPOSED 3D IMAGES






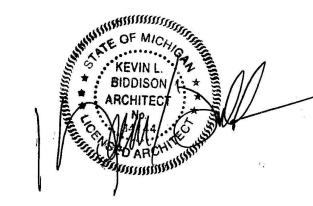

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Sheet title





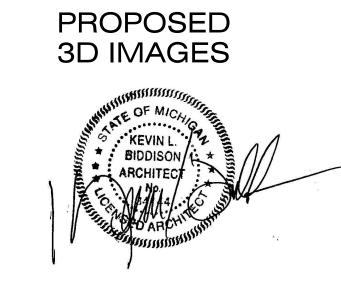

Project ti

PROPOSED PROJECT FOR:

320 Martin - Addition

320 Martin St Birmingham, MI 48009


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PROPOSED 3D IMAGES





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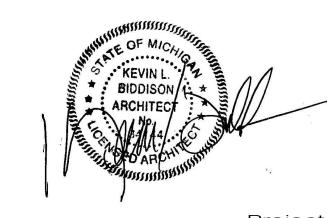


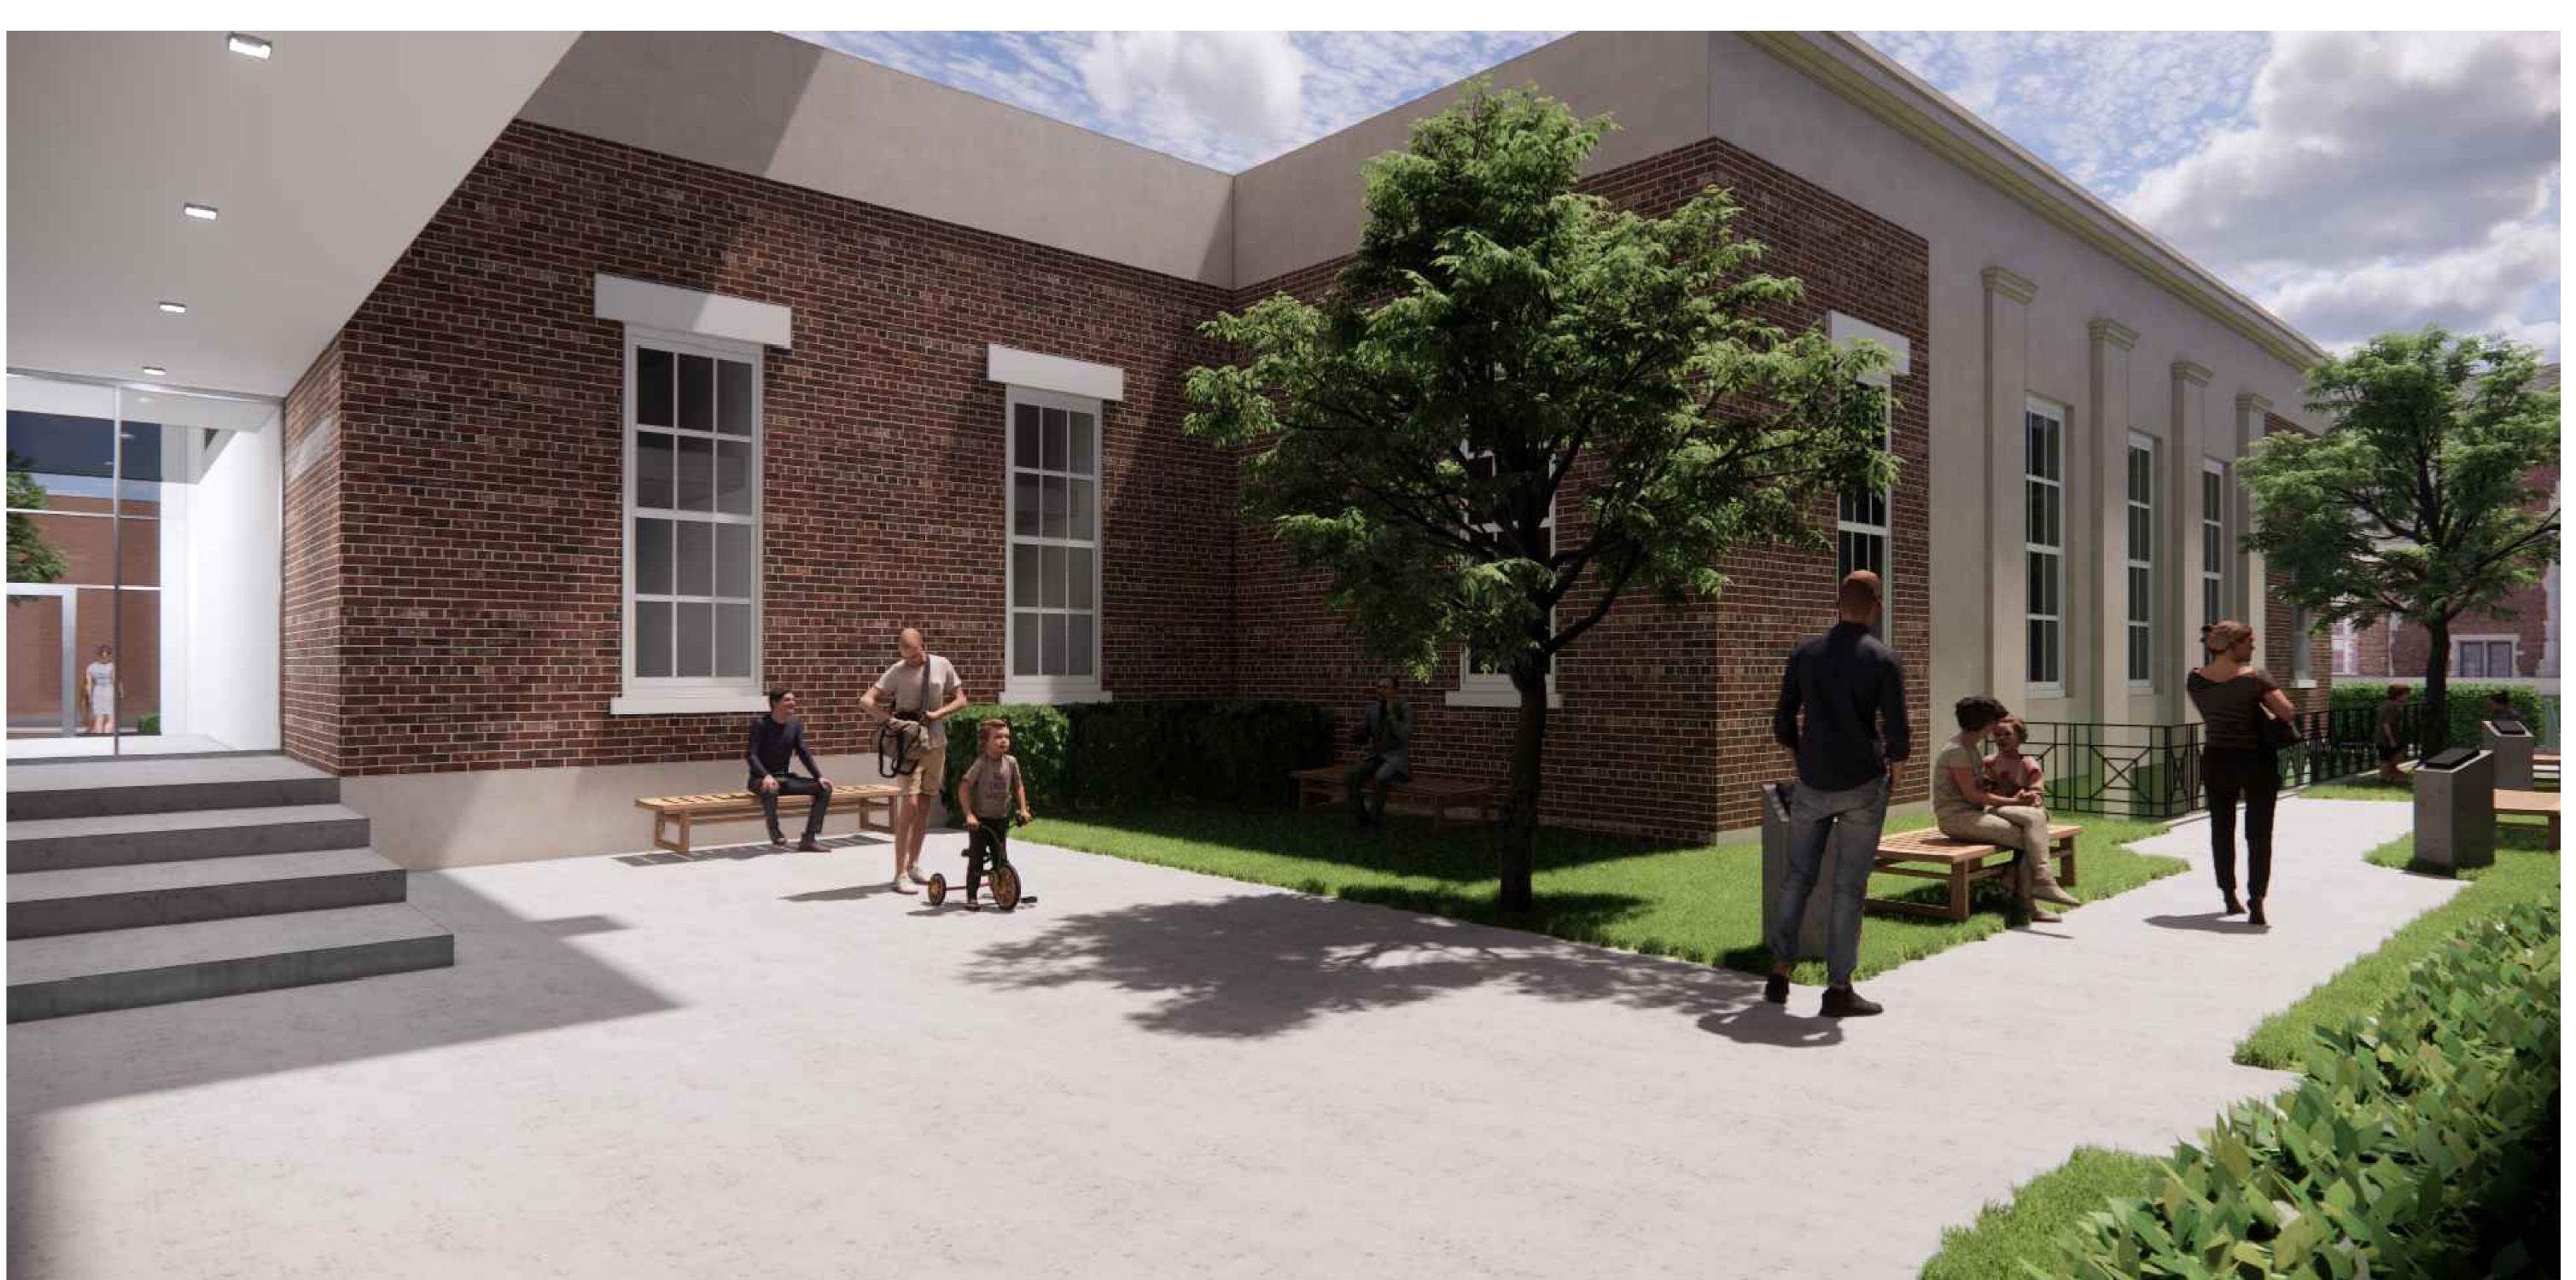

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2075.21

COMMUNITY THREAD PARK - MARTIN STREET

NO SCALE





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320 Martin - Addition

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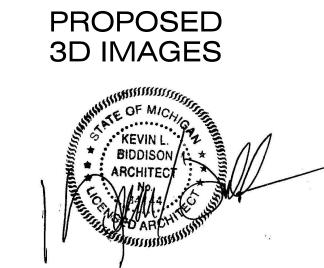




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PROPOSED PROJECT FOR: 320 Martin - Addition


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PROPOSED 3D IMAGES



2075.21

ROOFTOP VIEW

NO SCALE

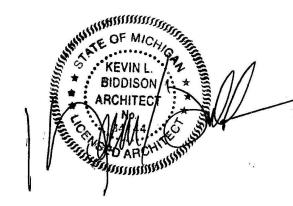



PROPOSED PROJECT FOR: 320 Martin - Addition

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HISTORIC REVIEW HISTORIC REVIEW CIS SITE PLAN APPROVAL 01.24.22 03.09.22 05.06.22 06.28.22

PROPOSED 3D IMAGES





biddison architecture + design 320 Martin St. Suite 10 Birmingham, MI 48009 t:248.554.9500

Consultants

PROPOSED PROJECT FOR: 320 Martin - Addition

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PROPOSED 3D IMAGES



2075.21

SHAIN PARK VIEW

NO SCALE

PREVIOUSLY APPROVED DESIGN REVIEW PLANS (3/16/22)

BIRMINGHAM POST OFFICE ADDITION

CONDITIONS OF WORK

CONSTRUCTION COORDINATION:

1. ALL CONTRACTORS SHALL REVIEW ALL DRAWINGS & ARE RESPONSIBLE FOR A COMPLETE REVIEW & SITE VISIT. ITEMS AFFECTING ALL TRADES ARE PLACED THROUGHOUT SET & NO "EXTRAS" FOR MISSED ITEMS IN OTHER SECTIONS WILL BE PERMITTED. THE CONTRACTOR SHALL IMMEDIATELY NOTIFY ARCHITECT OF ANY AMBIGUITY, INCONSISTENCY OR ERRORS WHICH THEY DISCOVER UPON EXAMINATION OF DOCUMENTS, THE SITE OR LOCAL

2. ANY CONTRACTOR OR SUBCONTRACTOR BY SUBMITTING A BID WARRANT'S THAT HE HAS VISITED THE SITE AND IS AWARE OF ANY AND ALL SITE CONDITIONS AFFECTING HIS BID.

3. THE CONTRACTOR BY COMMENCING WORK ACCEPTS THE CONDITIONS OF THE SITE & THE COMPLETENESS OF CONTRACT DOCUMENTS.

4. FIELD VERIFY ALL DIMENSIONS AND REPORT ANY DISCREPANCIES IMMEDIATELY TO THE ARCHITECT. DO NOT SCALE DRAWINGS USE FIGURED DIMENSIONS ONLY.

5. ANY MATERIAL OR LABOR NEITHER SHOWN ON THE DRAWINGS NOR SPECIFIED, BUT WHICH IS OBVIOUSLY NECESSARY TO COMPLETE THE WORK IN A WORKMANLIKE MANNER SHALL BE FURNISHED WITHOUT COST TO THE OWNER.

6. ALL MATERIALS FURNISHED AND INSTALLED BY THE GENERAL CONTRACTOR SHALL BE FREE FROM DEFECTS. ALL WORK SHALL BE GUARANTEED FOR A PERIOD OF (1) YEAR FROM DATE OF ACCEPTANCE OF WORK. DURING THIS PERIOD THE GENERAL CONTRACTOR SHALL CORRECT ANY PROBLEMS DUE TO DEFECTIVE MATERIALS OR FAULTY WORKMANSHIP AT NO COST TO THE OWNER. ANY PROBLEM THAT OCCURS DURING CONSTRUCTION SHALL IMMEDIATELY BE CORRECTED TO THE SATISFACTION OF THE OWNER.

7. NO SUBSTITUTIONS OF SPECIFIED MATERIAL OR EQUIPMENT WILL BE ACCEPTED UNLESS WRITTEN REQUEST FOR APPROVAL HAS BEEN RECEIVED BY THE ARCHITECT AND CONTRACTOR HAS RECEIVED WRITTEN APPROVAL FROM ARCHITECT.

8. DURING AND AT THE COMPLETION OF THE CONTRACTOR'S DAILY WORK, CONTRACTOR IS RESPONSIBLE FOR THE CLEANING UP AND REMOVAL OF ALL RUBBISH AND DEBRIS BEFORE LEAVING THE PROJECT JOB SITE.

PERMITS & SAFETY:

1. GENERAL CONTRACTOR SHALL APPLY & SUBMIT FOR BUILDING PERMIT

2. GENERAL CONTRACTOR SHALL OBTAIN "ALL RISK" INSURANCE AND ALL CUSTOMARY STATUTORY INSURANCE FOR COMPREHENSIVE GENERAL LIABILITY, ETC. AS REQUIRED BY

3. GENERAL CONTRACTOR SHALL PROVIDE ADEQUATE PROTECTION OF WORK, MATERIALS, FIXTURES, ETC. IN LEASED SPACE FROM LOSS OR DAMAGE FROM FIRE, THEFT OR

4. ALL WORK SHALL BE DONE IN COMPLIANCE WITH THE OCCUPATIONAL SAFETY AND HEALTH ACT (OSHA). THE FOLLOWING ARE STRICTLY PROHIBITED WORK PRACTICES.

A. ANY COMBUSTIBLE MATERIALS ABOVE FINISHED CEILING OR IN ANY NON-SPRINKLED LOCATIONS.

B. IMPOSING ANY STRUCTURAL LOAD, TEMPORARY OR PERMANENT ON ANY PART OF THE LANDLORD'S WORK OR STRUCTURE WITHOUT PRIOR WRITTEN APPROVAL.

C. CUTTING ANY HOLES IN LANDLORD'S EXISTING FLOOR SLABS, WALLS OR ROOF WITHOUT PROPER APPROVAL'S PROPER APPROVALS FROM LANDLORD. BEFORE STARTING ANY UNDERSLAB WORK CONTRACTORS MUST CHECK WITH THE LANDLORD OR SUPERINTENDENT OF THE LANDLORD'S GENERAL CONTRACTOR TO DETERMINE IF ANY COMMON UTILITY OR OTHER TENANT UTILITY LINES EXIST WITHIN THE SPACE.

CODE COMPLIANCE:

1. WORK INDICATED IS TO BE EXECUTED IN ACCORDANCE WITH THE LATEST EDITIONS OF ALL APPLICABLE CODES.

2. FIRE EXTINGUISHERS SHALL BE PROVIDED BY G.C. AND INSTALLED PER THE FIRE MARSHALL'S INSTRUCTIONS.

3. ALL WALL FINISHES TO MEET CLASS III FLAME SPREAD RATINGS IN ACCORDANCE WITH MBC-2015 CHAPTER 8.

4. INTERIOR FINISHES IN EXIT ACCESS CORRIDORS, OTHER EXIT WAYS, ROOMS, AND ENCLOSED SPACES IN USE GROUPS "B" AND "S" IN SPRINKLED BUILDINGS ARE REQUIRED TO HAVE AT LEAST A CLASS C: FLAME SPREAD 76-200; SMOKE DEVELOPED 0-450; RATING AS LISTED IN THE 2015 MICHIGAN BUILDING CODE.

5. SAFETY GLAZING MUST HAVE PERMANENT IDENTIFICATION IN ACCORDANCE WITH THE 2015 MICHIGAN BUILDING CODE. 6. ALL REQUIREMENTS OF THE MICHIGAN BARRIER FREE ACT & THE AMERICAN'S WITH DISABILITIES ACT SHALL BE MAINTAINED TO

7. ALL OFFICE FURNITURE & EQUIPMENT TO BE PROVIDED BY TENANT- SHOWN FOR LAYOUT PURPOSES ONLY. TO COMPLY WITH ADA-ICC/A117.1-2009 (TYP.) REQUIREMENTS, A MINIMUM OF 5%, BUT NOT LESS THAN (1) OF THE LUNCHROOM TABLES AND EMPLOYEE WORKSTATIONS (CUBICLES) SHALL BE ACCESSIBLE. ACCESSIBLE TABLE AND WORKSTATION TOPS SHALL BE 28" MIN. TO 34" MAX. A.F.F. KNEE AND TOE CLEARANCES AS FOLLOWS SHALL ALSO APPLY- TOE: 4" MIN. HIGH, 17" MIN. TO 25" MAX. DEPTH, AND 30" MIN. WIDE. KNEE: 27" MIN. HIGH, 11" DEEP @ 9" HIGH TO 8" DEEP @ 27" HIGH, AND 30" MIN. WIDE.


8. ALL ENTRANCE AND EXIT DOORS SHALL HAVE BARRIER FREE ACCESSIBILITY TO COMPLY WITH ICC/A117.1-2009.

9. TO COMPLY WITH ADA - ICC/A117.1-2009 (TYP.) REQUIREMENTS, CHANGES IN LEVEL GREATER THAN 1/2" SHALL BE RAMPED AND CHANGES IN LEVEL BETWEEN 1/4" AND 1/2" SHALL BE BEVELED A MAXIMUM OF 1:2.

10. ALL LUNCHROOM APPLIANCES TO BE PROVIDED BY TENANT. TO COMPLY WITH ADA-ICC/A117.1-2009 (TYP.) REQUIREMENTS, DISHWASHERS MUST FIT UNDER A 34" HIGH (32 1/4" CLEAR UNDER) COUNTERTOP, THE REFRIGERATOR MUST BE A SIDE-BY-SIDE OR BOTTOM FREEZER UNIT, AND ALL MICROWAVE CONTROLS TO BE NO HIGHER THAN 46" A.F.F. TO MEET OBSTRUCTED HIGH SIDE REACH

11. SIGNAGE INDICATING ACCESSIBILITY PROVISIONS SHALL BE PROVIDED AT EACH DOOR TO AN EXIT DISCHARGE. A TACTILE SIGN STATING EXIT AND COMPLYING WITH ICC/ANSI A117.1-2009 SHALL BE PLACED ADJACENT TO THE DOOR. PLEASE REFER TO SHEET A. 601 FOR ADDITIONAL INFORMATION AND LOCATION.

THE BUILDING IS PROVIDED WITH A FULL AUTOMATIC FIRE PROTECTION SPRINKLER SYSTEM (FIRE SUPPRESSION SYSTEM) WHICH WILL BE DESIGNED TO MEET M.B.C. REQUIREMENTS AND CITY OF BIRMINGHAM INSPECTION AND PERMIT APPROVAL. SPRINKLER CONTRACTOR SHALL BE FULLY LICENSED AND BE RESPONSIBLE FOR PREPARATION OF ENGINEERING DRAWING, SUBMISSION OF DRAWINGS TO ALL LOCAL AND STATE AGENCIES FOR APPROVAL, AND FOR COORDINATION OF REQUIREMENTS WITH OWNERS AND TENANTS INSURANCE CARRIER.

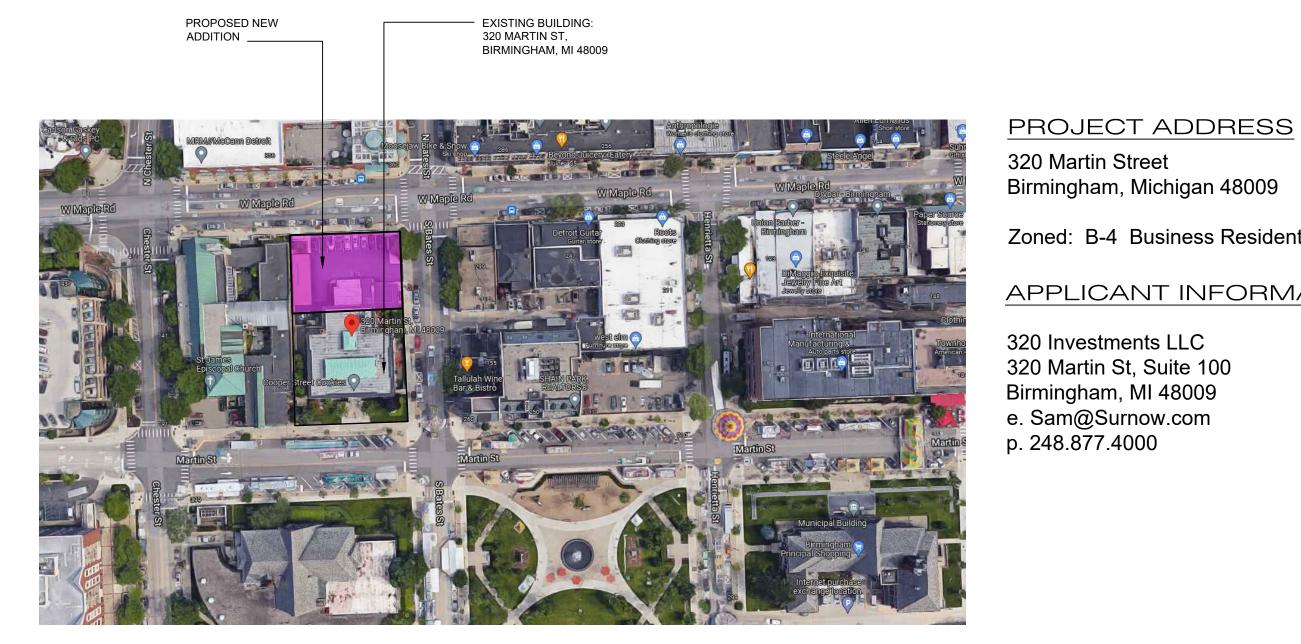





320 Martin Street Birmingham, Michigan 48009

Zoned: B-4 Business Residential

APPLICANT INFORMATION

320 Investments LLC 320 Martin St. Suite 100 Birmingham, MI 48009 e. Sam@Surnow.com p. 248.877.4000

SHEET INDEX

TITLE SHEET

SP.100	EXISTING CONDITIONS & SITE SURROUNDINGS
SP.101	SITE PLAN
A.101	FLOOR PLANS
A.102	FLOOR PLANS
A.103	FLOOR PLANS
A.201	ELEVATIONS
A.202	ELEVATIONS
A.301	3D PERSPECTIVE IMAGE
A.302	3D PERSPECTIVE IMAGE
A.303	3D PERSPECTIVE IMAGE
A.304	3D PERSPECTIVE IMAGE
A.305	3D PERSPECTIVE IMAGE
A.306	3D PERSPECTIVE IMAGE
A.307	3D PERSPECTIVE IMAGE
A.308	3D PERSPECTIVE IMAGE
A.309	3D PERSPECTIVE IMAGE
A.310	3D PERSPECTIVE IMAGE
A.311	3D PERSPECTIVE IMAGE
A.312	3D PERSPECTIVE IMAGE
A.313	3D PERSPECTIVE IMAGE
A.314	3D PERSPECTIVE IMAGE

biddison architecture + design

320 Martin Street Suite 10 Birmingham, MI 48009 t:248.554.9500

Contact Person: Kevin Biddison e.mail: kb@biddison-ad.com

Consultants

Project data

GOVERNING CODES:

2015 MICHIGAN BUILDING CODE 2015 MICHIGAN PLUMBING CODE 2015 MICHIGAN MECHANICAL CODE 2015 MICHIGAN REHABILITATION CODE 2015 INTERNATIONAL FUEL GAS CODE MICHIGAN ELECTRICAL CODE, 2014 N.E.C. W/ PART 8 STATE AMENDMENTS ICC/ANSI A117.1-2015 AND MICHIGAN BARRIER FREE DESIGN LAW OF PUBLIC ACT 1 OF 1966 AS AMENDED. MICHIGAN UNIFORM ENERGY CODE RULES PART 10 WITH ANSI/ASHRAE/IESNA STANDARD 90.1-2015 2015 INTERNATIONAL FIRE CODE NFPA 13 - 2010

BUILDING USE GROUP(S):

GENERAL BUSINESS & RESIDENTIAL

TYPE OF CONSTRUCTION: 2015 MBC: 2B (UN-PROTECTED) NFPA 220: TYPE II-000

NFPA 13: 2010 NFPA 72: 2010

UNDERGROUND GARAGE AREA: FIRST FLOOR AREA: SECOND FLOOR AREA:

THIRD FLOOR AREA:

FIFTH FLOOR AREA:

8,058 SQFT 9,248 SQFT 9,000 SQFT 10,200 SQFT FOURTH FLOOR AREA: 10,200 SQFT

6,200 SQFT


NFPA 72 - 2010

TOTAL ADDITION AREA:

52,906 SQFT

HISTORIC DESIGN BOARD REVIEW HISTORIC DESIGN BOARD REVIEW 01.24.2022 03.09.2022

Issued for

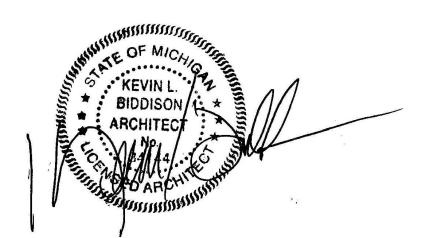


Project no.

BIRMINGHAM P.O. ADDITION


2075-21

Sheet no.


T.101

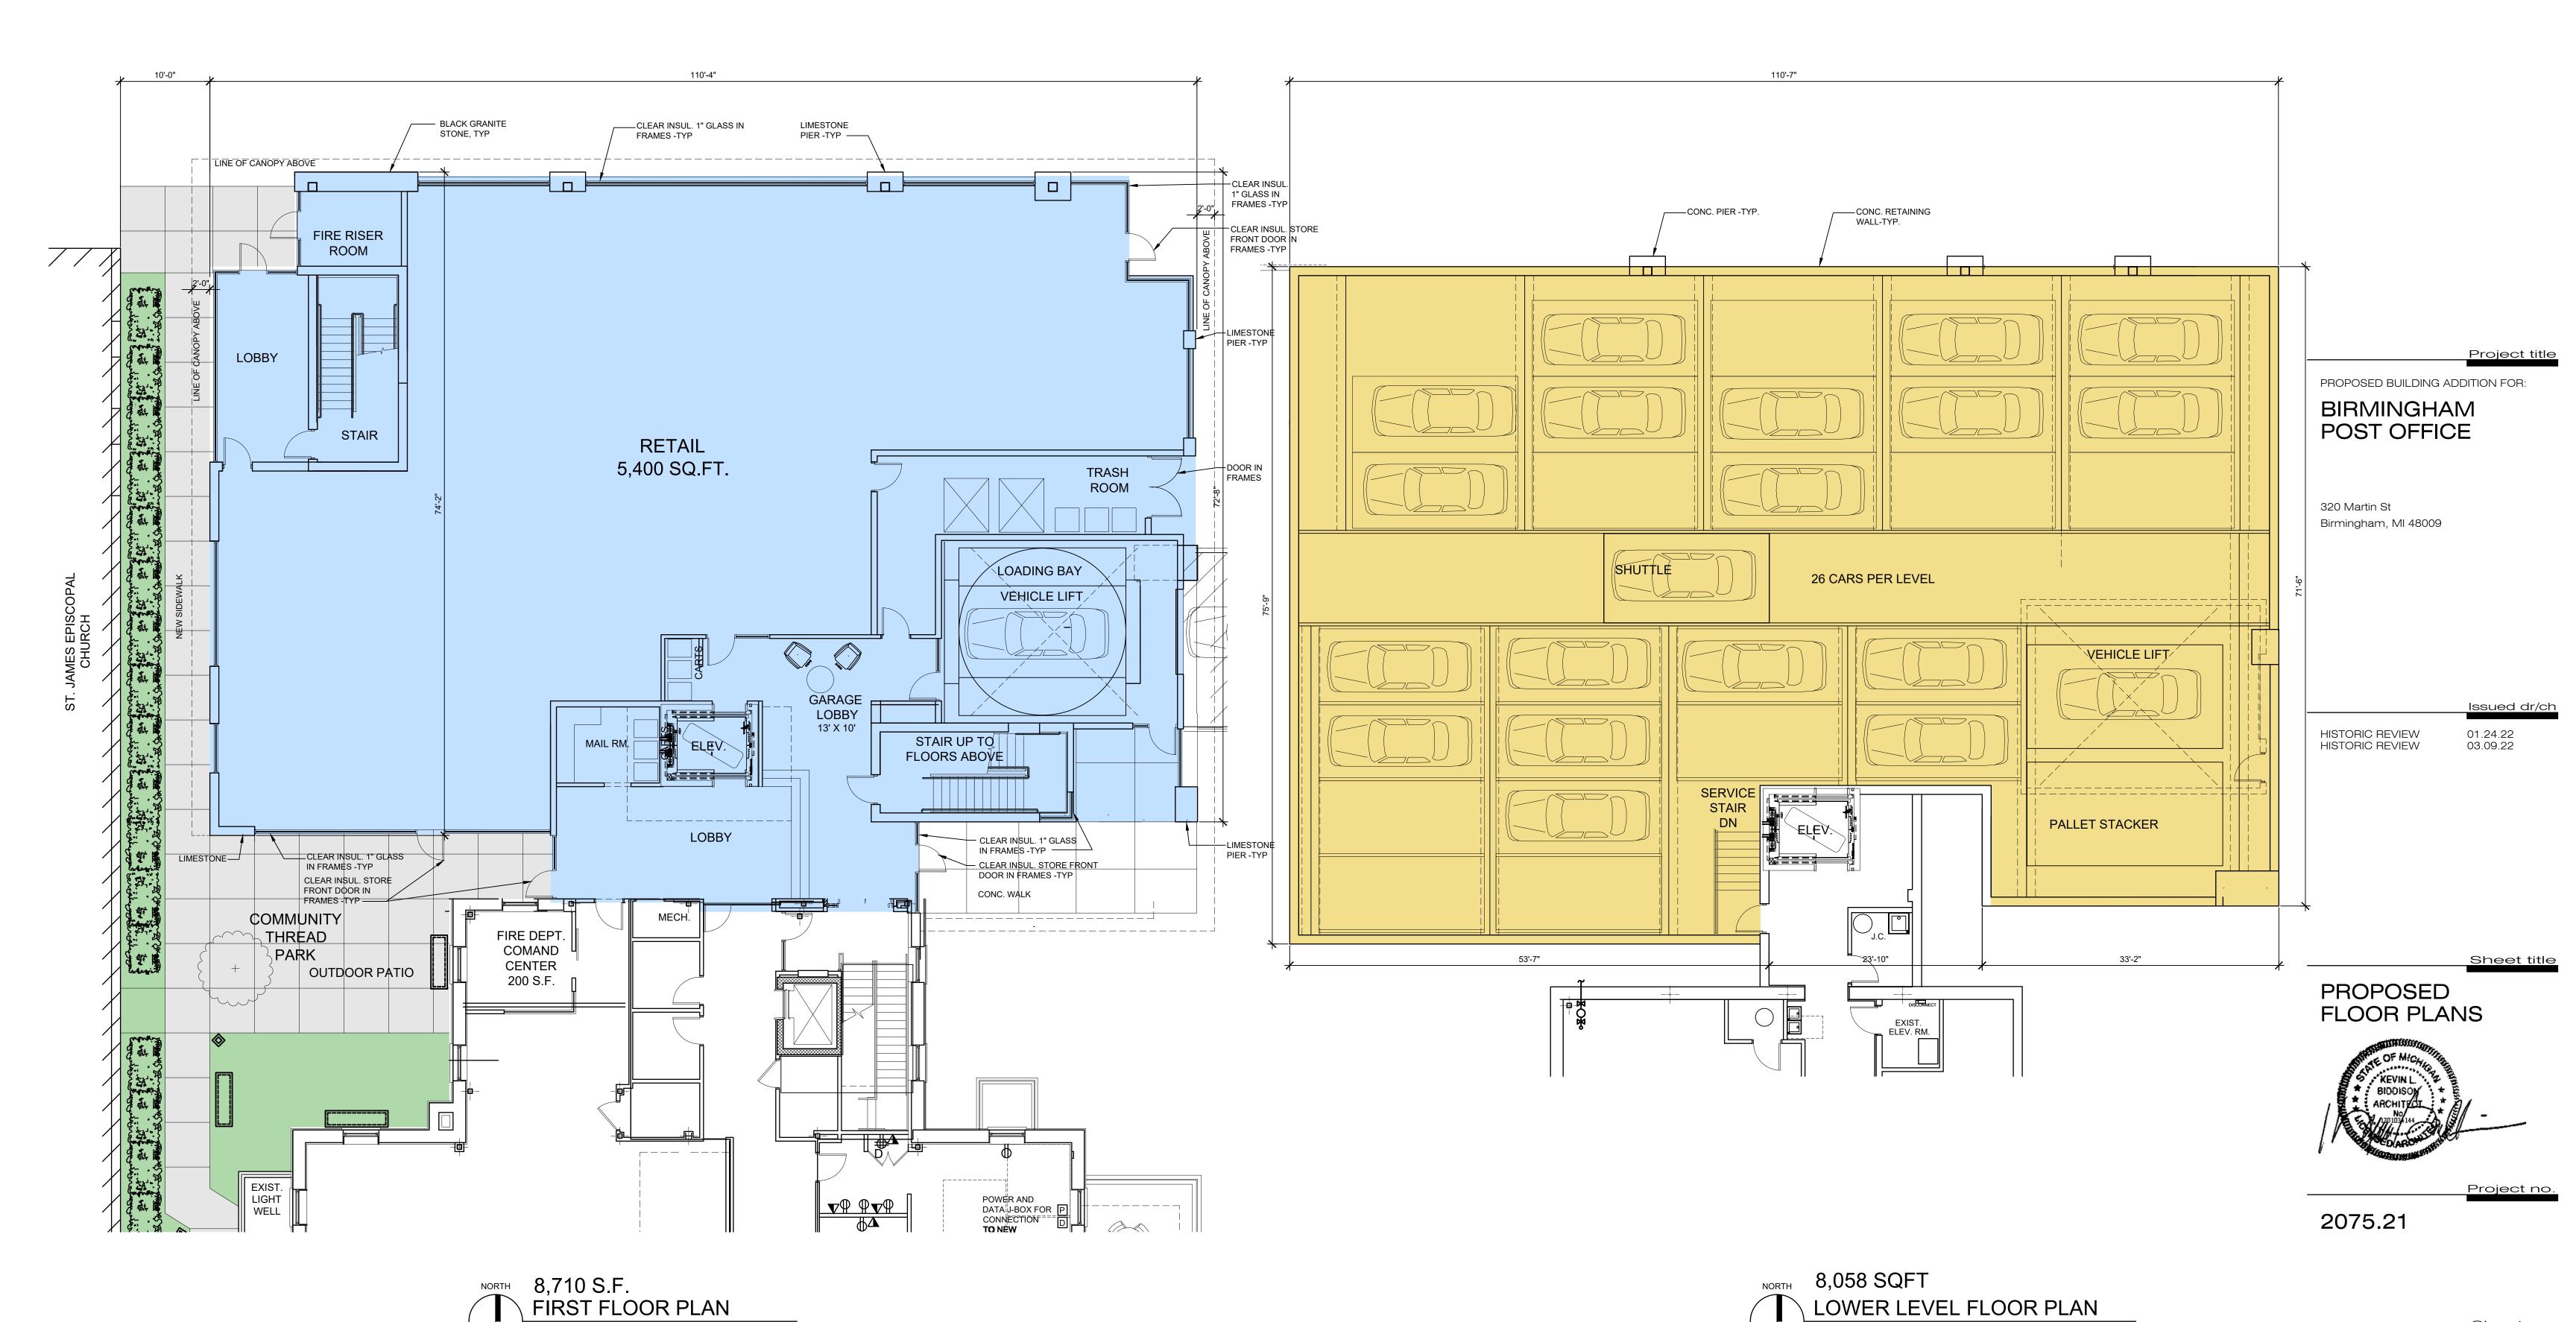

SCALE: 1/8"=1'-0"

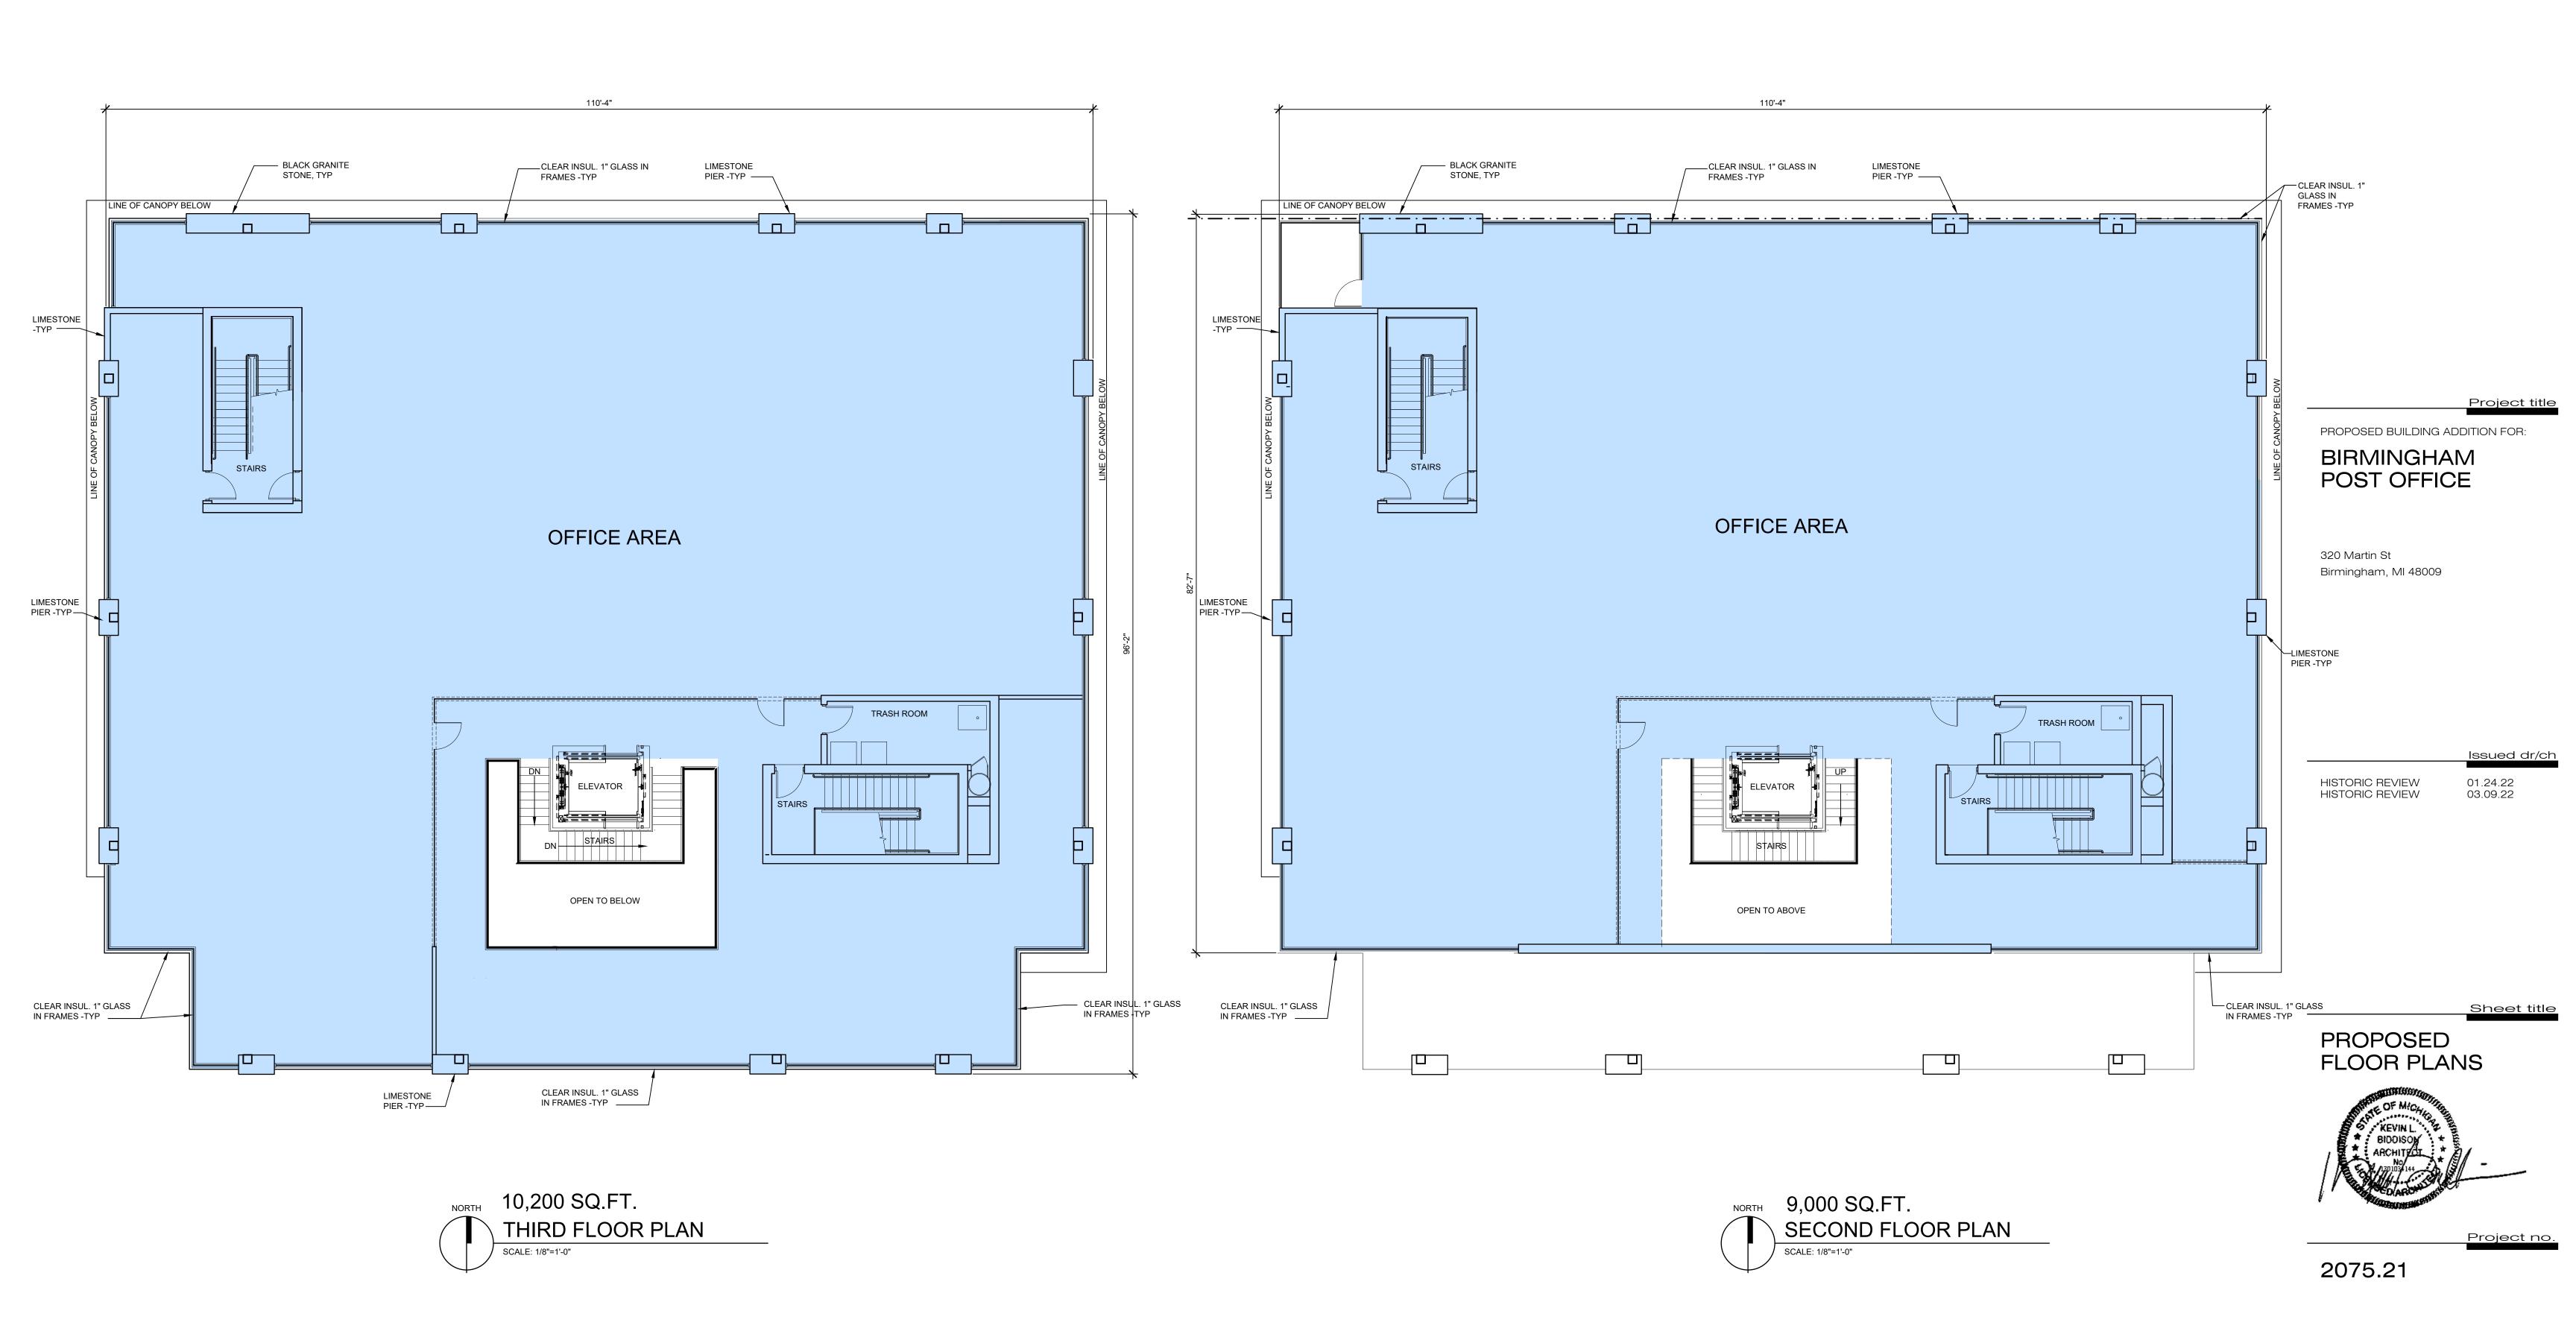

A.102

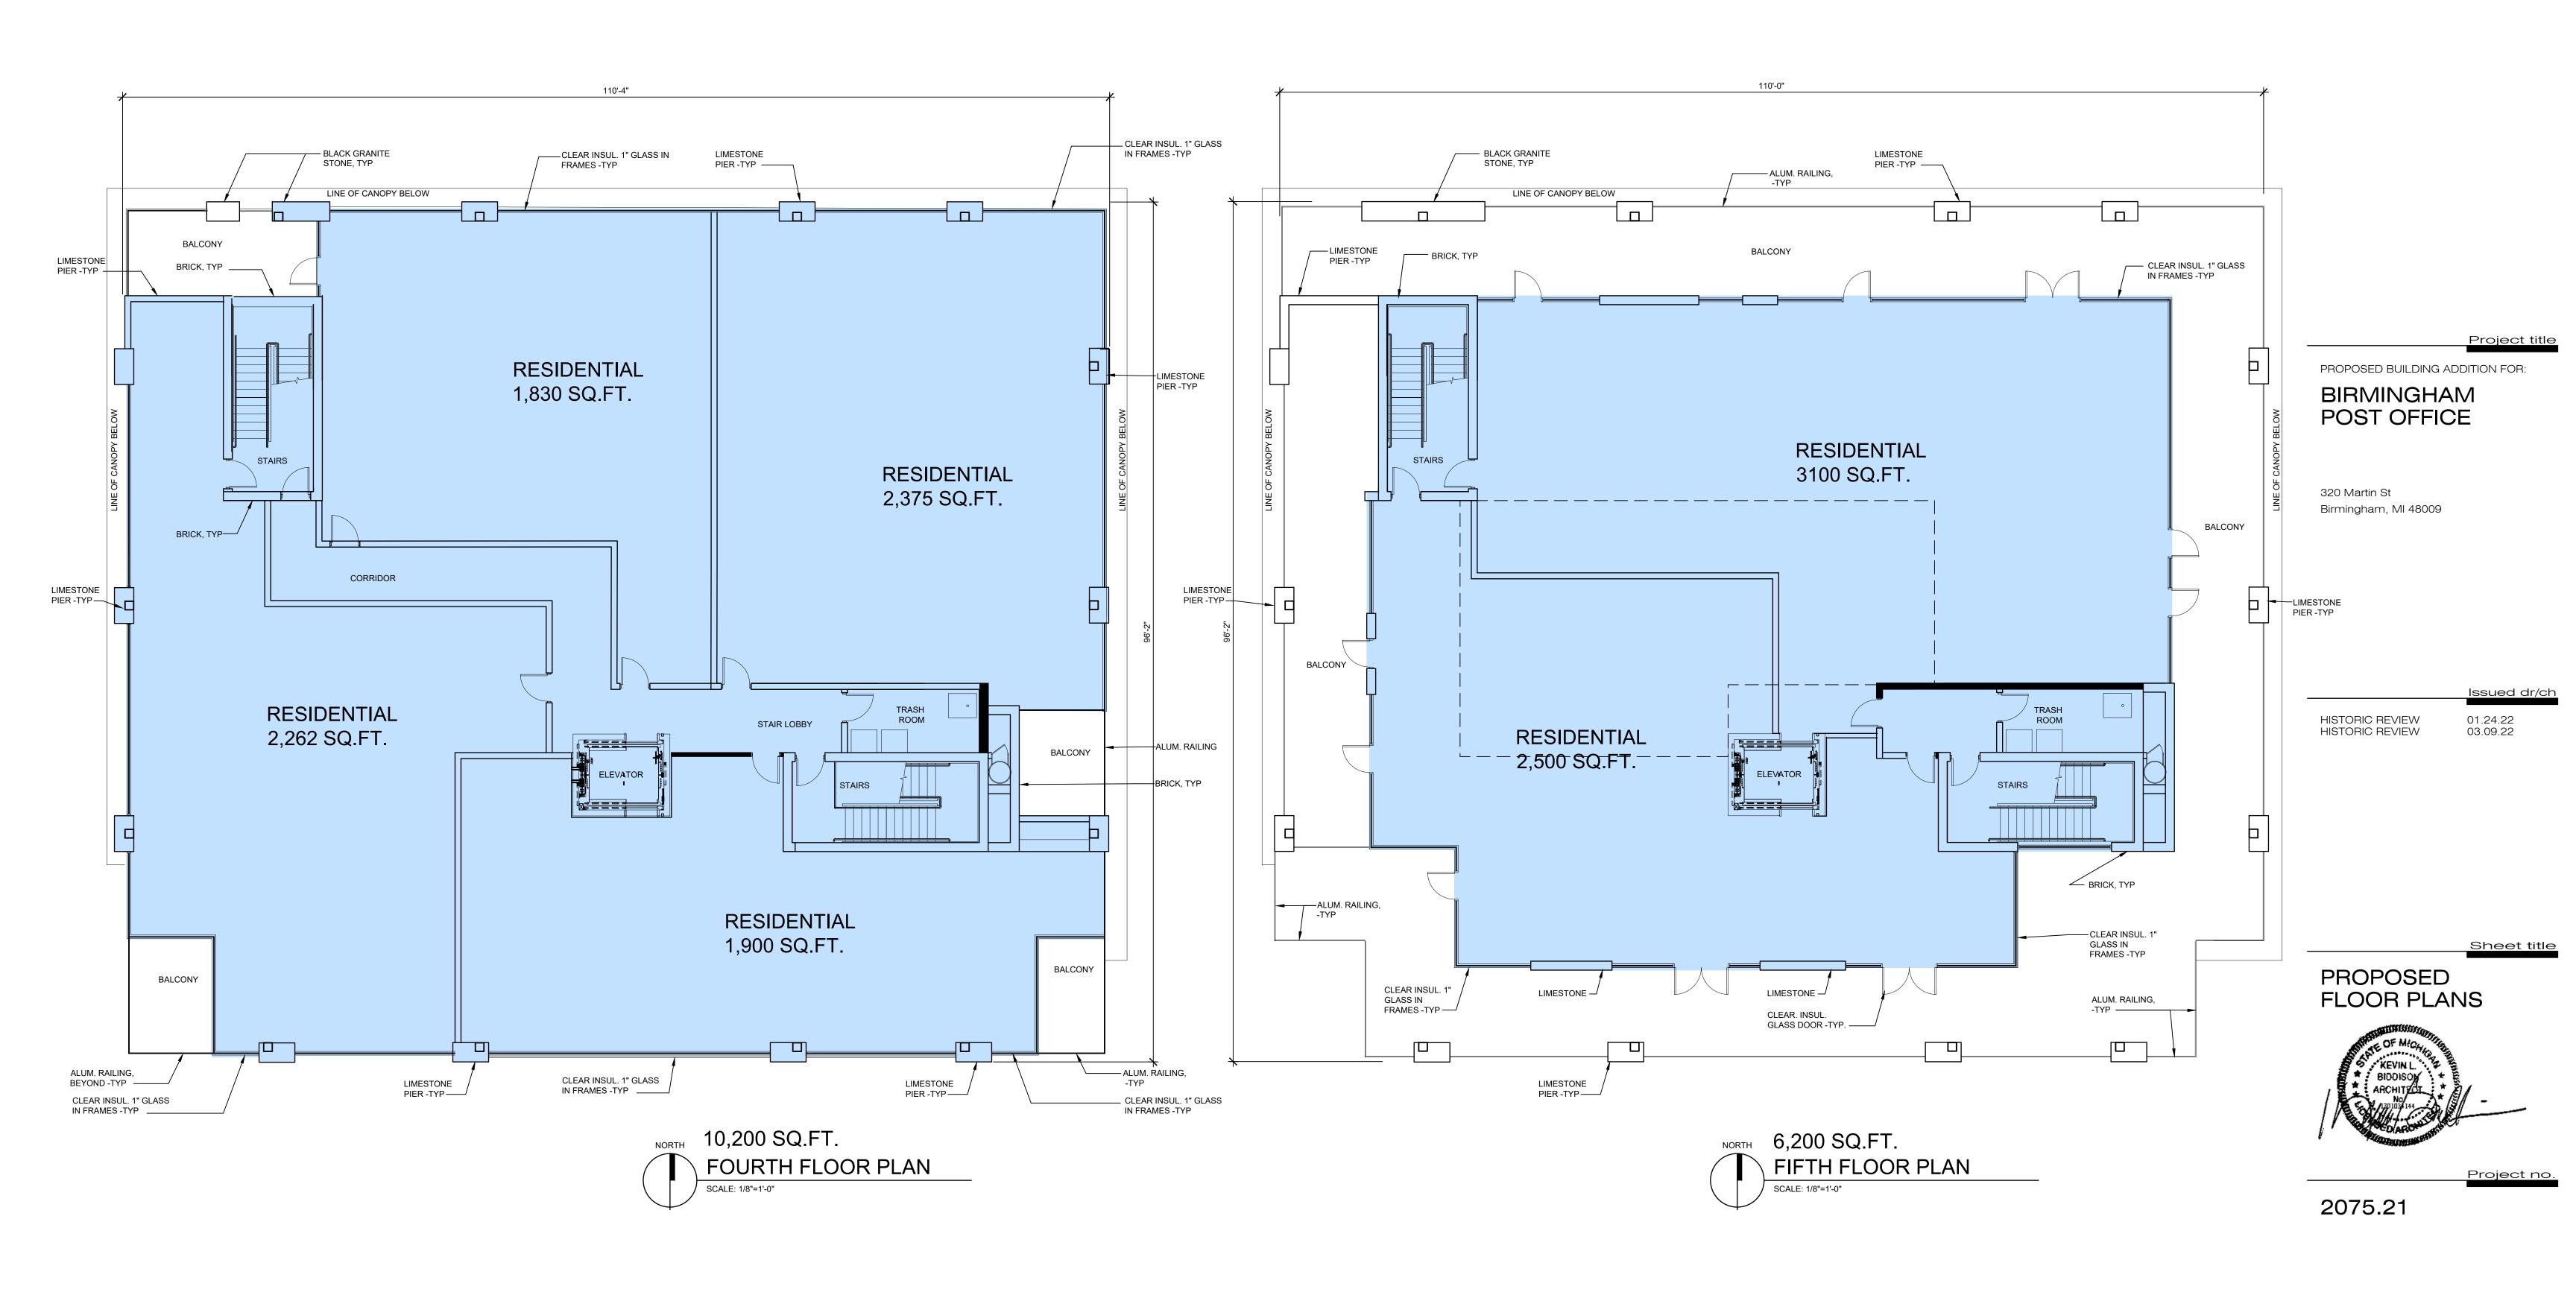



biddison

architecture + design 320 Martin St. Suite 10 Birmingham, MI 48009 t:248.554.9500


Consultants

Project title

PROPOSED BUILDING ADDITION FOR:

BIRMINGHAM POST OFFICE

320 Martin St Birmingham, MI 48009

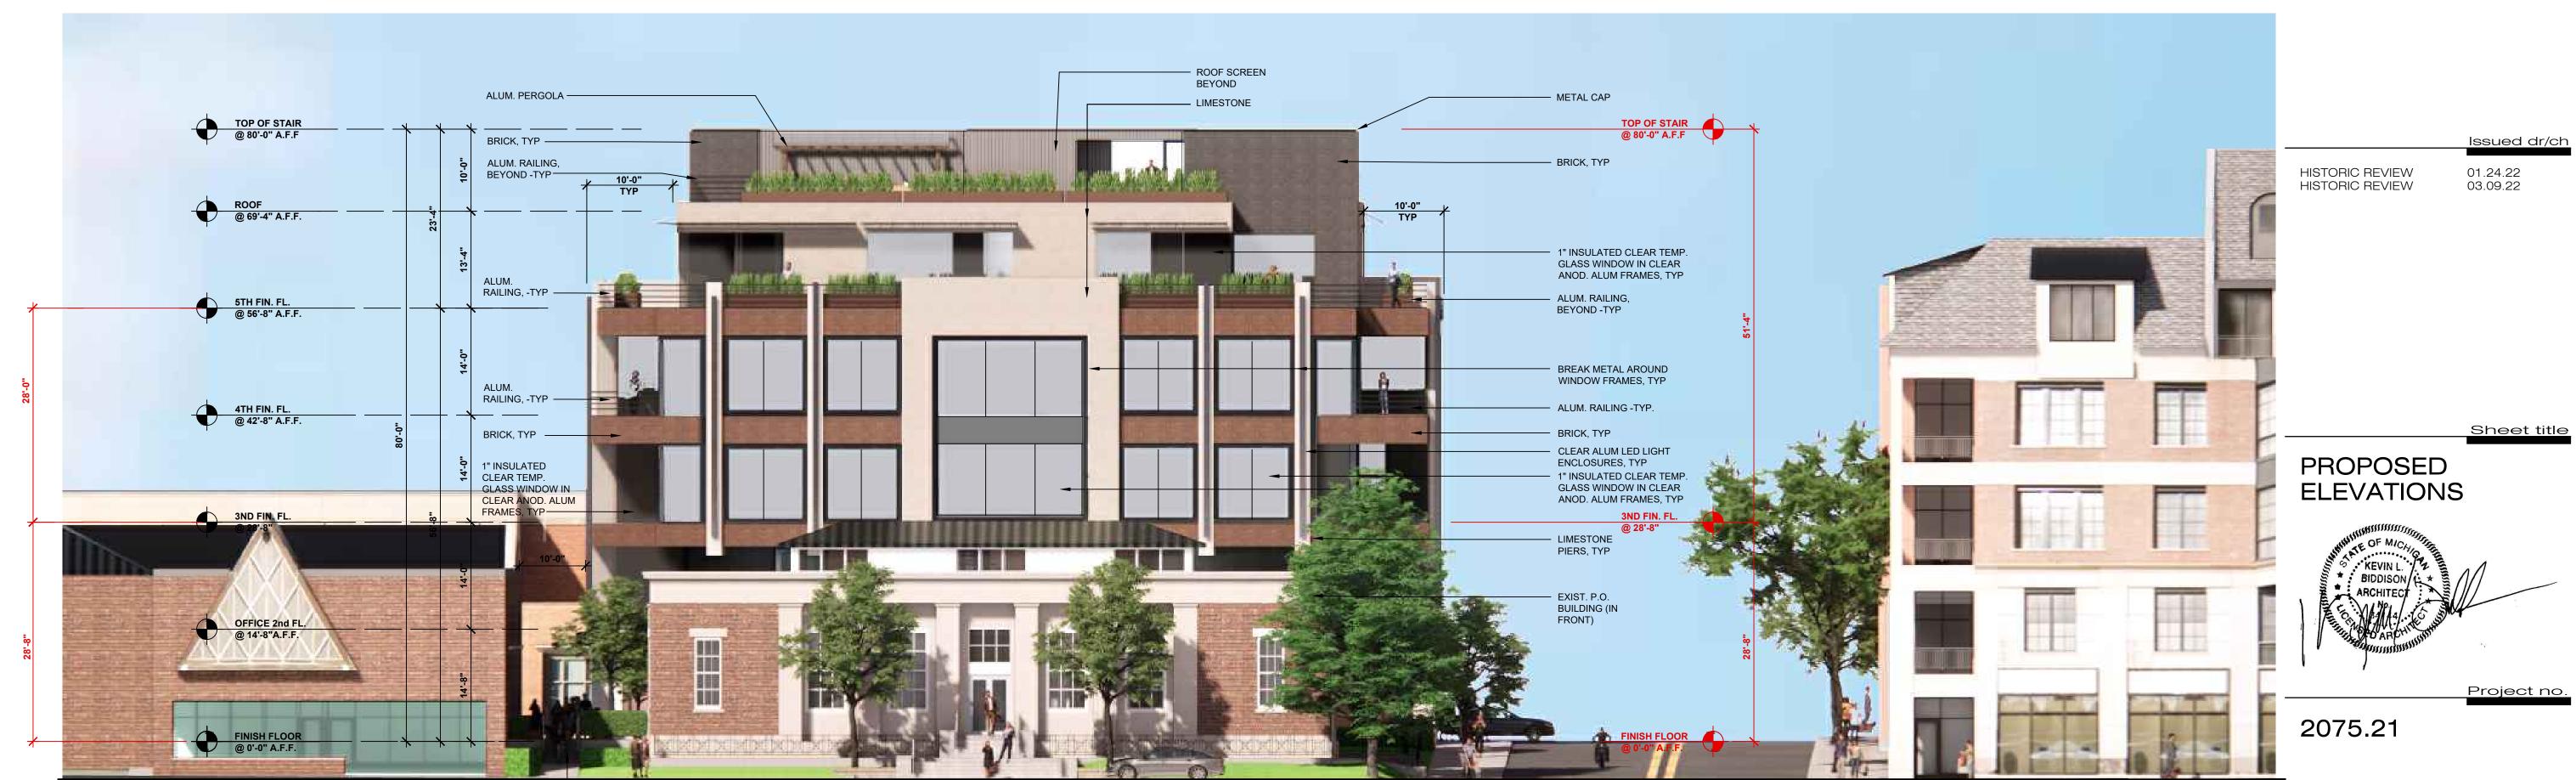

COMMUNITY
THREAD PARK







PROPOSED BUILDING ADDITION FOR:

BIRMINGHAM POST OFFICE

320 Martin St Birmingham, MI 48009

HISTORIC REVIEW

01.24.22 03.09.22

PROPOSED 3D IMAGES





biddison architecture + design 320 Martin St. Suite 10 Birmingham, MI 48009 t:248.554.9500

Consultants

PROPOSED BUILDING ADDITION FOR:


BIRMINGHAM POST OFFICE

320 Martin St Birmingham, MI 48009

01.24.22 03.09.22

HISTORIC REVIEW HISTORIC REVIEW

PROPOSED 3D IMAGES

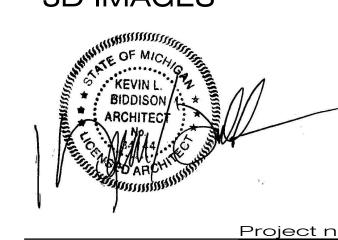



biddison architecture + design 320 Martin St. Suite 10 Birmingham, MI 48009 t:248.554.9500

Consultants

PROPOSED BUILDING ADDITION FOR:

BIRMINGHAM POST OFFICE

320 Martin St Birmingham, MI 48009

01.24.22 03.09.22

HISTORIC REVIEW HISTORIC REVIEW

Sheet title

PROPOSED 3D IMAGES





biddison architecture + design

320 Martin St. Suite 10 Birmingham, MI 48009 t:248.554.9500

PROPOSED BUILDING ADDITION FOR:

BIRMINGHAM POST OFFICE

320 Martin St Birmingham, MI 48009

HISTORIC REVIEW HISTORIC REVIEW

01.24.22 03.09.22

Sheet title

PROPOSED 3D IMAGES







PROPOSED BUILDING ADDITION FOR:


BIRMINGHAM POST OFFICE

320 Martin St Birmingham, MI 48009

HISTORIC REVIEW HISTORIC REVIEW

01.24.22 03.09.22

PROPOSED 3D IMAGES

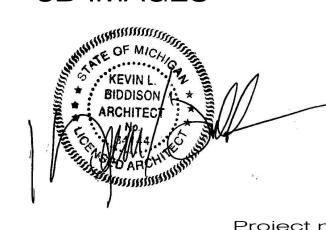



PROPOSED BUILDING ADDITION FOR:

BIRMINGHAM POST OFFICE

320 Martin St Birmingham, MI 48009

HISTORIC REVIEW HISTORIC REVIEW 01.24.22 03.09.22

PROPOSED 3D IMAGES



2075.21

PHOTOGRAPH - VIEW FROM LIBRARY

A.302 NO SCALE




303.03 MAPLE ENTRY TO COMMUNITY THREAD PARK
A.303 NO SCALE

PROPOSED BUILDING ADDITION FOR: BIRMINGHAM POST OFFICE

320 Martin St Birmingham, MI 48009

HISTORIC REVIEW HISTORIC REVIEW 01.24.22 03.09.22

Sheet title PROPOSED 3D IMAGES

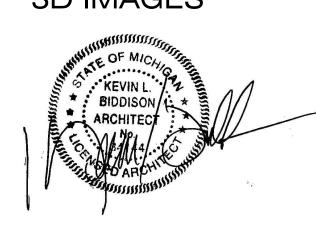





303.01 3D VIEW - COMMUNITY THREAD PARK
A.303 NO SCALE

PROPOSED BUILDING ADDITION FOR:
BIRMINGHAM
POST OFFICE

320 Martin St Birmingham, MI 48009


HISTORIC REVIEW 01.24.22 HISTORIC REVIEW 03.09.22

PROPOSED 3D IMAGES



2075.21

Sheet n

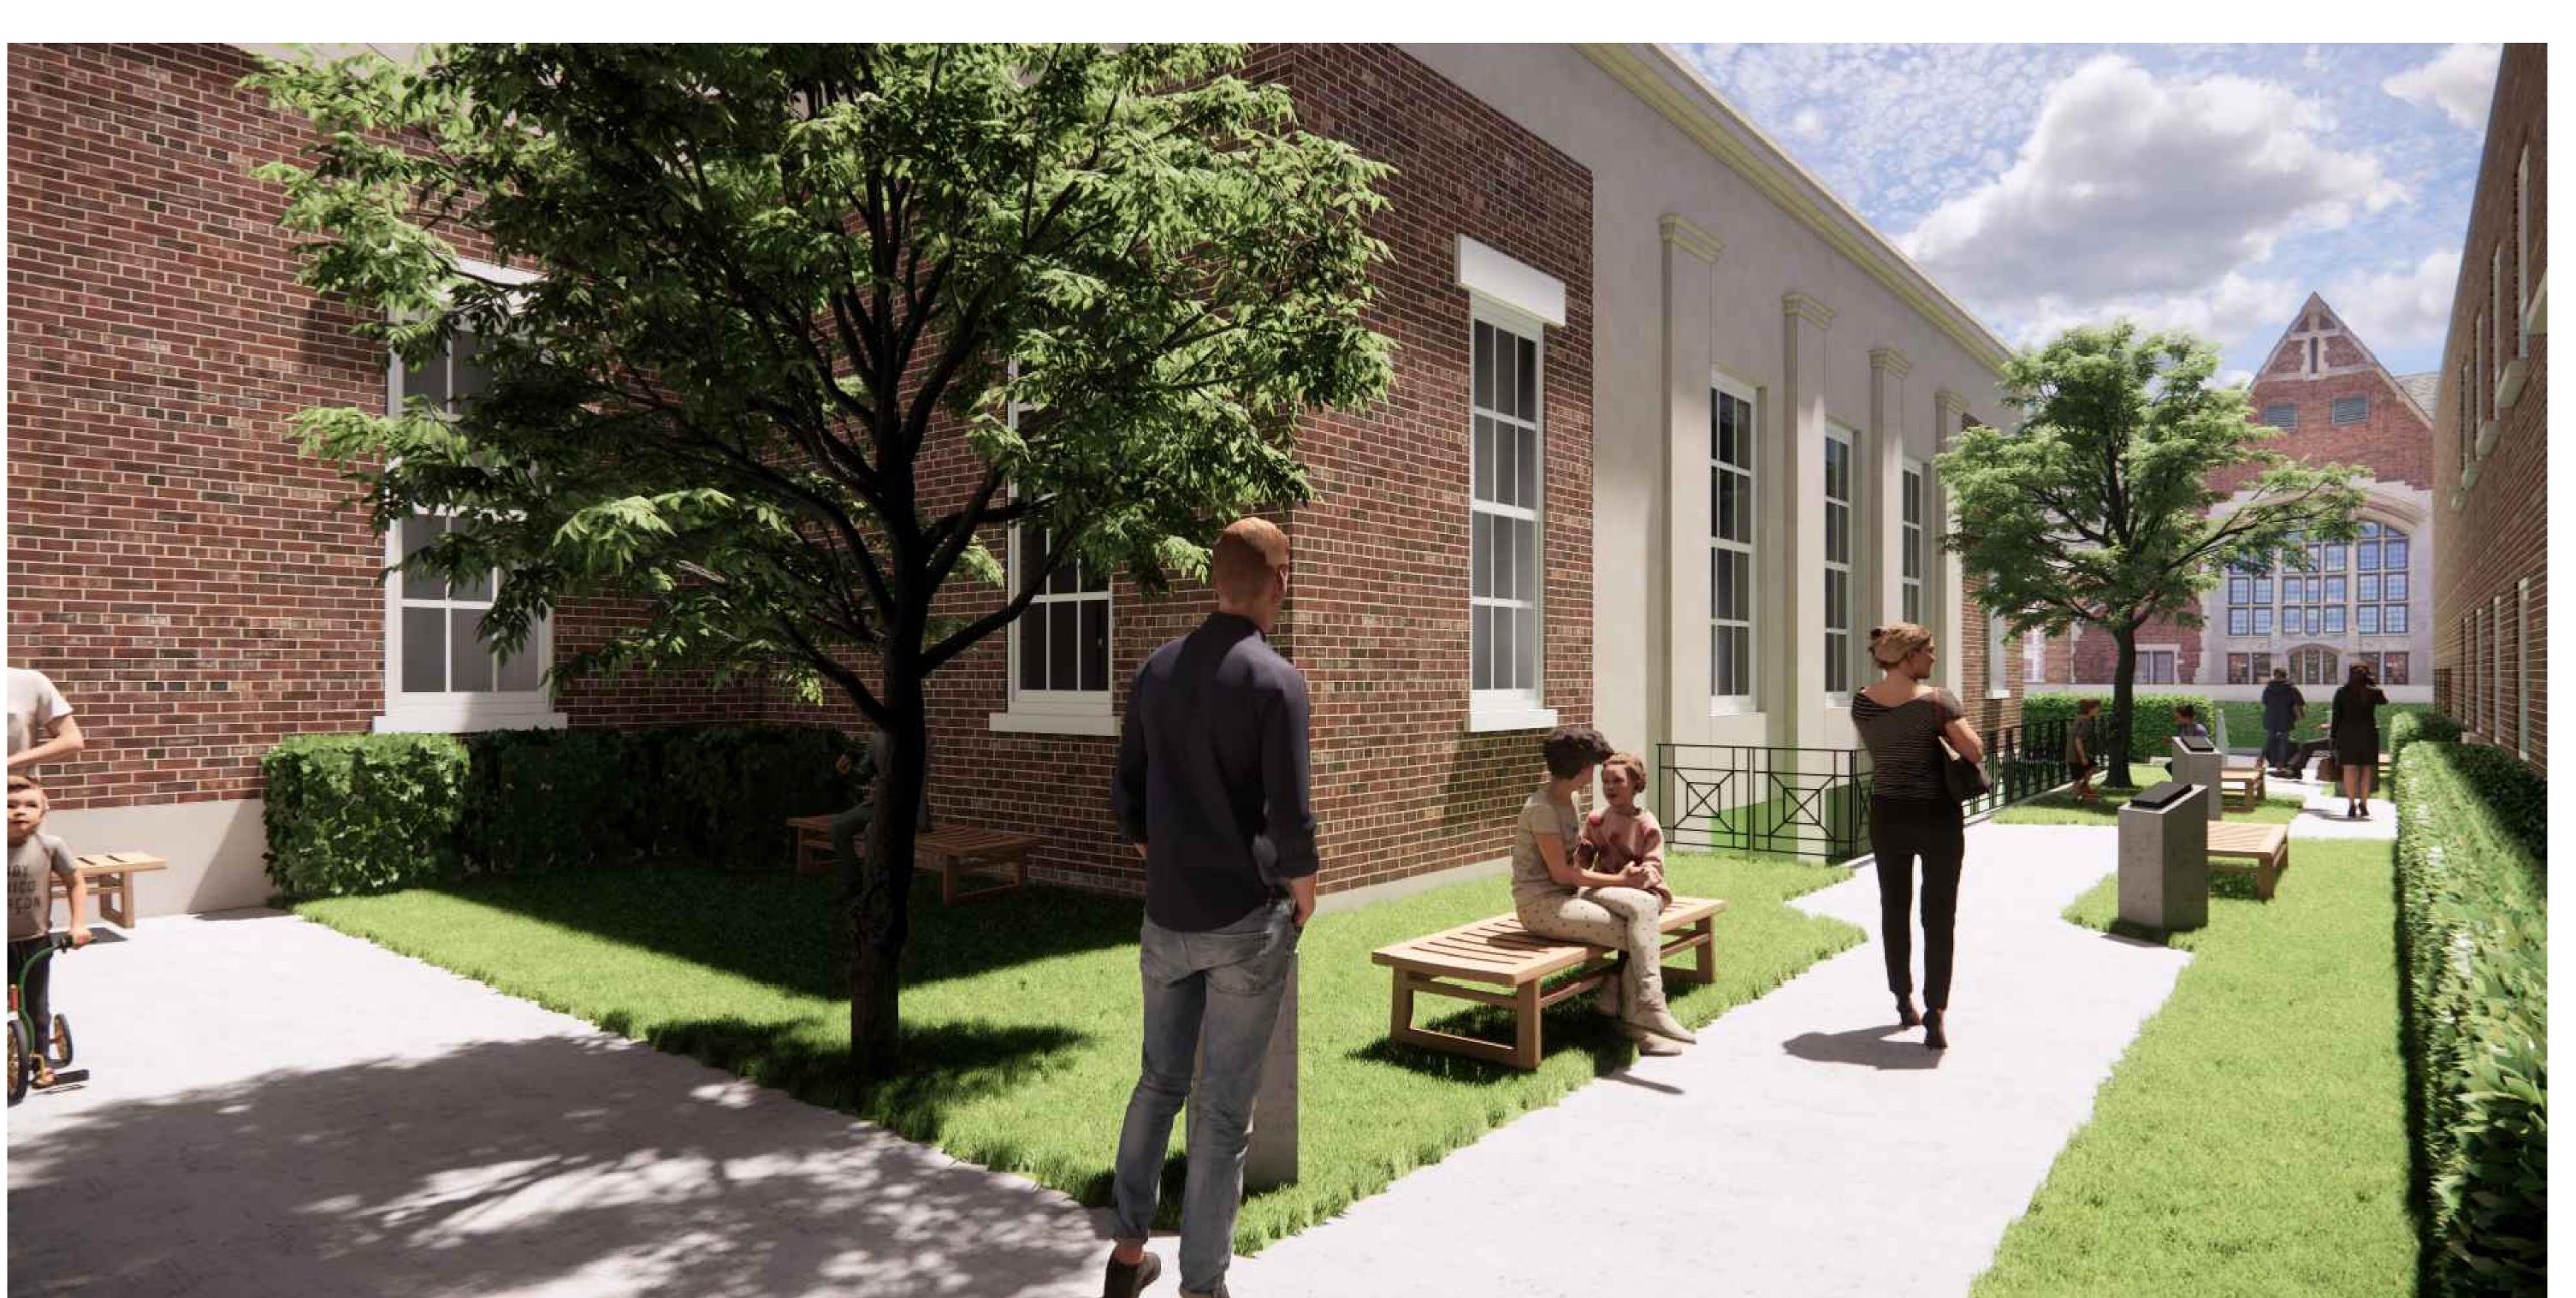

COMMUNITY THREAD PARK LIBRARY IN VIEW A.303 NO SCALE

PROPOSED BUILDING ADDITION FOR: BIRMINGHAM POST OFFICE

320 Martin St

Birmingham, MI 48009

HISTORIC REVIEW HISTORIC REVIEW 01.24.22 03.09.22

Sheet title PROPOSED 3D IMAGES






Project title
PROPOSED BUILDING ADDITION FOR:

BIRMINGHAM POST OFFICE

320 Martin St Birmingham, MI 48009

HISTORIC REVIEW 01.24.22 HISTORIC REVIEW 03.09.22

Sheet ti

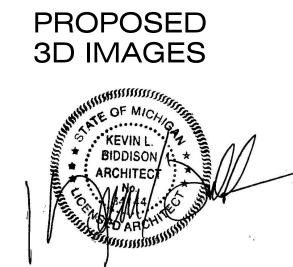

Project

2075.21

OMMUNITY THREAD PARK - MARTIN STREET

A.304 NO SCALE

Sheet n




PROPOSED BUILDING ADDITION FOR:

BIRMINGHAM POST OFFICE

320 Martin St Birmingham, MI 48009

HISTORIC REVIEW HISTORIC REVIEW 01.24.22 03.09.22

PROPOSED 3D IMAGES

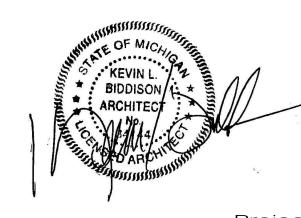

2075.21

PROPOSED 3D IMAGES- MARTIN ST. SIDEWALK

A.304 NO SCALE




PROPOSED BUILDING ADDITION FOR:

BIRMINGHAM POST OFFICE

320 Martin St Birmingham, MI 48009

HISTORIC REVIEW HISTORIC REVIEW 01.24.22 03.09.22

PROPOSED 3D IMAGES

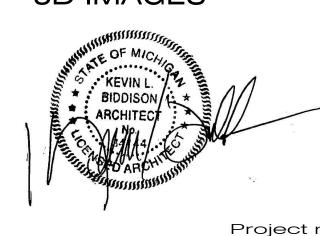

PROPOSED 3D IMAGE - EAST SIDE OF BATES

A.304 NO SCALE




304.03 SE CORNER BATES & MARTIN A.304 NO SCALE

PROPOSED BUILDING ADDITION FOR: BIRMINGHAM POST OFFICE

320 Martin St Birmingham, MI 48009

HISTORIC REVIEW HISTORIC REVIEW 01.24.22 03.09.22

PROPOSED 3D IMAGES

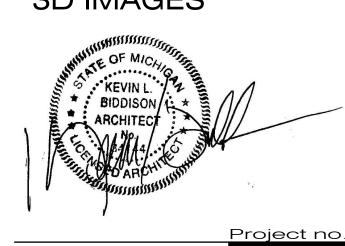



AGENDA BIRMINGHAM HISTORIC DISTRICT COMMISSION WEDNESDAY – DECEMBER 21, 2022 BIRMINGHAM CITY HALL, 151 MARTIN STREET, COMMISSION ROOM 205, BIRMINGHAM, MI*

The City recommends members of the public wear a mask if they have been exposed to COVID-19 or have a respiratory illness. City staff, City Commission and all board and committee members must wear a mask if they have been exposed to COVID-19 or actively have a respiratory illness. The City continues to provide KN-95 respirators and triple layered masks for attendees.

- 1) Roll Call
- 2) Approval of the HDC Minutes of December 7, 2022
- 3) Courtesy Review
- 4) Historic Design Review
- 5) Sign Review
- 6) Study Session
 - A. Historic Design Guidelines Deliverable #2
- 7) Miscellaneous Business and Communication
 - A. Pre-Application Discussions
 - **B.** Draft Agenda
 - 1. January 4, 2023
 - C. Staff Reports
 - 1. Administrative Sign Approvals
 - 2. Administrative Approvals
 - 3. Demolitions
 - 4. Action List 2022
- 8) Adjournment

*Please note that board meetings will be conducted in person once again. Members of the public can attend in person at Birmingham City Hall, 151 Martin St., or may attend virtually at:

Link to Access Virtual Meeting: https://zoom.us/j/91282479817
Telephone Meeting Access: 877 853 5247 US Toll-free

Meeting ID Code: 912 8247 9817

Notice: Individuals requiring accommodations, such as interpreter services for effective participation in this meeting should contact the City Clerk's Office at (248) 530-1880 at least on day in advance of the public meeting.

Las personas que requieren alojamiento, tales como servicios de interpretación, la participación efectiva en esta reunión deben ponerse en contacto con la Oficina del Secretario Municipal al (248) 530-1880 por lo menos el día antes de la reunión pública. (Title VI of the Civil Rights Act of 1964).

A PERSON DESIGNATED WITH THE AUTHORITY TO MAKE DECISIONS MUST BE PRESENT AT THE MEETING.

Historic District Commission Action List – 2022-2023

Historic District Commission	Quarter Goals	In Progress	Complete
Schedule Training Sessions for HDC and Community	1 st (January-March)		
Draft Recommendations for Bates St. Historic District Signage	1st (January-March)		
Begin Historic Design Guidelines Project	2 nd (April-June)	\boxtimes	
Historic Plaque for Community House	2 nd (April-June)		
Develop Resources for the Michigan Historic Preservation Tax Credit	3 rd (July-September)		
Historic District Ordinance Enforcement	4 th (October-December)	\boxtimes	
First Draft – Historic Preservation Master Plan	4 th (October-December)		